

CIVIL DESIGN WORKS


- CIVIL ENGINEERING CONSULTANTS AND DESIGNERS WWW.CIVILDESIGNWORKS.COM

NEW YORK OFFICE (MAIN): 19 SQUADRON BLVD SUITE#4 NEW CITY · NEW YORK · 10956 OAKLAND · NEW JERSEY · 07436 TEL: 845-266-6441 TEL: 201 · 644 · 7530

PROJECT:

LEVESQUE PROPERTY RIVERVIEW AVENUE


TOWN OF ORANGETOWN ROCKLAND COUNTY, NEW YORK

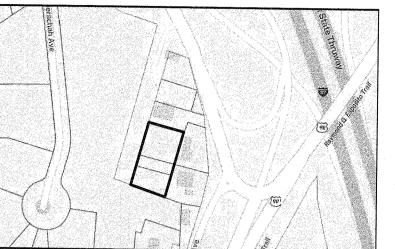

PROJECT LOCATION

APPLICANT: SHAWN LEVESQUE 14 SWAN STREET PALISADES, NY 10964

SURVEYOR:

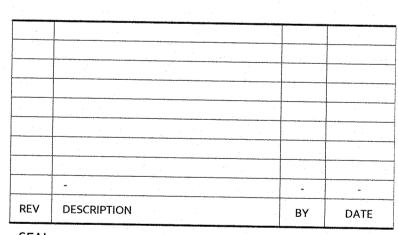



UNAUTHORIZED ALTERATION OR ADDITIONS TO THESE PLANS IS A VIOLATION OF THE N.Y.S. EDUCATION LAW, ARTICLE 145, SECTION 7209, SUBSECTION 2.

LEVESQUE PROPERTY RIVERVIEW AVENUE

1"=20'

SHEET TITLE:

SHEET NUMBER:

RE-SUBDIVISION PLAN

MEETING OF

24. A VARIANCE FOR AN EXCEPTION FROM THE PROVISIONS OF NEW YORK STATE TOWN LAW SECTION 280-a IS

THIS IS A SUBDIVSION AS DEFINED WITHIN THE TOWN OF ORANGETOWN ZONING REGULATIONS. THE PURPOSE OF THE SUBDIVISION IS TO ELIMINATE THE TAX LOT LINES AND MERGE THE THREE EXISTING LOTS INTO A

REQUESTED BY BY THE APPLICANT.

PLANNINGABEDARD SS | CHECKED BY: 12.20.23 | PROJECT NO:

SLOPE ANALYSIS MAP

DRIVEWAY

TOTAL:

AVERAGE ELEVATION OF EXISTING GRADE = (30,168)/(190) = 158.8

MAXIMUM BUILDING HEIGHT = (193.0) - (158.8) = 34.2 FEET

FIRST FLOOR ELEVATION = 169.5


PEAK ELEVATION OF ROOF = 193.0

481 SF

2,335 SF

LOT COVERAGE = (2,335)/(4,143) = 56.3%

MINIMUM LOT AREA = 4,143 SF

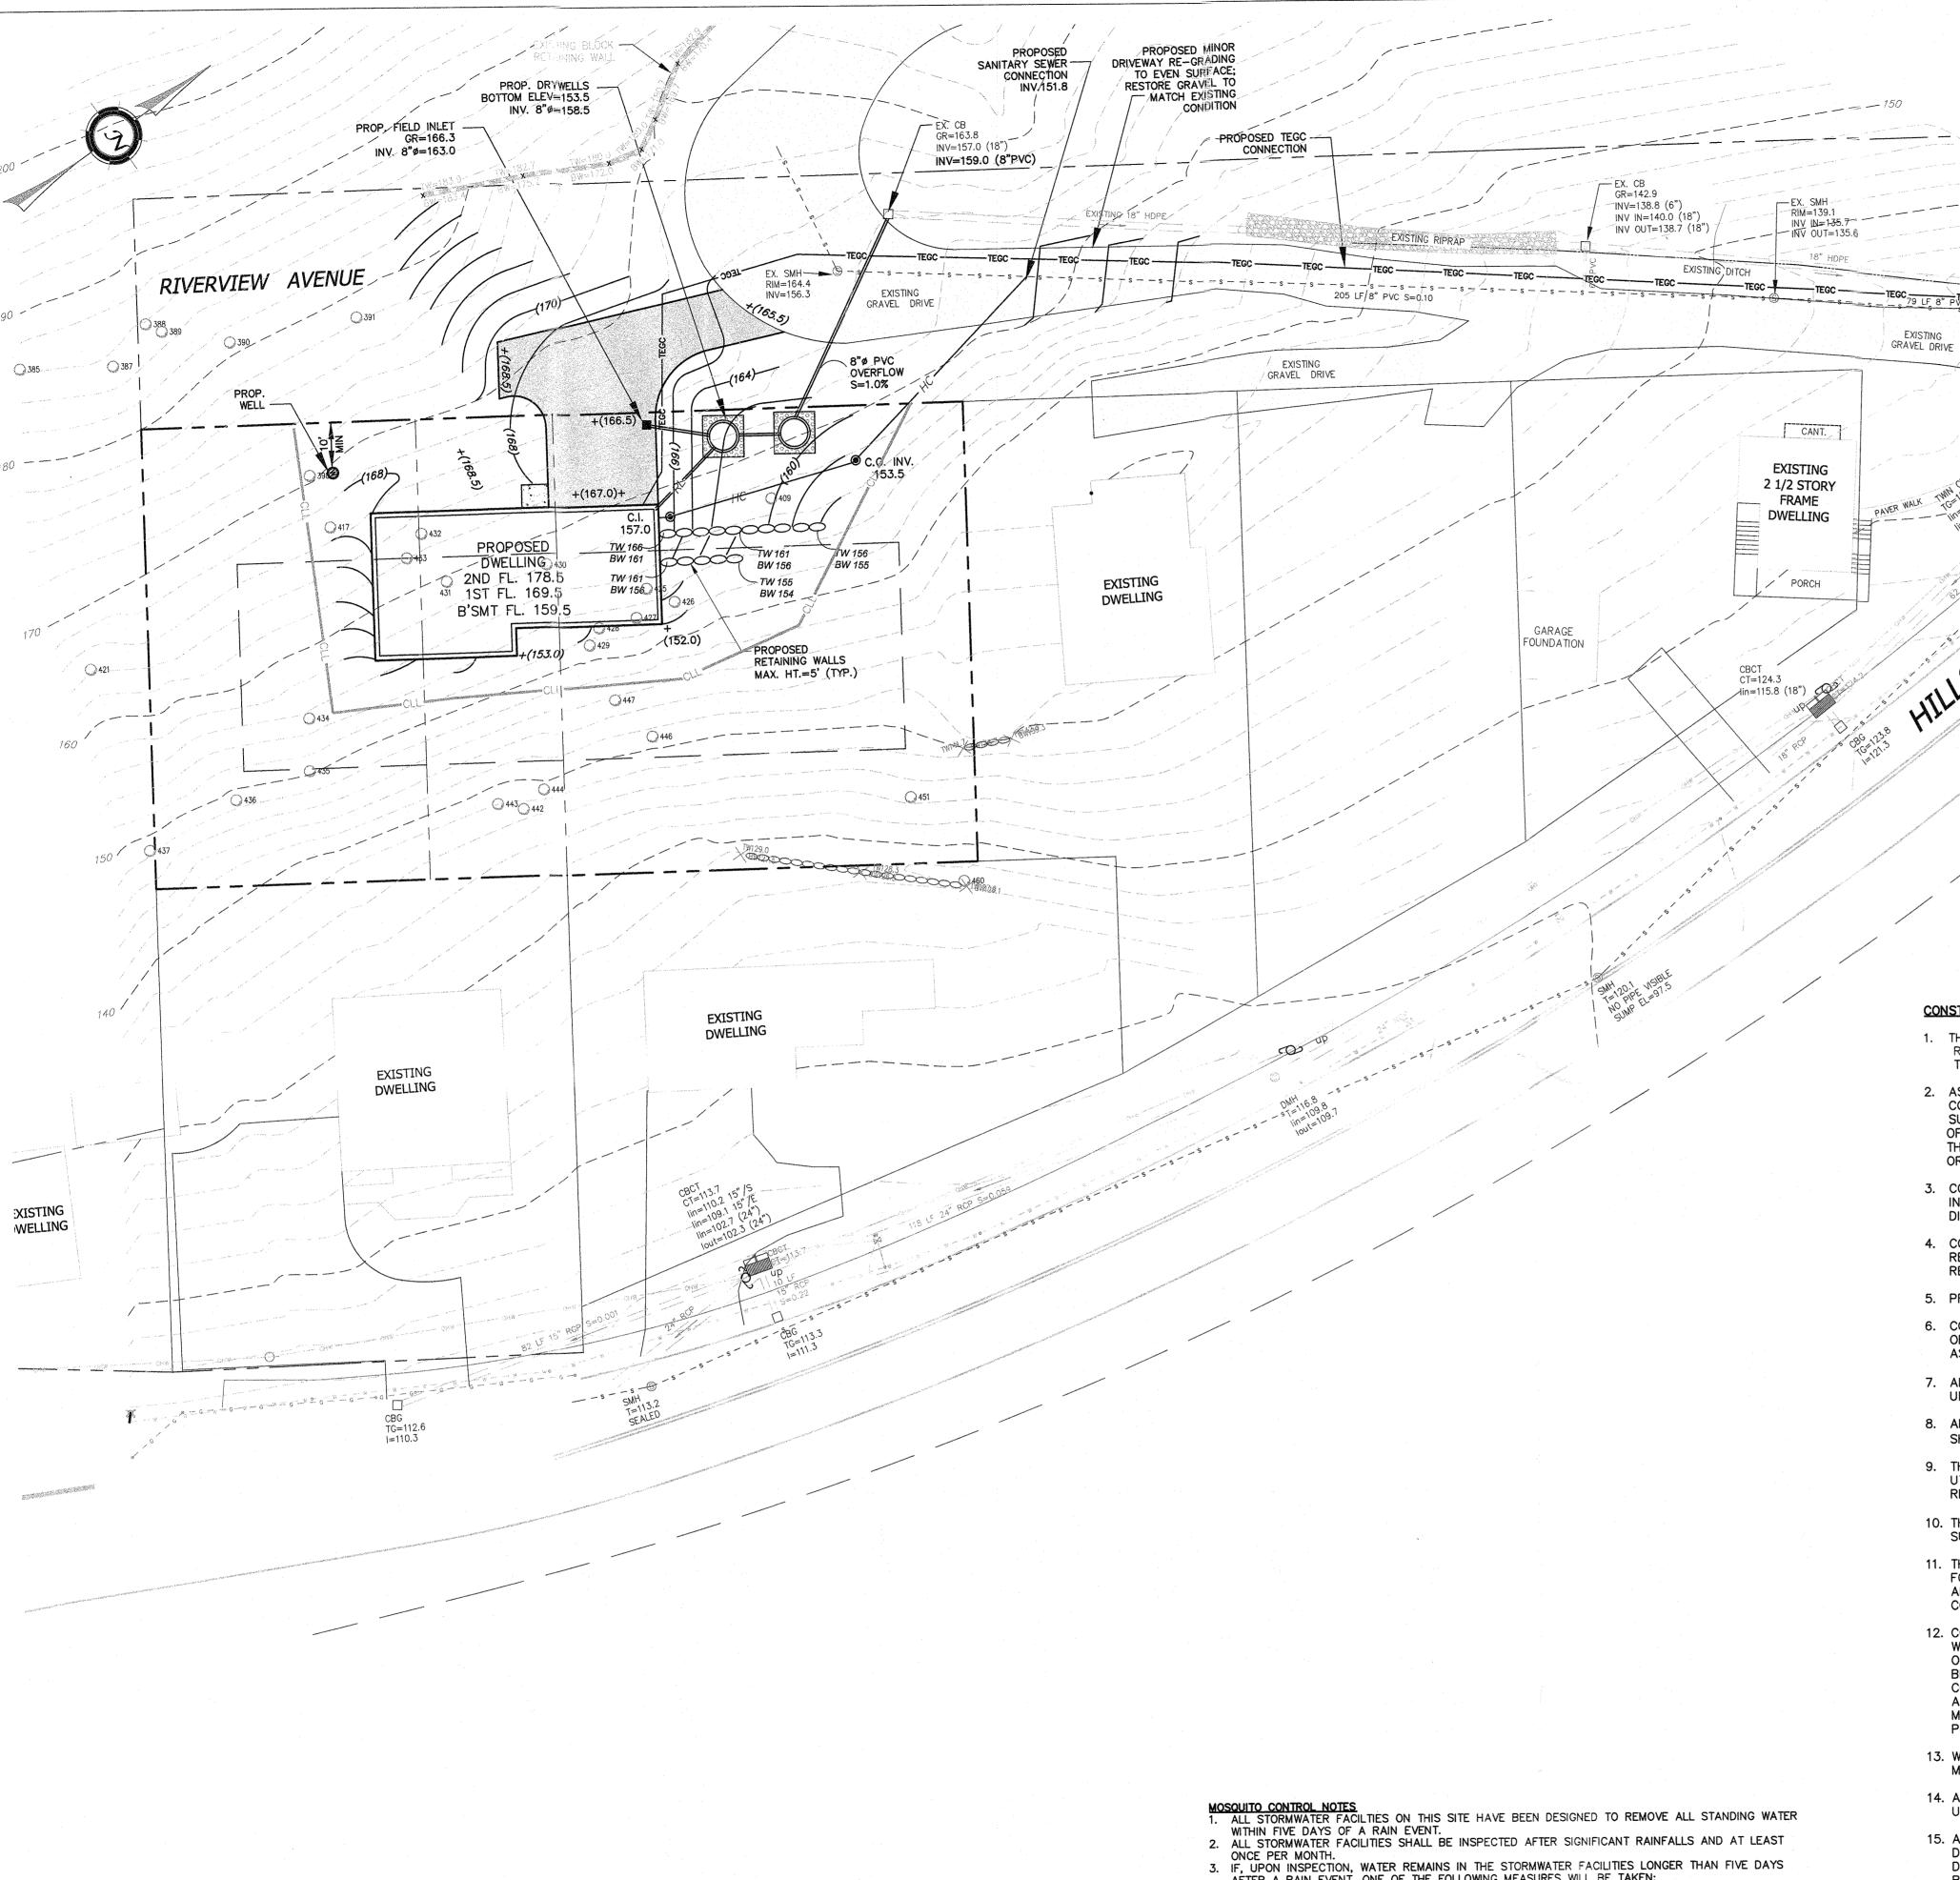

- AFTER A RAIN EVENT, ONE OF THE FOLLOWING MEASURES WILL BE TAKEN:
- A) THE WATER WILL BE MECHANICALLY REMOVED (I.E. BY VACUUM); OR
- B) THE WATER WILL BE MECHANICALLY AGITATED TO PREVENT MOSQUITO BREEDING; OR C) THE WATER WILL BE TREATED WITH MOSQUITO LARVICIDE IN ACCORDANCE WITH NYSDEC AND
- ROCKLAND COUNTY HEALTH DEPARTMENT GUIDELINES, REGULATIONS AND PROCEDURES. 4. MOSQUITO BREEDING SUPPRESSION MEASURES MUST BE IMPLEMENTED BETWEEN APRIL 1 AND
- OCTOBER 31. 5. LARVICIDE TO BE APPLIED SHALL BE "MOSQUITO DUNKS" AS MANUFACTURED BY SUMMIT CHEMICAL
- CO., BALTIMORE, MD. OR ROCKLAND COUNTY DEPARTMENT OF HEALTH APPROVED EQUAL. LARVICIDE SHALL BE APPLIED IN ACCORDANCE WITH MANUFACTURER'S SPECIFICATIONS.
- 6. THE LONG TERM MAINTENANCE OF THE ON-SITE STORMWATER SYSTEM SHALL BE THE RESPONSIBILITY OF THE PROPERTY OWNER.

CONSTRUCTION NOTES:

TG=132.0
Jin=124.8

- 1. THE DRIVEWAY, GRADING AND DRAINAGE SHOWN WITHIN THE RIVERVIEW AVENUE RIGHT-OF-WAY REFLECT IMPROVEMENTS THAT WERE APPROVED AND REQUIRED TO BE CONSTRUCTED AS PART OF THE MAJOR SUBDIVISION OF LANDS OF DANSOME.
- 2. AS INDICATED IN NOTE #1 ON SHEET #9 OF THE APPROVED DANSOME SUBDIVISION PLANS, THE CONSTRUCTION OF THE RIVERVIEW AVENUE IMPROVEMENTS IS THE OBLIGATION OF THE OWNER, SUCCESSOR OR ANY AGENT THEREOF THE DANSOME SUBDIVISION. THE PROPOSED CONSTRUCTION OF CERTAIN IMPROVEMENTS BY LEVESQUE AT THIS TIME SHOULD NOT BE CONSTRUED TO REMOVE THAT OBLIGATION FROM THE OWNER, SUCCESSOR OR ANY AGENT OF THE DANSOME SUBDIVISION.
- 3. CONTRACTOR SHALL FIELD LOCATE ALL EXISTING UTILITIES AND VERIFY ALL LOCATIONS, ELEVATIONS, INVERTS, ETC. PRIOR TO ANY CONSTRUCTION AND NOTIFY THE DESIGN ENGINEER OF ANY DISCREPANCIES ON THIS PLAN.
- 4. CONTRACTOR SHALL CONTACT ALL UTILITY COMPANIES AND HAVE ALL UTILITIES FIELD LOCATED BY RESPECTIVE UTILITY COMPANY AND SHALL ASSUME FULL RESPONSIBILITY AND SHALL BE SOLELY RESPONSIBLE FOR MAINTAINING CONTINUOUS UTILITY SERVICE AND REPAIRS TO ANY DAMAGE.
- 5. PROJECT SAFETY AND TRAFFIC MAINTENANCE ARE THE SOLE RESPONSIBILITY OF THE CONTRACTOR.
- 6. CONTRACTOR TO COORDINATE WITH ALL COMPANIES TO ASSURE ADEQUATE SUPPLY AND SCHEDULING OF NEW SERVICE, WHERE REQUIRED, TO FIT THE CONSTRUCTION SCHEDULING AND SEQUENCE TO ASSURE NO DAMAGE OR DISTURBANCE TO EXISTING SERVICES.
- 7. ALL STORM DRAINAGE PIPE TO BE HIGH DENSITY POLYETHYLENE PIPE (HDPE) WITH SMOOTH INTERIOR UNLESS OTHERWISE SPECIFIED.
- 8. ALL ROOF LEADERS ARE TO BE CONNECTED TO THE ON-SITE STORMWATER SYSTEM. ROOF LEADERS SHALL BE 6" PVC WITH A MINIMUM SLOPE OF 1.0%.
- 9. THE CONTRACTOR IS RESPONSIBLE TO NOTIFY THE OWNER AND ENGINEER OF ANY UNANTICIPATED UTILITIES ENCOUNTERED AND MAINTAIN THE UTILITIES IN WORKING ORDER UNTIL THEIR DISPOSITION IS RESOLVED.
- 10. THE CONTRACTOR SHALL BE RESPONSIBLE FOR THE RELOCATION, PROTECTION AND/OR TEMPORARY SUPPORT OF ANY UTILITIES ENCOUNTERED WITHIN THE WORK AREA.
- 11. THE CONTRACTOR SHALL COORDINATE DIRECTLY WITH EACH AFFECTED UTILITY COMPANY, SHALL APPLY FOR AND OBTAIN THE NECESSARY PERMITS AND APPROVALS, AND SHALL INITIATE AND COORDINATE ALL INSPECTIONS NECESSARY FOR FINAL APPROVAL AND ACCEPTANCE BY THE SUBJECT UTILITY
- 12. CONTRACTOR IS RESPONSIBLE FOR MAINTAINING CONTINUOUS SERVICE OF ALL EXISTING UTILITIES WITHIN THE WORK AREA AT ALL TIMES. CONTRACTOR SHALL COORDINATE ANY REPAIR, RELOCATION OR REMOVAL OF EXISTING UTILITIES WITH EACH RESPECTIVE UTILITY COMPANY AND PROVISIONS MUST BE PROVIDED FOR TEMPORARY SERVICE OF ANY RESPECTIVE UTILITY SERVICE AFFECTED BY THE CONSTRUCTION IN THE EVENT OF ANY DISRUPTION TO THE EXISTING UTILITY. SHUT-DOWNS SHALL BE AT THE DISCRETION OF THE RESPECTIVE UTILITY COMPANIES AND COORDINATED WITH THE MUNICIPALITY AND THE ENGINEER FOR PUBLIC NOTICE IF NECESSARY. TEMPORARY SERVICE SHALL BE PROVIDED AND MAINTAINED AT NO ADDITIONAL COST.
- 13. WATER SERVICE LINE AND SEWER CONNECTION SHALL BE PLACED IN SEPARATE TRENCHES WITH A MINIMUM HORIZONTAL DISTANCE OF TEN FEET BETWEEN THEM.
- 14. ALL TRAFFIC CONTROL DEVICES SHALL BE IN ACCORDANCE WITH THE NEW YORK STATE MANUAL OF UNIFORM TRAFFIC CONTROL DEVICES.
- 15. ALL DIMENSIONS ARE MEASURED TO THE ROUGH UNLESS OTHERWISE NOTED. ELEVATIONS AND DIMENSIONS SHOWN ARE FOR GENERAL REFERENCE ONLY. THE CONTRACTOR SHALL VERIFY ALL DIMENSIONS, CONDITIONS, AND ELEVATIONS IN THE FIELD PRIOR TO THE USE OF SUCH INFORMATION IN BIDDING OR CONSTRUCTION. THE CONTRACTOR SHALL TAKE ALL FIELD MEASUREMENTS NECESSARY TO ASSURE PROPER FIT OF FINISHED WORK AND SHALL ASSUME FULL RESPONSIBILITY FOR THEIR ACCURACY. NOTIFY THE ENGINEER IMMEDIATELY OF ANY DIMENSIONAL DISCREPANCIES.
- 16. THE CONTRACTOR SHALL PERFORM ALL WORK WITH CARE SO THAT ANY MATERIALS WHICH ARE TO REMAIN IN PLACE WILL NOT BE DAMAGED. IF THE CONTRACTOR DAMAGES ANY MATERIALS WHICH ARE TO REMAIN IN PLACE. THE DAMAGED MATERIALS SHALL BE REPAIRED OR REPLACED IN A MANNER SATISFACTORY TO THE ENGINEER AT THE EXPENSE OF THE CONTRACTOR.
- 17. THE SITE SHALL BE KEPT CLEAN AT ALL TIMES. UPON COMPLETION OF WORK, ALL EXCESS MATERIAL, DEBRIS, ETC. SHALL BE REMOVED AND PROPERLY DISPOSED OF AND THE WORK AREA SHALL BE LEFT CLEAN TO THE OWNER'S SATISFACTION.



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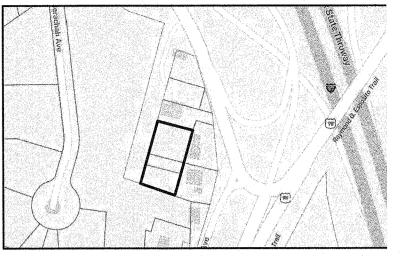
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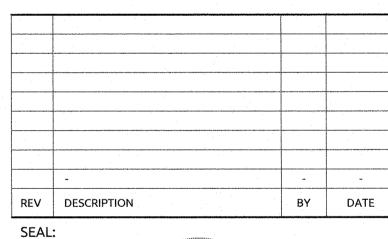
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LEVESQUE PROPERTY

1"=20'

RIVERVIEW AVENUE

SHEET TITLE:

SCALE:

SITE PLAN **GRADING & UTILITY PLAN**

DRAWN BY: SS | CHECKED BY: 12.20.23 PROJECT NO: 2399 DATE:

SHEET NUMBER: