
ORANGEBURG COMMONS PRELIMINARY/FINAL AMENDED SITE PLAN

SECTION: 74.15 BLOCK: 1 LOT(S) 21./1, 21./2, 21./3, 21./4, 21./5 & 22 TOWN OF ORANGETOWN, ROCKLAND COUNTY, NEW YORK

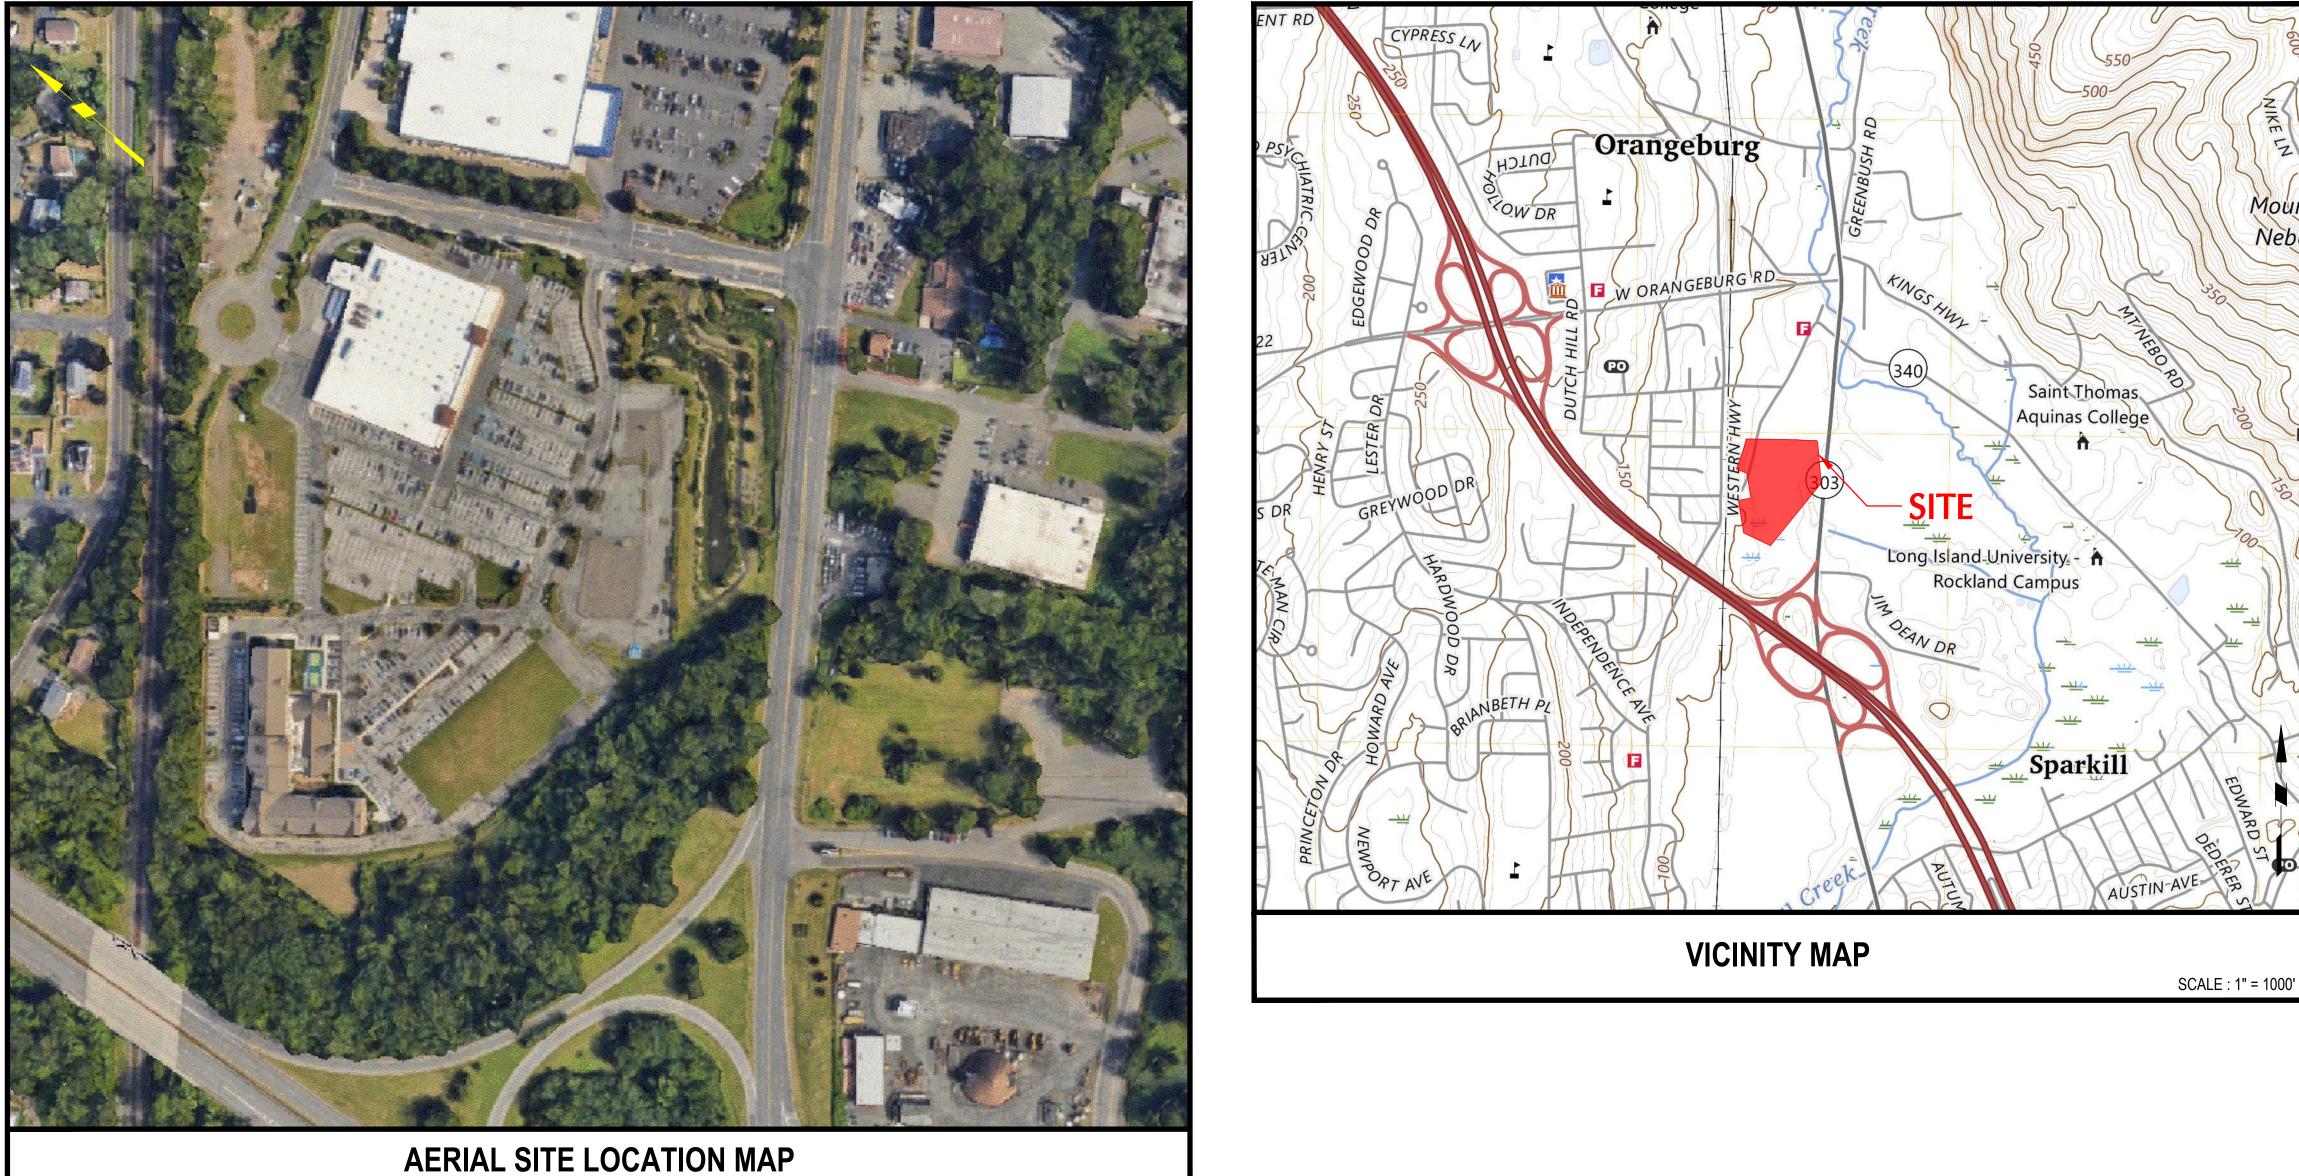





SCALE : 1" = 200'

CIVIL ENGINEER:

Bhatt Thakkar Engineering, DPC 1456 Ferry Road, Suite 603 Doylestown, PA 18901 Phone: 215.766.8280 Fax: 215.434.5280 ATTN: Anand A. Bhatt, P.E.

APPLICANT/OWNER

FB GREENBUSH, LLC. C/O RD Management 810 Seventh Avenue, 10th Floor New York, NY 10019 Phone: 212.265.6600

SURVEYOR:

JAY A. GREENWELL, PLS, LLC 85 Lafayatte Avenue Suffern, NY 10901 Phone: 845.357.0830

	Drawing Index			
Sheet No.	Drawing No.	Drawing Title	Last Revised	
1	GI-001	Cover Sheet	8/17/2023	
2	DM-100	Existing Conditions & Demolition Plan	8/17/2023	
3	CS-100	Master Site	8/17/2023	
4	CS-101	Site Plan	8/17/2023	
5	CS-501	Site Construction Details	8/17/2023	
6	CG-100	Grading Plan	8/17/2023	
7	CG-110	Drainage Plan	8/17/2023	
8	CE-100	Soil Erosion and Sediment Control Plan	8/17/2023	
9	CE-501	Soil Erosion and Sediment Control Notes and Details	8/17/2023	
10	CU-100	Utility Plan	8/17/2023	
11	CU-301	Utility Profiles	8/17/2023	
12	CU-501	Notes and Constructon Details	8/17/2023	
13	SC-100	Site Cap Plan	8/17/2023	
14	LP-100	Landscape Plan	8/17/2023	
15	LT-100	Lighting Plan	8/17/2023	
16	16 LP-501 Landscape and Lighting Details 8/17/2023			
		SUPPLEMENTAL DRAWINGS		
1	Topographic S	Survey prepared by Jay A. Greenwell PLS, LLC, dated 07/28/23		

OWN OF ORANGETOWN OWN CLERK ROSANNA SFRAGA 26 W. ORANGEBURG ROAD ORANGEBURG, NY 10962 845-359-5100 (ext 5004)

FIRE SERVICE ORANGEBURG FIRE DEPARTMENT KENNETH GORDON, CHIEF 61 DUTCH HILL ROAD ORANGEBURG, NY 10962 845-359-5587

POLICE SERVICE NY POLICE DEPARTMENT (ORANGETOWN) DONALD BUTTERWORTH, CHIEF 26 ORANGEBURG ROAD ORANGEBURG, NY 10962 345-359-3700

OWN OF ORANGETOWN PLANNING BOARD MRS. CHERYL CLOOPERSMITH 20 GREENBUSH ROAD

ORANGEBURG, NY 10962 845-359-8410 (ext 4330)

SEWER ROCKLAND COUNTY SEWER DISTRICT NO. 1 4 ROUTE 340 ORANGEBURG, NY 10962 845-365-6111

<u>WATER</u> VEOLIA WATER 162 OLD MILL ROAD WEST NYACK, NY 10994 877-426-8969

CONTACT LIST

GAS AND ELECTRIC ORANGE AND ROCKLAND UTILITIES 390 W. ROUTE 59 SPRING VALLEY, NY 10952

TELEPHONE & CABLE VERIZON 82-11 57TH AVE QUEENS, NY 11373

877-434-4100

866-488-0653

ROCKLAND COUNTY SOIL AND WATER CONSERVATION DISTRICT BRIANNA ROSAMILIA, DISTRICT MANAGER 50 SANITORIUM ROAD, BUILDING A, 6TH FLOOR POMONA, NY 10970 845-364-2670


ARCHITECTS:


ONYX Creative 25001 Emery Road, #400 Cleveland, OH 44128 Phone: 216.223.3212

TRAFFIC EGINEER:

COLLIERS ENGINEERING & DESIGN 400 Columbus Avenue Suite 180E Valhalla, NY 10595 Phone: 877-627-3772

> NOT ISSUED FOR CONSTRUCTION

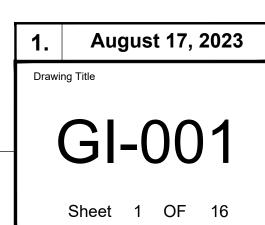

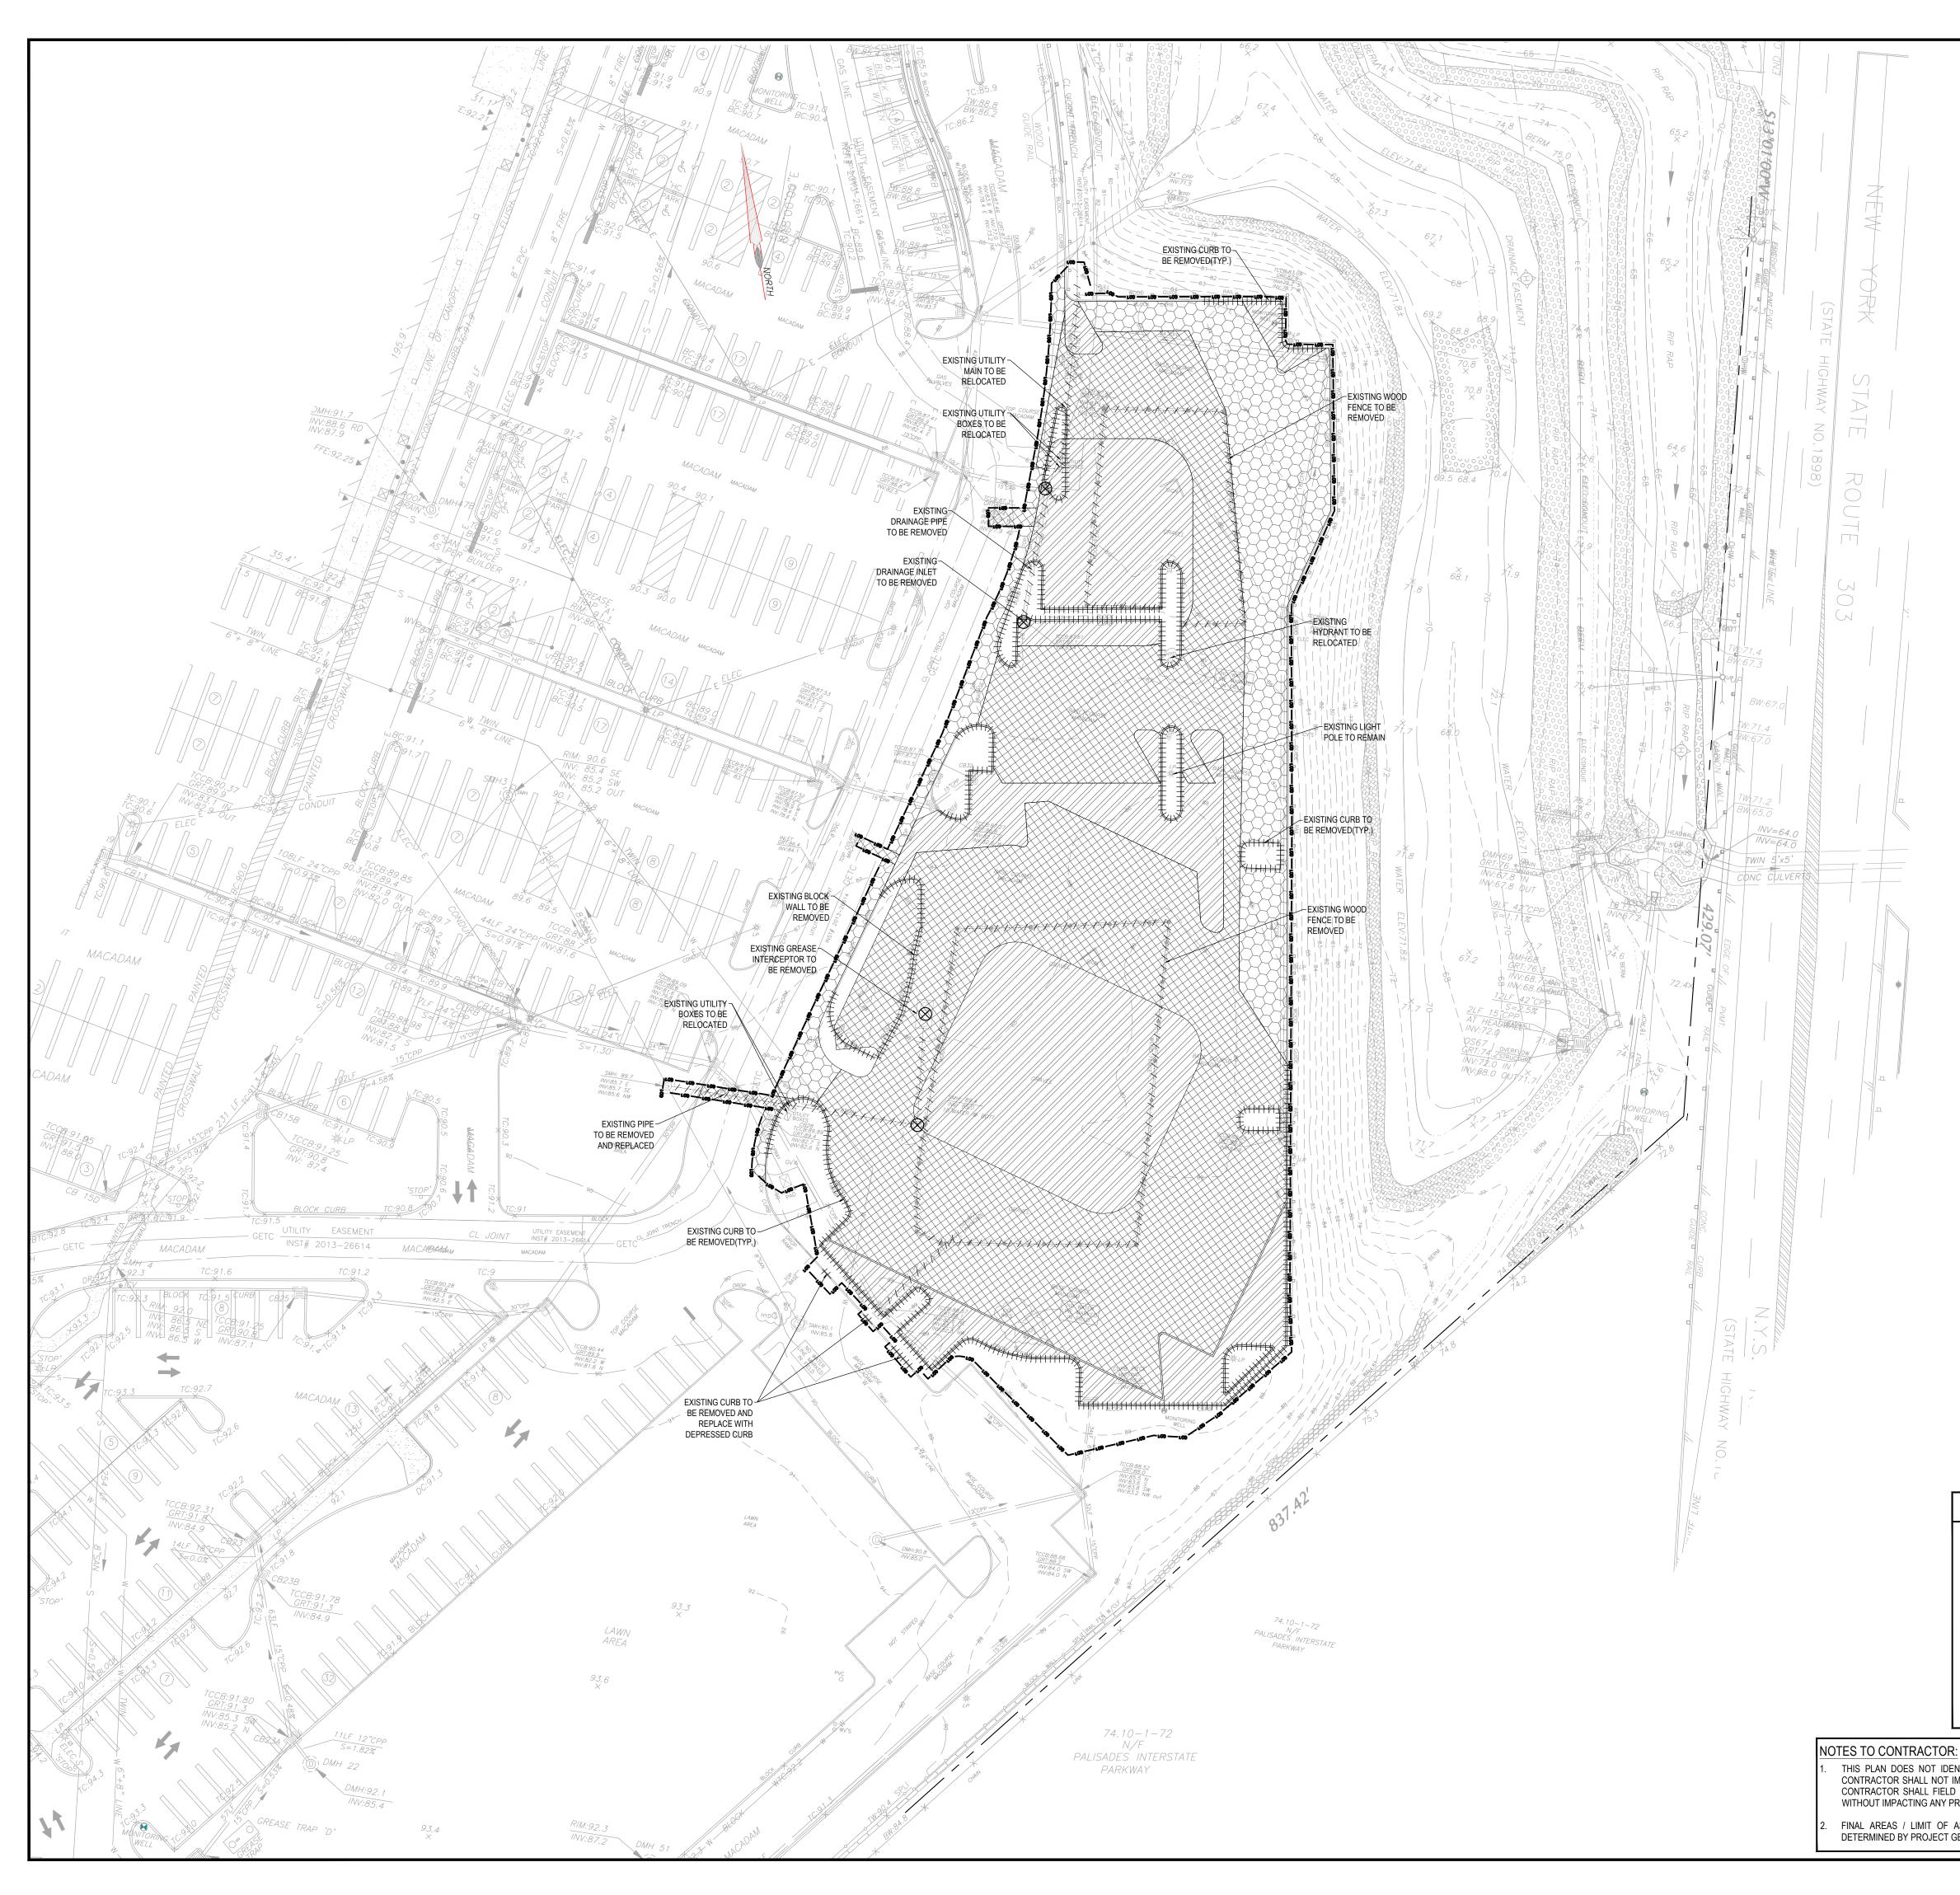

 CONTRACTOR SHALL BE I WITH THE LATEST OSHAF THIS PLAN IS PROVIDED F SHALL NOT BE CONSID DEMOLISHED. CONTRACT THE CONTRACTOR SHALL AND OTHER JURISDICT ACCORDANCE WITH ALL SPECIFICALLY THE CONS THE CONTRACTOR MUS APPROVED PLAN PRIOR T THE CONTRACTOR SHALL NCLUDING, BUT NOT LIN ABETMENT. CONTRACTOR SHALL MA ANY CONSTRUCTION AG VEHICULAR TRAFFIC TO WITH FENCING, BARROT WITH FENCING, BARROT WITH FENCING, BARROT UTILITY INTERRUPTIONS IN THE CONTRACTOR SHALL BE AMNTANED F EXISTING FACILITIES. C EXISTING FACILITIES. C INTILITY INTERRUPTIONS IN THE CONTRACTOR SHALL AND ALL DAMAGE DURIN PROTECTION SCREENS, ANY DAMAGE CAUSED BY THE CONTRACTOR SHALL OF ALL UTILITIES AND LA BEEN DETERMINED FROM OF THE CONTRACTOR SHALL OF ALL UTILITIES AND LA BEEN DETERMINED FROM OF THE CONTRACTOR SHALL OTHERS. THE INFORMAT UTILITIES AND LA BEEN DETERMINED FROM OF THE CONTRACTOR SHALL OTHERS. THE INFORMAT UTILITIES AND LA BEEN DETERMINED FROM OF THE CONTRACTOR. T ELEVATION OF EXISTING UTILITIES AND LA BEEN DETERMINED FROM OF THE CONTRACTOR. T ELEVATION OF ALS UTILITIES SAND ABER DETERMINED FROM OF THE CONTRACTOR. T ELEVATION OF AS THE THOROUGHLY VERIFY ED FEATURES, GIVE NOTICE ALL SERVICE LINES AND AL SERVI	INLESS EMBOSSED WITH THE SEAL OF RESPONSIBLE TO ENSURE THAT ALL D REQUIREMENTS AND REQUIREMENTS OF OR ILLUSTRATIVE PURPOSES ONLY TO ERED ALL INCLUSIVE. ADDITIONAL OR IS RESPONSIBLE FOR VERIFYING A . REVIEW AND COMPLY WITH ALL PRO- IONAL AGENCIES. DEMOLITION AND . APPLICABLE REGULATIONS AS W RUCTION STAGING. .T INSTALL EROSION AND SEDIMEN O THE START OF EARTH DISTURBING A L BE RESPONSIBLE FOR OBTAINING INTED TO SIDEWALK/STREET CLOSING NTAIN ALL EXISTING PARKING, SIDEW TO SIDEWALK/STREET CLOSING NTAIN AND PROTECT ALL OF SITE ADES, ENCLOSURES, ETC. (AND O' ED BY CONSTRUCTION MANAGER. CO DR THE SURROUNDING PROPERTIES / DNTRACTOR SHALL COORDINATE/PI VITH THE OWNER TO MINIMIZE DISTUR MAINTAIN AND PROTECT ALL OFFSITE G THE DEMOLITION OPERATION. THE P PLATFORMS, BRACING, UNDERPINNIN 'THE CONSTRUCTOR OR HIS/HER AGE ADDITIONAL COST TO THE OWNER. SPONSIBLE FOR THE COST AND INSTA R IS RESPONSIBLE FOR ACTUAL LIMITS TY OF THE WORK AREA. . INSPECT THE SITE THOROUGHLY AN TERALS. THE LOCATION OF ALL EXIST THE BEST INFORMATION AVAILABLE 'HE CONTRACTOR IS SPECIFICALLY (JTILITIES ARE SHOWN ON THESE PLAN ON IS NOT TO BE RELIED UPON AS T. THE CONTRACTOR MUST CALL THE XCAVATION TO REQUEST EXACT FIEL E CONTRACTOR TO RELOCATE ALL TS SHOWN ON THE PLAN. HOWN MUST NOT TO BE INTERPRETEED ONLY OBSTACLES THAT MAY OCC JSTING CONDITIONS, AND PROCEED TO THE ALL UTILITY COMPANIES REF CABLE, WATER, FIBER OPTIC CAL O BE REMOVED ARE TO BE DISCONNE E, CABLE, WATER, FIBER OPTIC CAL D SHALL BE COORDINATED WITH THE A E TIME FOR RELOCATION AND COORD	O IDENTIFY THE LIMITS OF DEMOLITION AND ITEMS MAY BE FOUND THAT SHALL BE CTUAL LIMITS & EXTENTS OF DEMOLITION. OVISIONS OF THE TOWN OF ORANGETOWN D REMOVAL SHALL BE PERFORMED IN ELL AS THE EROSION CONTROL PLANS, NTATION CONTROL MEASURES PER THE ACTIVITIES. ALL NECESSARY CONSTRUCTION PERMITS G, DEMOLITION, DISPOSAL AND ASBESTOS (ALK DRIVES, ETC. CLEAR AND FREE FROM URE EASY AND SAFE PEDESTRIAN AND MUST PROTECT THE PUBLIC AT ALL ITEMS THER APPROPRIATE BEST MANAGEMENT NTINUOUS ACCESS AND UTILITY SERVICES AT ALL TIMES DURING DEMOLITION OF THE HASE ALL CONSTRUCTION ACTIVITY AND HASE ALL CONSTRUCTION ACTIVITY AND HASE ALL CONSTRUCTION ACTIVITY AND BANCE. EPROPERTIES AND STRUCTURES FROM ANY CONTRACTOR SHALL USE ANY NECESSARY G, ETC. TO PROTECT OFFSITE PROPERTY. ENTS SHALL BE IMMEDIATELY REPAIRED BY ALLATION OF DEMOLITION / CONSTRUCTION S AND THE AMOUNT OF FENCE REQUIRED IN D FIELD VERIFY THE LOCATION AND DEPTH TING UTILITIES SHOWN ON THIS PLAN HAVE AND ARE PROVIDED FOR THE CONVENIENCE CAUTIONED THAT THE LOCATION AND JOR NS IS BASED ON THE SURVEY PREPARED BY BEING EXACT OR COMPLETE. ADDITIONAL APPROPRIATE UTILITY COMPANY AT LEAST D LOCATION OF UTILITIES. IT SHALL BE THE L UTILITIES WHICH CONFLICT WITH THE D AS OF THE EXACT SIZE, DEPTH, MATERIAL, CUR ON THE SITE. CONTRACTOR MUST WITH CAUTION AROUND AND AND AND IOF WITH CAUTION AROUND AND ANTICIPATED GARDING DESTRUCTION AND REMOVAL OF WITH CAUTION AROUND AND ANTICIPATED GARDING DESTRUCTION AND REMOVAL OF WITH CAUTION AROUND ANY ANTICIPATED GARDING DESTRUCTION AND REMOVAL OF WITH CAUTION TO THE START OF DEMOTION, BLE AND/OR GAS LINES NEEDING TO BE AFFECTED UTILITY COMPANY. CONTRACTOR MUST BUILDING.	BHATT THAKKAR ENGINEERING, DPC 1456 Ferry Road, Suite 603 Doylestown, PA 18901 T: 215.766.8280 F: 215.434.5280
 THE CONTRACTOR SHAL AND /OR RELOCATION OF CONCERNING PORTIONS ANY FEES WHICH ARE TC RESPONSIBLE FOR PAYIN THE CONTRACTOR SHALL DEPARTMENT TO PLAN I CONSTANTLY AVAILABLE PHASES OF CONSTRUCT REQUIRED WATER MAIN S SHUTOFFS WILL BE THE PROVIDED. THE DEMOLITION CONTR. WITH THE UTILITY CONT REMAIN OPEN AND OPER/ THE CONTRACTOR SH/ PROPERTIES AND EXISTIN ALL EXISTING UTILITIES T REPLACED WITH APPROV CAPPING, PROVIDED THA' ALL EXISTING BITUMINO 	L COORDINATE THE RESPECTIVE UTI UTILITIES. THE CONTRACTOR SHALL OF WORK WHICH MAY BE PERFORMED DE PAID TO THE UTILITY COMPANY F G ALL FEES AND CHARGES. COORDINATE WATER MAIN WORK WIT PROPOSED IMPROVEMENTS AND TO TO THE SITE AND THROUGH OUT ION. CONTRACTOR WILL BE RESPON SHUT OFFS DURING CONSTRUCTION. A RESPONSIBILITY OF THE CONTRACTO ACTOR SHALL COORDINATE DECOMMIN RACTOR AS TO LOCATION AND CON ATION AT ALL TIMES. ALL MAINTAIN UNINTERRUPTED UT IG TENANTS AT ALL TIMES. HAT ARE NOT TO BE MAINTAINED IN S ED COMPACTED FILL, OR BE ABANDOI I THEY DO NOT INTERFERE WITH ANY O US AND CONCRETE PAVEMENT NOT	LITY COMPANIES PRIOR TO THE REMOVAL COORDINATE WITH THE UTILITY COMPANY D BY THE UTILITY COMPANY'S FORCES AND FOR THEIR SERVICES. THE CONTRACTOR IS TH THE FIRE DEPARTMENT AND THE UTILITY ENSURE ADEQUATE FIRE PROTECTION IN THIS SPECIFIC WORK AND THROUGH ALL NSIBLE FOR ARRANGING /PROVIDING ANY ANY COSTS ASSOCIATED WITH WATER MAIN IR AND NO EXTRA COMPENSATION WILL BE ISSIONING AND REMOVAL OF UTILITY LINES NDITION OF CAPPING. THE ACCESS SHALL FILITY SERVICE TO THE SURROUNDING SERVICE SHOULD EITHER BE REMOVED AND NED IN PLACE BY FILLING WITH GROUT AND	Project ORANGEBURG COMMONS TOWN OF ORANGETOWN ROCKLAND COUNTY NEW YORK Drawing Title EXISTING CONDITIONS AND DEMOLITION PLAN
 FACILITATE BUILDING O PAVEMENT/SLAB MATERI, REGULATIONS AND ENVIF ENGINEER, AND GEOTECH 19. CONTRACTOR MAY LIMIT AS SHOWN ON THE CO SURROUNDING PAVEMEN REPAIR. 20. ALL EXISTING FOUNDA' FOOTPRINTS AND WITHIN REMOVED AND REPLACED ENGINEER. 21. THE CONTRACTOR IS RE APPROVED BY ALL GOVEF PARKING DRIVES, DRAIN/ THE REMAINING PLANS C SUITABLE MATERIALS AN PROJECT GEOTECHNICAL 22. THE CONTRACTOR SHALL THE STATE, FEDERAL, & 	CONSTRUCTION AND UTILITY INST ALS AFTER PROCESSING SHOULD BE RONMENTAL STATUES AND AT THE DIF INICAL ENGINEER. SAW-CUT & PAVEMENT REMOVAL TO CONSTRUCTION PLANS BUT IF ANY IT, ETC. THE CONTRACTOR SHALL B TIONS AND ALL SUPPORTING UTIL A 10' WIDE ZONE BEYOND THE PROPE OWITH APPROVED STRUCTURAL FILL SPONSIBLE FOR THE DEMOLITION, F RNING AUTHORITIES) OF ALL STRUCTU AGE STRUCTURES, UTILITIES, ETC. SL AN BE CONSTRUCTED. ALL FACILITIES ID BROUGHT TO GRADE WITH SUITA ENGINEER. PREPARE AND IMPLEMENT A WASTE LOCATION REGULATION IF CONTAMIN	ADING AND FILL PLACEMENT AS WELL AS TALLATIONS. THE REUSE OF EXISTING IN ACCORDANCE WITH STATE AND LOCAL RECTION OF THE OWNER, ENVIRONMENTAL DNLY THOSE AREAS WHERE IT IS REQUIRED DAMAGE IS INCURRED ON ANY OF THE RESPONSIBLE FOR IT'S REMOVAL AND ITIES WITHIN THE PROPOSED BUILDING OSED BUILDING FOOTPRINT LIMITS MUST BE COMPACTED PER PROJECT GEOTECHNICAL REMOVAL , AND DISPOSAL (IN A LOCATION RES, PADS, WALLS, FLUMES, FOUNDATIONS, JCH THAT THE IMPROVEMENTS SHOWN ON S TO BE REMOVED SHALL BE UNDERCUT TO BLE COMPACTED FILL MATERIAL PER THE MANAGEMENT PLAN IN ACCORDANCE WITH IATED MATERIAL IS ENCOUNTERED DURING	ANAND AJAY BHAT PROFESSIONAL ENGINEER SSIONAL NEW YORK LIC. No. 095707 30 0 10 30 SCALE IN FEET
DEMOLITION AND/OR CON 23. SHOULD REMOVAL AND/O STRUCTURES, THE CONT THE CONTRACT DOCUME	STRUCTION. DR RELOCATION ACTIVITIES DAMAGE RACTOR SHALL PROVIDE NEW MATER NTS. DAMAGE TO ALL EXISTING CONI . EXCEPT FOR MATERIAL DESIGNED TO LS SHALL BE NEW.	SEND PROPOSED SYMBOLS & LINES SITE PROPOSED SYMBOLS & LINES SITE SITE CURB LINE BUILDING CURB LINE BUILDING CURB LINE BUILDING CURB LINE BUILDING CURB LINE BUILDING CURB LINE BUILDING CURB LINE CURB LINE BUILDING CURB LINE CURB RAIL CURB RAI	Image: state sta
ASPHALT REPLACEMENT AND / OR MILL AND OVERLAY TO BE GEOTECHNICAL ENGINEER.			Sheet 2 of 16

TE PLAN NOTES

- ALL ASPECTS OF THE PRESENT CONSTRUCTION ACTIVITIES MUST BE PERFORMED IN CONFORMANCE WITH THE REMEDIAL WORK PLAN APPROVED BY THE NYSDEC
- AT LEAST ONE WEEK PRIOR TO THE COMMENCEMENT OF ANY WORK, INCLUDING THE INSTALLATION OF EROSION CONTROL DEVICES OR THE REMOVAL OF TREES AND VEGETATION. A PRE- CONSTRUCTION MEETING MUST BE HELD WITH THE TOWN OF ORANGETOWN DEPARTMENT OF ENVIRONMENTAL MANAGEMENT AND ENGINEERING SUPERINTENDENT OF HIGHWAYS AND THE OFFICE OF BUILDING ZONING AND PLANNING ADMINISTRATION AND ENFORCEMENT. IT IS THE RESPONSIBILITY AND OBLIGATION OF THE PROPERTY OWNER TO ARRANGE SUCH A MEETING"
- STORMWATER MANAGEMENT PHASE I REGULATIONS: ADDITIONAL CERTIFICATION, BY AN APPROPRIATE LICENSED OR CERTIFIED DESIGN PROFESSIONAL SHALL BE REQUIRED FOR ALL MATTERS BEFORE THE PLANNING BOARD INDICATING THAT THE DRAWINGS AND PROJECT ARE IN COMPLIANCE WITH THE STORMWATER MANAGEMENT PHASE II REGULATIONS.
- THE FOLLOWING AGENCIES DO NOT OBJECT TO THE TOWN OF ORANGETOWN PLANNING BOARD ASSUMING RESPONSIBILITIES OF LEAD AGENCY FOR SEQRA PURPOSES: ROCKLAND COUNTY DEPARTMENT OF PLANNING
- ROCKLAND COUNTY DEPARTMENT OF HIGHWAY ROCKLAND COUNTY DEPARTMENT OF HEALTH
- ROCKLAND COUNTY DRAINAGE AGENCY ROCKLAND COUNTY SEWER DISTRICT # PALISADES INTERSTATE PARK COMMISSION
- NEW YORK STATE DEPARTMENT OF TRANSPORTATION TOWN OF ORANGETOWN ZONING BOARD OF APPEALS
- ALL LANDSCAPING SHOWN ON THE PLAN SHALL BE MAINTAINED IN A IGOROUS GROWING CONDITION THROUGHOUT THE DURATION OF THE USE OF THE SITE. ANY PLANTS NOT SO MAINTAINED SHALL BE REPLACED WITH NEW PLANTS AT THE BEGINNING OF THE NEXT IMMEDIATELY FOLLOWING GROWING SEASON.
- PRIOR TO THE COMMENCEMENT OF ANY SITE WORK, INCLUDING THE REMOVAL OF TREES. THE APPLICANT SHALL INSTALL THE SOIL EROSION AND SEDIMENTATION CONTROL AS REQUIRED BY THE PLANNING BOARD. PRIOR TO THE AUTHORIZATION TO PROCEED WITH ANY PHASE OF THE SITE WORK. THE TOWN OF ORANGETOWN DEPARTMENT OF ENVIRONMENTAL MANAGEMENT AND ENGINEERING (DEME) SHALL INSPECT THE INSTALLATION OF ALL REQUIRED SOIL EROSION AND SEDIMENTATION CONTROL MEASURES. THE APPLICANT SHOULD CONTACT DEME AT LEAST 48 HOURS IN ADVANCE FOR AN INSPECTION
- THE CONTRACTOR'S TRAILER, IF ANY IS PROPOSED, SHALL BE LOCATED AS APPROVED BY THE PLANNING BOARD.
- IF THE APPLICANT. DURING THE COURSE OF CONSTRUCTION. ENCOUNTERS SUCH CONDITIONS AS FLOOD AREAS, UNDERGROUND WATER, SOFT OR SILTY AREAS, IMPROPER DRAINAGE, OR ANY OTHER UNUSUAL CIRCUMSTANCES OR CONDITIONS THAT WERE NOT FORESEEN IN THE ORIGINAL PLANNING, SUCH CONDITIONS SHALL BE REPORTED IMMEDIATELY TO DEME. THE APPLICANT SHALL SUBMIT THEIR RECOMMENDATIONS AS TO THE SPECIAL TREATMENT TO BE GIVEN SUCH AREAS TO SECURE ADEQUATE, PERMANENT AND SATISFACTORY CONSTRUCTION. DEME SHALL INVESTIGATE TH CONDITION(S), AND SHALL EITHER APPROVE THE APPLICANT'S RECOMMENDATIONS TO CORRECT THE CONDITION(S), OR ORDER A MODIFICATION THEREOF. IN THE EVENT OF THE APPLICANT'S DISAGREEMENT WITH THE DECISION OF DEME, OR IN THE EVENT OF A SIGNIFICANT CHANGE RESULTING TO THE SUBDIVISION PLAN OR SITE PLAN OR ANY CHANGE THAT INVOLVES A WETLAND REGULATED AREA. THE MATTER SHALL BE DECIDED BY THE AGENCY WITH JURISDICTION IN THAT AREA (i.e. WETLANDS - U.S. ARMY CORPS OF ENGINEERS)
- PERMANENT VEGETATION COVER OF DISTURBED AREAS SHALL BE ESTABLISHED ON THE SITE WITHIN THIRTY (30) DAYS OF THE COMPLETION OF CONSTRUCTION.
- . PRIOR (AT LEAST 14 DAYS) TO THE PLACING OF ANY ROAD SUB-BASE THE APPLICANT SHALL PROVIDE THE TOWN OF ORANGETOWN SUPERINTENDENT OF HIGHWAYS AND DEME WITH A PLAN AND PROFILE OF THE GRADED ROAD TO BE PAVED IN ORDER THAT THESE DEPARTMENTS MAY REVIEW THE DRAWINGS CONFORMANCE TO THE APPROVED CONSTRUCTION PLANS AND THE TOWN STREET SPECIFICATIONS.
- I. THE PLANNING BOARD SHALL RETAIN THE JURISDICTION OVER LIGHTING, LANDSCAPING, SIGNS AND REFUSE CONTROL 2. THE APPLICANT SHALL COMPLY WITH ALL PERTINENT AND APPLICABLE
- ITEMS IN THE GUIDE TO THE PREPARATION OF SITE PLANS, PRIOR TO SIGNING THE FINAL PLANS.
- 3. ALL REVIEWS AND APPROVALS FROM VARIOUS GOVERNMENTA AGENCIES MUST BE OBTAINED PRIOR TO STAMPING OF THE SITE PLAN. 4 THE NEW YORK STATE DEPARTMENT OF TRANSPORTATION REQUIRES
- A TRAFFIC STUDY TO BE COMPLETED AFTER COMPLETION OF THE PROJECT TO DETERMINE IF THE INCREASE IN TRAFFIC FROM THE PROPOSED DEVELOPMENT WARRANTS IMPROVEMENTS TO THE NEIGHBORING INTERSECTIONS. ANY IMPROVEMENTS NECESSARY ARE THE RESPONSIBILITY OF THE PERMITTEE. . THE PROJECT OWNER SHALL PERFORM A TRAFFIC STUDY UPON THE
- COMPLETION OF THE PROJECT. PROJECT OWNER SHALL BE RESPONSIBLE FOR MODIFICATION OF EXISTING SIGNAL, IF REQUIRED SUBSEQUENT TO TRAFFIC STUDY 6. NO GRADING OR LANDSCAPING SHALL TAKE PLACE WITHIN THE STATE
- R.O.W. WITHOUT PRIOR APPROVAL AND PERMIT FROM NYSDOT. . ALL NON-LANDBANKED PARKING WILL BE CONSTRUCTED IN PHASE 1.
- 18. PLEASE SEE DRAWING NUMBER 13 FOR SPECIFIC SITE CAP REQUIREMENTS.
- 9. ALL PERSONS ENTERING THE REGULATED AREA ARE REQUIRED TO HAVE COMPLETED A 2 HOUR TRAINING COURSE.
- 0. THE BUILDING FOUNDATION PLANS FOR EACH BUILDING PAD SHALL BE SUBMITTED TO AKRE. THE VAPOR MITIGATION SYSTEM DESIGNED WILL BE FINALIZED BASED ON THE PILE CAP LOCATIONS AS SHOWN ON THE BUILDING FOUNDATION PLANS.
- 1. WORK THAT DISTURBS OR MAY DISTURB THE FILL MATERIALS SHALL BE PERFORMED IN ACCORDANCE WITH THE NEW YORK STATE DEPARTMENT OF LABOR ASBESTOS VARIANCE FILE NO. 08-0110.
- 2. MAINTENANCE OF THE ON-SITE STORMWATER MANAGEMENT FACILITY SHALL BE THE RESPONSIBILITY OF THE DEVELOPER. STORMWATER MANAGEMENT FACILITY SHALL BE INSPECTED AND REPORT FILED AT THE ORANGETOWN DEPARTMENT OF ENVIRONMENTAL MANAGEMENT AND ENGINEERING ANNUALLY ON OR BEFORE MAY
- 23. LOT DRAINAGE SHOWN SHALL CONSTITUTE EASEMENT RUNNING WITH THE LAND AND ARE NOT TO BE DISTURBED
- 4. ALL UTILITIES, INCLUDING ELECTRIC AND TELEPHONE SERVICE, SHALL BE INSTALLED UNDERGROUND
- 5. SIDEWALKS AND CURBS SHALL BE INSTALLED IN ACCORDANCE WITH THE HIGHWAY DEPARTMENT'S SPECIFICATIONS FOR SIDEWALKS AND CURBS.
- 6. THIS PLAN DOES NOT CONFLICT WITH THE COUNTY OFFICIAL MAP AND HAS BEEN APPROVED IN THE MANNER SPECIFIED BY SECTION 239 L&M OF THE GENERAL MUNICIPAL LAW OF THE STATE OF NEW YORK.
- . CERTIFICATE OF OCCUPANCY SHALL NOT BE REQUESTED FROM THE TOWN OF ORANGETOWN BUILDING DEPARTMENT UNTIL RESULTS OF INFILTRATION AND EXFILTRATION TESTS FOR SANITARY SEWERS ARE CERTIFIED BY A NEW YORK STATE LICENSED PROFESSIONA ENGINEER AND APPROVED BY THE DIRECTOR. DIVISION OF SEWERS.
- 8. EACH INDIVIDUAL USER/STORE SHALL MAKE APPLICATION TO ACABOR TO FACADE AND SIGN REVIEW AND APPROVAL. THE APPLICANT SHAL MAKE APPLICATION TO ACABOR FOR REVIEW AND APPROVAL FOR THE RESTAURANT, BANK, AND ALL OTHER PROPOSED RETAIL AND COMMERCIAL USES TO OCCUPY THE BUILDINGS.
- 29. EACH TENANT IN THE RETAIL CENTER MUST RETURN FOR SIGNAGE AND FACADE REVIEW AND APPROVAL. ROOF TOP EQUIPMENTS TO BE FULLY SCREENED. THE ACTUAL TENANT TO OCCUPY THE SPACE MUST RETURN FOR SIGNAGE AND FACADE REVIEW AND APPROVAL.
- 30. THE ACTUAL TENANT TO OCCUPY THE RESTAURANT SPACE MUST RETURN FOR SIGNAGE AND FACADE REVIEW AND APPROVAL.
- 1. TREES SHALL BE PROTECTED DURING CONSTRUCTION WITH SNOW FENCING UP TO THE DRIP LINE.
- 2. NO GRADING IS TO TAKE PLACE WITHIN FIVE FEET OF ANY PROPERTY LINE, EXCEPT AS SPECIFIED ON THE APPROVED SITE PLAN.
- 3. ALL NO PARKING SIGNAGE SHALL BE INSTALLED BEFORE A CERTIFICATE OF OCCUPANCY IS ISSUED.

SITE AT ALL DESIGN POINTS.

- 4. APPROVAL PER ACABOR #06-70, DECEMBER 5, 2006
- 35. THE TOWN BOARD HAS APPROVED AMENDMENT OF THE SPECIAL PERMIT ON JULY 11, 2023. 6. THE "PHASE 2* (BUILDING CONSTRUCTION ONLY) COURTYARD BY
- MARRIOTT PORTION OF THE OVERALL PROJECT. WILL HAVE TO BE STABILIZED TO THE SATISFACTION OF TOWN OF ORANGETOWN BUILDING'S DEPARTMENT, PRIOR TO THE CONSIDERATION OF THE CERTIFICATE OF OCCUPANCIES FOR "PHASE 1". 7. THE STATE ENVIRONMENTAL QUALITY REVIEW ACTION REVIEW HAS
- BEEN COMPLETED BY THE TOWN OF ORANGETOWN TOWN BOARD ON MARCH 7, 2012. 8. THERE IS NO NET INCREASE IN PEAK RATE OF DISCHARGE FROM THE
- 9. PRIOR TO ANY GRADING OR CONSTRUCTION ON THE SITE, A SOIL AND EROSION CONTROL PLAN SHALL BE DEVELOPED THAT MEETS THE NEW YORK STATE GUIDELINES FOR URBAN EROSION AND SEDIMENT CONTROL

- THE TREE PROTECTION AND PRESERVATION GUIDELINES ADOPTED PURSUANT TO SECTION 21-24 OF THE LAND DEVELOPMENT REGULATIONS OF THE TOWN OF ORANGETOWN WILL BE IMPLEMENTED IN ORDER TO PROTECT AND PRESERVE BOTH INDIVIDUAL SPECIMEN TREES AND BUFFER AREA WITH MANY TREES STEPS THAT WILL BE TAKEN TO PRESERVE AND PROTECT EXISTING TREES TO REMAIN ARE AS FOLLOWS:
- A. NO CONSTRUCTION EQUIPMENT SHALL BE PARKED UNDER THE TREE CANOPY
- B. THERE WILL BE NO EXCAVATION OR STOCKPILING OF EARTH UNDERNEATH THE TREE TREES DESIGNATED TO BE PRESERVED SHALL BE MARKED
- ONSPICUOUSLY AN ALL SIDES AT A 5 TO 10 FOOT HEIGHT D. THE TREE PROTECTION ZONE FOR TREES DESIGNATED TO BE PRESERVED WELL BE ESTABLISHED BY ONE OF THE FOLLOWING METHODS.
- ONE (1) FOOT RADIUS FROM TRUNK PER INCH DBH DRIP LINE OF THE TREE CANOPY. THE METHOD CHOSEN SHOULD BE BASED ON PROVIDING THE MAXIMUM PROTECTION ZONE POSSIBLE. A BARRIER OF SNOW FENCE OR EQUAL IS TO BE PLACED AND MAINTAINED ONE YARD BEYOND THE ESTABLISHED FREE PROTECTION ZONE. IF IT IS AGREED THAT THE TREE PROTECTION ZONE OF A SELECTED TREE MUST BE VIOLATED, ONE OF THE FOLLOWING METHODS MUST BE EMPLOYED TO MITIGATE THE IMPACT: LIGHT TO HEAVY IMPACTS - MINIMUM OF EIGHT INCHES OF WOOD CHIPS INSTALLED IN THE TREE AREA TO BE PROTECTED CHIPS SHALL BE REMOVED UPON COMPLETION OF WORK. LIGHT IMPACTS ONLY - INSTALLATION OF 3/4 INCH OF PLYWOOD OR BOARDS, OR EQUAL OVER THE AREA TO BE PROTECTED THE BUILDER OR ITS AGENT MAY NOT CHANGE GRADE WITHIN THE TREE PROTECTION ZONE OF PRESERVED TREE UNLESS SUCH GRADE CHANGE HAS RECEIVED FINAL APPROVAL FROM PLANNING BOARD. IF THE GRADE LEVEL IS TO BE CHANCED MORE THAN SIX (6) INCHES, TREES DESIGNATED TO BE PRESERVED SHALL BE WELLED AND/OR PRESERVED IN RAISED BED, WITH THE TREE WELL A RADIUS OF THREE (3) FEET LARGER THAN THE TREE CANOPY.
- THE APPLICANT SHALL COMPLY WITH ALL REQUIREMENTS AND CONDITIONS OF THE AMENDED SPECIAL PERMIT APPROVAL GRANTED BY THE ORANGETOWN BOARD ON JULY 11, 2023
- 42. ALL OF THE CONDITIONS OF THIS DECISION SHALL BE BINDING UPON THE OWNER OF THE SUBJECT PROPERTY. ITS SUCCESSORS AND/OF ASSIGNS, INCLUDING THE REQUIREMENT TO MAINTAIN THE PROPERTY IN ACCORDANCE WITH THE CONDITIONS OF THIS DECISION AND THE REQUIREMENT. IF ANY. TO INSTALL IMPROVEMENTS PURSUANT TO TOWN CODE \$219-9 FAILURE TO ABIDE BY THE CONDITIONS OF THIS DECISION AS SET FORTH HEREIN SHALL BE CONSIDERED A VIOLATION OF THE SITE PLAN APPROVAL PURSUANT TO TOWN CODE \$21A-4.
- 43. SPECIAL PERMIT GRANTED BY ORANGETOWN TOWN BOARD ON MARCH 5, 2012.
- 44. ACABOR APPROVAL GRANTED ON MAY 3, 2012. 45. SIGN VARIANCE GRANTED BY ORANGETOWN ZONING BOARD OF APPEALS ON FEBRUARY 6, 2013 (ZBA CASE NO. 13-12) (AREA OF STOP & SHOP WALL SIGNS)
- 46 AREA VARIANCE GRANTED BY ORANGETOWN ZONING BOARD OF APPEALS ON FEBRUARY 20, 2013 (ZBA CASE NO. 13-16) (SETBACK OF PYLON SIGN)
- 47. SIGN VARIANCES GRANTED BY ORANGETOWN ZONING BOARD OF APPEALS ON OCTOBER 23, 2013 (ZBA CASE NO. 13-78) (AREA, HEIGHT AND ILLUMINATION OF RESIDENCE INN SIGNS)
- 48. ACABOR APPROVAL GRANTED ON FEBRUARY 20, 2014, PER ACABOR
- 49. ONCE THE CONDOMINIUM IS FORMED, THE OWNERS OF UNITS IN THE OMINIUM WILL OWN IN COMMON AN UNDIVIDED INTEREST IN THE COMMON ELEMENTS. WHICH INCLUDE THE SANITARY SEWER AND STORMWATER SYSTEMS SERVING THE PROPERTY. THE BOARD OF MANAGERS OF THE CONDOMINIUM WILL BE RESPONSIBLE TO SUPERVISE, ADMINISTER, OPERATE, MANAGE, INSURE, REPAIR REPLACE AND MAINTAIN (OR CAUSE THE SAME TO BE DONE OF) THE COMMON ELEMENTS. WHICH INCLUDE SANITARY SEWER AND STORMWATER SYSTEMS SERVING THE PROPERTY, IN ACCORDANCE WITH THE DECLARATION OF CONDOMINIUM, AND ALL APPLICABLE LEGAL REQUIREMENTS, LAND USE APPROVALS AND OPERATING STANDARDS (AS THOSE TERMS ARE DEFINED IN THE DECLARATION OF NDOMINIUM). IF THE BOARD OF MANAGERS FAILS TO MAINTAIN THE COMMON ELEMENTS (INCLUDING THE SANITARY SEWER AND STORMWATER SYSTEMS SERVING THE PROPERTY) IN ACCORDANCE WITH THE LAND USE APPROVALS AND/OR LEGAL REQUIREMENTS TH TOWN ORANGETOWN MAY: BUT SHALL NOT BE REQUIRED TO PERFORM SUCH MAINTENANCE AND RECOVER THE COST THEREOF FROM THE CONDOMINIUM AND/OR THE INDIVIDUAL UNIT OWNERS IF NECESSARY.

50. IRON PINS SHALL BE PLACED AT ALL LOT CORNERS

51. AS PROPOSED, THE SHOPS AND ORANGEBURG COMMONS PARCELS


- ARE TO SHARE ACCESS. PARKING, SEWER AND STORMWATER DRAINAGE UTILITIES AND SIGNAGE. PRIOR TO THE ISSUANCE OF A BUILDING PERMIT FOR THE PROPOSED 18 304 S.F. BUILDING: (I) THE OWNERS OF THE RESPECTIVE PARCELS OR THEIR DESIGNEES WILL ESTABLISH RECIPROCAL ACCESS AND PARKING EASEMENTS OR LICENSES IN. ON. OVER AND UPON THE PARCELS TO PERMIT EDESTRIAN AND VEHICULAR ACCESS, INGRESS, EGRESS, PASSAGE DELIVERY AND PARKING BY THE OWNERS OCCUPANTS EMPLOYEES AGENTS, CUSTOMERS, CONTRACTORS, GUESTS AND INVITEES OF EACH PARCEL IN, ON, OVER AND/OR UPON THE OTHER; (II) THE WHERS OF THE ORANGEBURG COMMONS PARCEL OR THE DESIGNEE WILL ESTABLISH AN EASEMENT OR LICENSE IN FAVOR O THE SHOPS PARCEL FOR CONNECTIONS TO AND USE OF THE SEWER AND/OR STORMWATER DRAINAGE UTILITY FACILITIES ON TH ORANGEBURG COMMONS PARCEL; AND (III) THE OWNERS OF ORANGEBURG COMMONS PARCEL OR THEIR DESIGNEE WIL ESTABLISH AN EASEMENT OR LICENSE TO BENEFIT FB GREENBUSH AND/OR THE OCCUPANTS OF THE SHOPS PARCEL FOR TH INSTALLATION OF SIGN PANELS ON THE PYLON SIGN ON TH ORANGEBURG COMMONS PARCEL AND THE ERECTION AND AINTENANCE OF A DIRECTORY MONUMENT SIGN ON UNIT 1 ORANGEBURG COMMONS, SUCH EASEMENTS OR LICENSES WILL BE IN FORM AND CONTENT ACCEPTABLE TO COUNSEL TO THE PLANNING BOARD, WILL CONFORM TO THE TERMS AND CONDITIONS OF TH DECLARATION OF ORANGEBURG COMMONS CONDOMINIUM FILED IN THE ROCKLAND COUNTY CLERK'S OFFICE ON NOVEMBER 12, 2014 AT INDEX NO. 1945/14, AND ANY EASEMENTS WILL BE RECORDED IN THE OFFICE OF THE ROCKLAND COUNTY CLERK, LAND RECORDS DIVISION.
- 52. A BRONZE COMMEMORATIVE PLAQUE, AS REQUIRED BY ACABOF #15-36, DATED JUNE 18, 2015, SHALL BE PLACED AT THE SITE RECOGNIZING THE LOCATION AS THE ABRAM LENT HOME TH COMMEMORATIVE PLAQUE SHALL BE APPROVED BY THE TOWN OF ORANGETOWN TOWN HISTORIAN OR DESIGNEE, PRIOR TO CREATING AND ERECTING THE PLAQUE. THE PLAGUE SHALL BE PLACED AT LOCATION ACCEPTABLE TO THE TOWN OF ORANGETOWN HISTORIAN OR DESIGNEE.
- 53. FOR PROPOSED "SHOPS AT ORANGETOWN BUILDING"
- INSTALL AN NFPA 13 COMPLIANT FIRE SPRINKLER SYSTEM. MAINTAIN THE SPRINKLER SYSTEM ACCORDING TO NFPA 25.
- THE PROPOSED FIRE SPRINKLER SYSTEM MUST BE DESIGNED TO PROTECT THE HAZARD IN EACH PROPOSED STORE USAGE. SUBMITTED TO THE TOWN OF ORANGETOWN BUREAU OF FIRE PREVENTION FOR APPROVAL BEFORE WORK COMMENCES.


INSTALL AND MAINTAIN AN NPA 72 COMPLIANT FIRE ALARM SYSTEM CONNECTED TO ROCKLAND COUNTY 44-CONTROL. PROPOSED FIRE ALARM PLANS SUBMITTED TO THE TOWN OF ORANGETOWN BUREAU OF FIRE PREVENTION FOR APPROVAL BEFORE WORK COMMENCES


INSTALL AND MAINTAIN PORTABLE FIRE EXTINGUISHERS AS REQUIRED

INSTALL EMERGENCY AS PER NEC. THE PLAN SHALL SHOW BOLLARDS TO PROTECT THE PULL IN PARKING. FACH OCCUPANCY APPLIES FOR AND MAIN CERTIFICATE FOR

- COMPLIANCE FIRE SAFETY WITH THE BUREAU OF FIRE PREVENTION. 54. THE LOCATIONS OF EACH GREASE TRAP MAY CHANGE DUE TO THE FINAL LOCATIONS OF THE FOOD SERVICE STORES INSIDE TH
- COMMERCIAL SUBDIVISION. APPLICANT TO COMPLY WITH THE TOWN OF ORANGETOWN F.O.G. (FAT, OIL, GREASE PROGRAM. 55. THE APPLICANT SHALL COMPLY WITH ALL APPLICABLE AND PERTINENT
- BOARD DECISIONS: PB #15-17: PRELIMINARY SITE PLAN APPROVAL SUBJECT TO CONDITIONS/REAFFIRMATION OF TOWN BOARD NEG. DE DATED MAY 13, 2015, ACABOR #15-36, APPROVED SUBJECT TO CONDITIONS, DATED JUNE 18, 2015 AND ACABOR #15-37, APPROVED SINGS SUBJECT TO CONDITIONS, DATED JUNE 18, 2015
- 56. SANITARY SEWER SERVICE FOR THIS PARCEL SHALL BE PROVIDED AND ACCESSED BY AND THROUGH THE ORANGEBURG SEWAGE WORKS CORPORATION FACILITIES LOCATED ON THE ADJACENT PROPERTY IDENTIFIED AS TAX LOTS 74.15-1-21 .1.2.3.4 AND .5 AND AS MORE FULLY SET FORTH IN AN 'AGREEMENT AND GRANT OF EASEMENTS AND LICENSE, SHOPS AT ORANGEBURG COMMONS AND DRANGEBURG COMMONS' WHICH AGREEMENT IS RECORDED IN THE ROCKLAND COUNTY CLERK'S OFFICE AS INSTRUMENT NUMBER 2016-.
- 57. THE PROJECT SITE IS NOT LOCATED OVER A 100 YEAR FLOOD PLAIN AS DEFINED BY FEMA.
- 58. THE PROJECT SITE IS NOT LOCATED OVER ANY WETLANDS, AS DEFINED BY USACOE

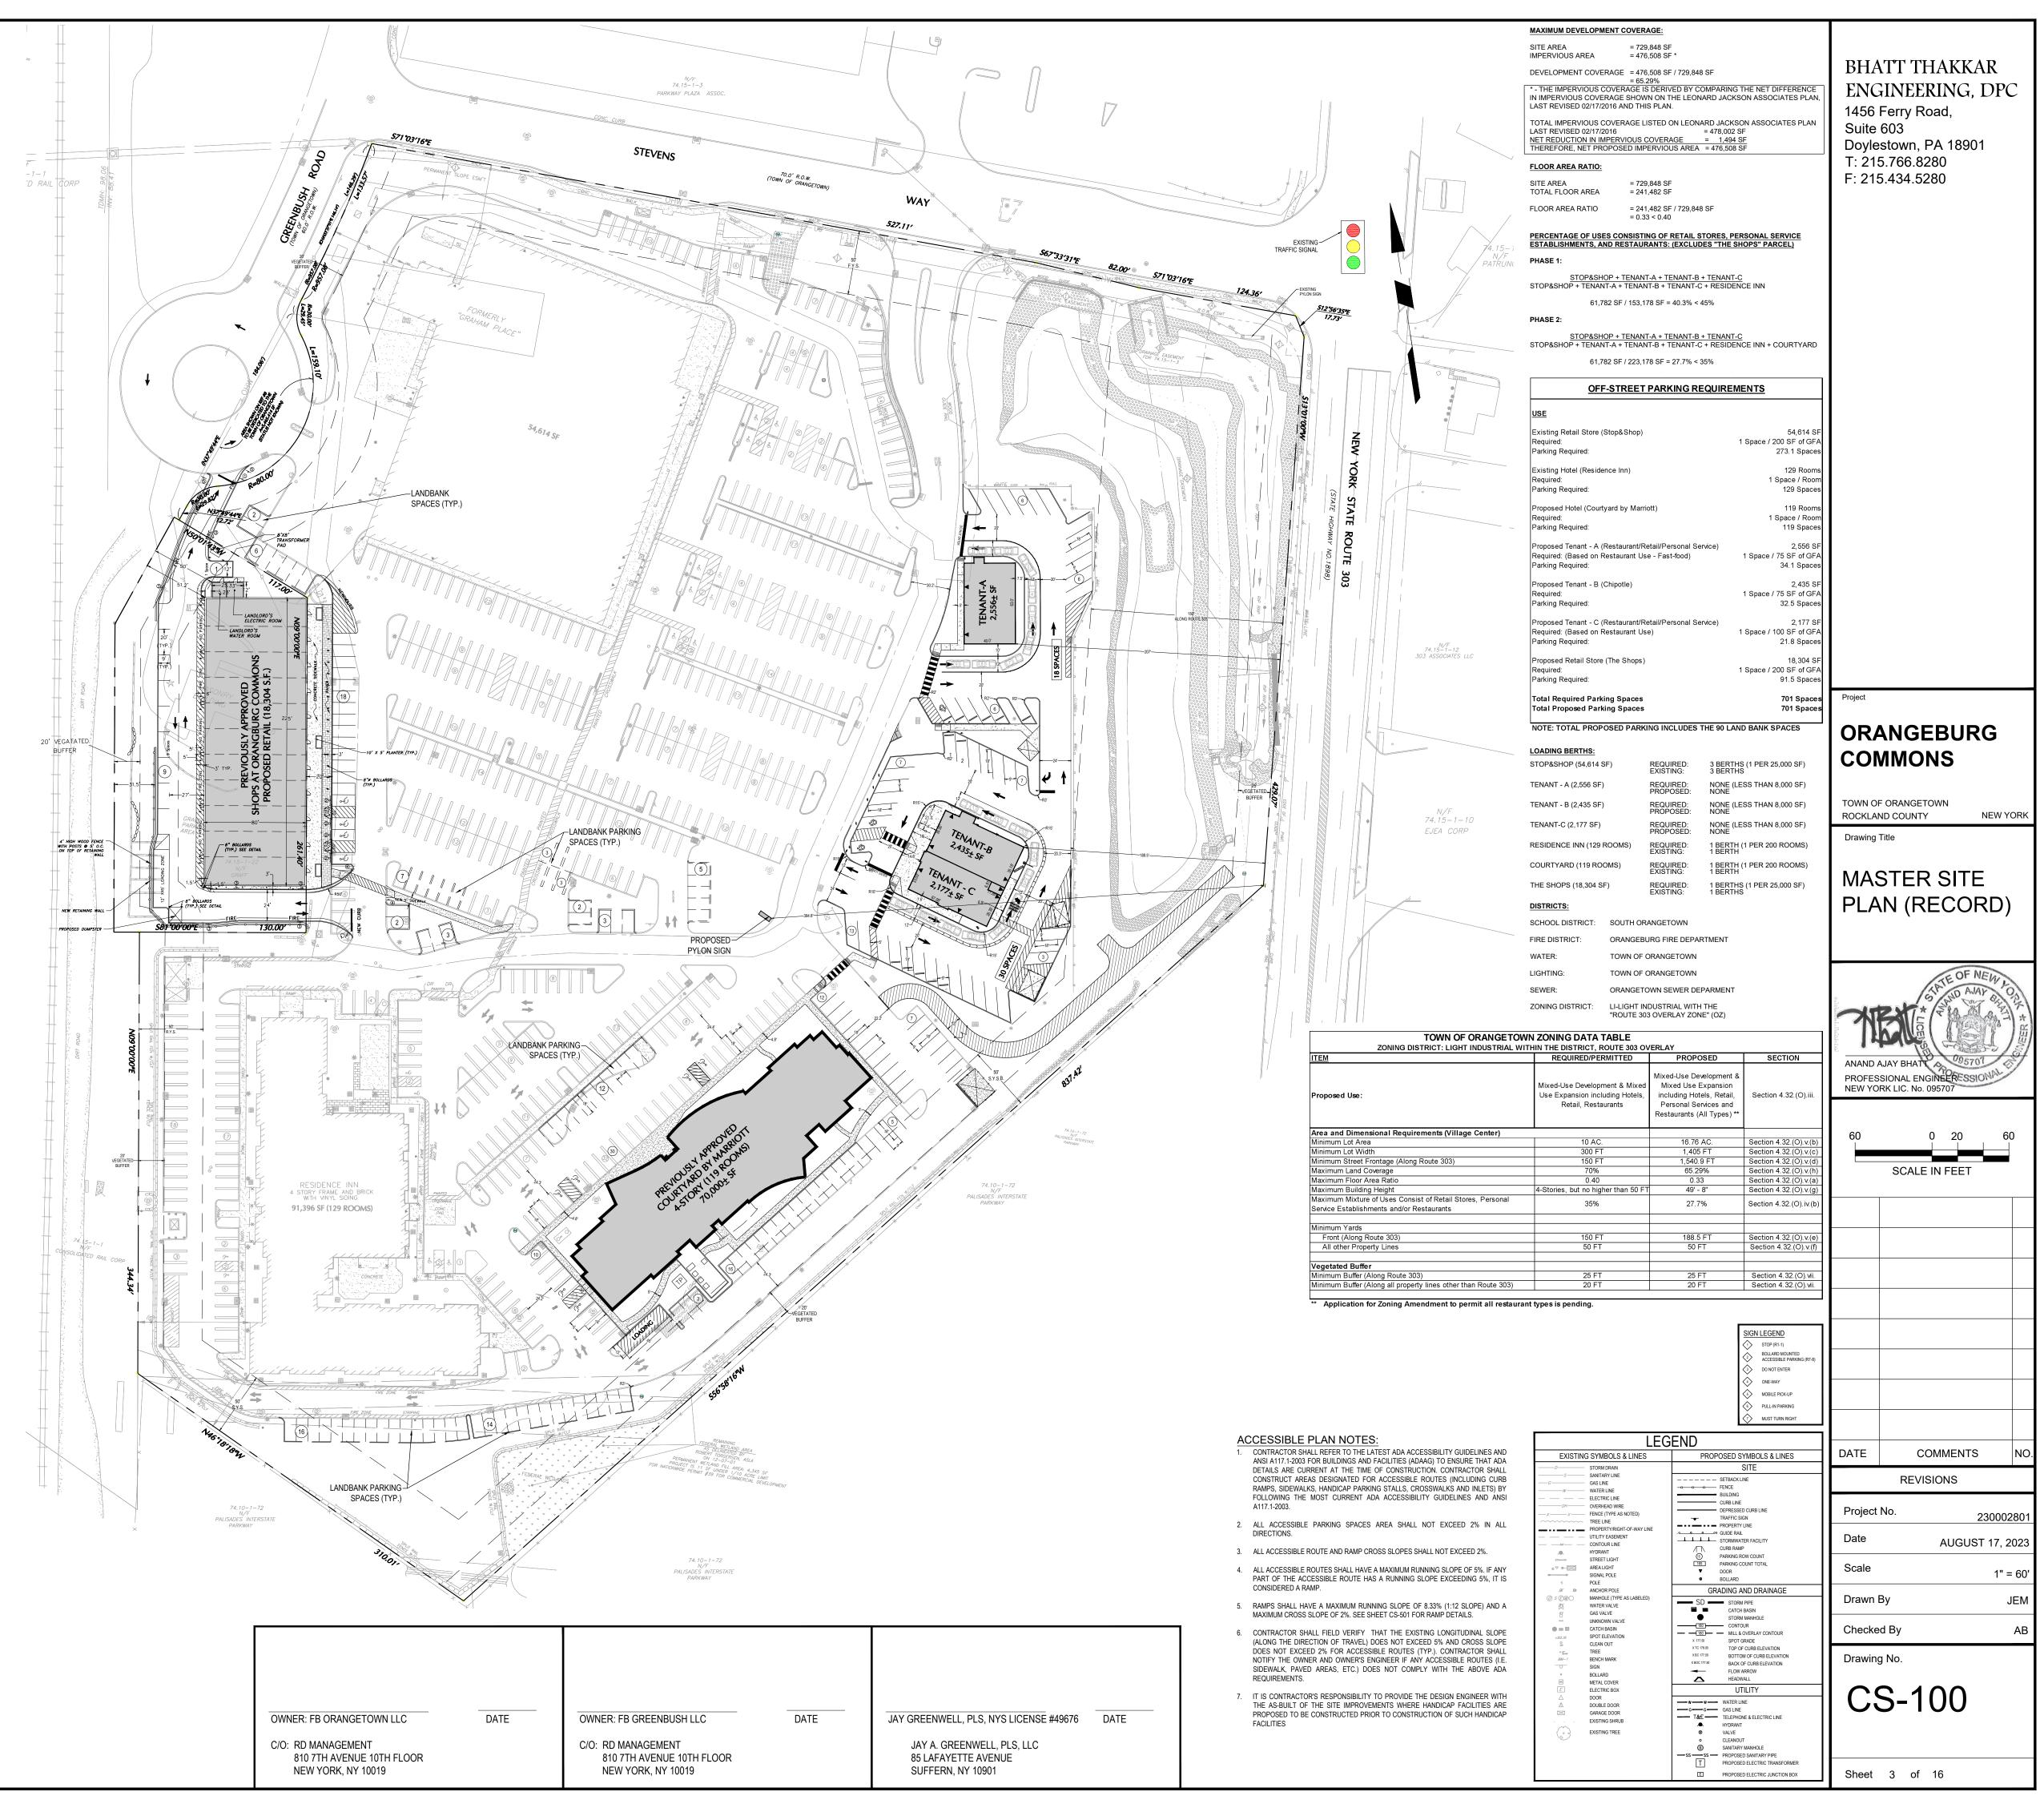

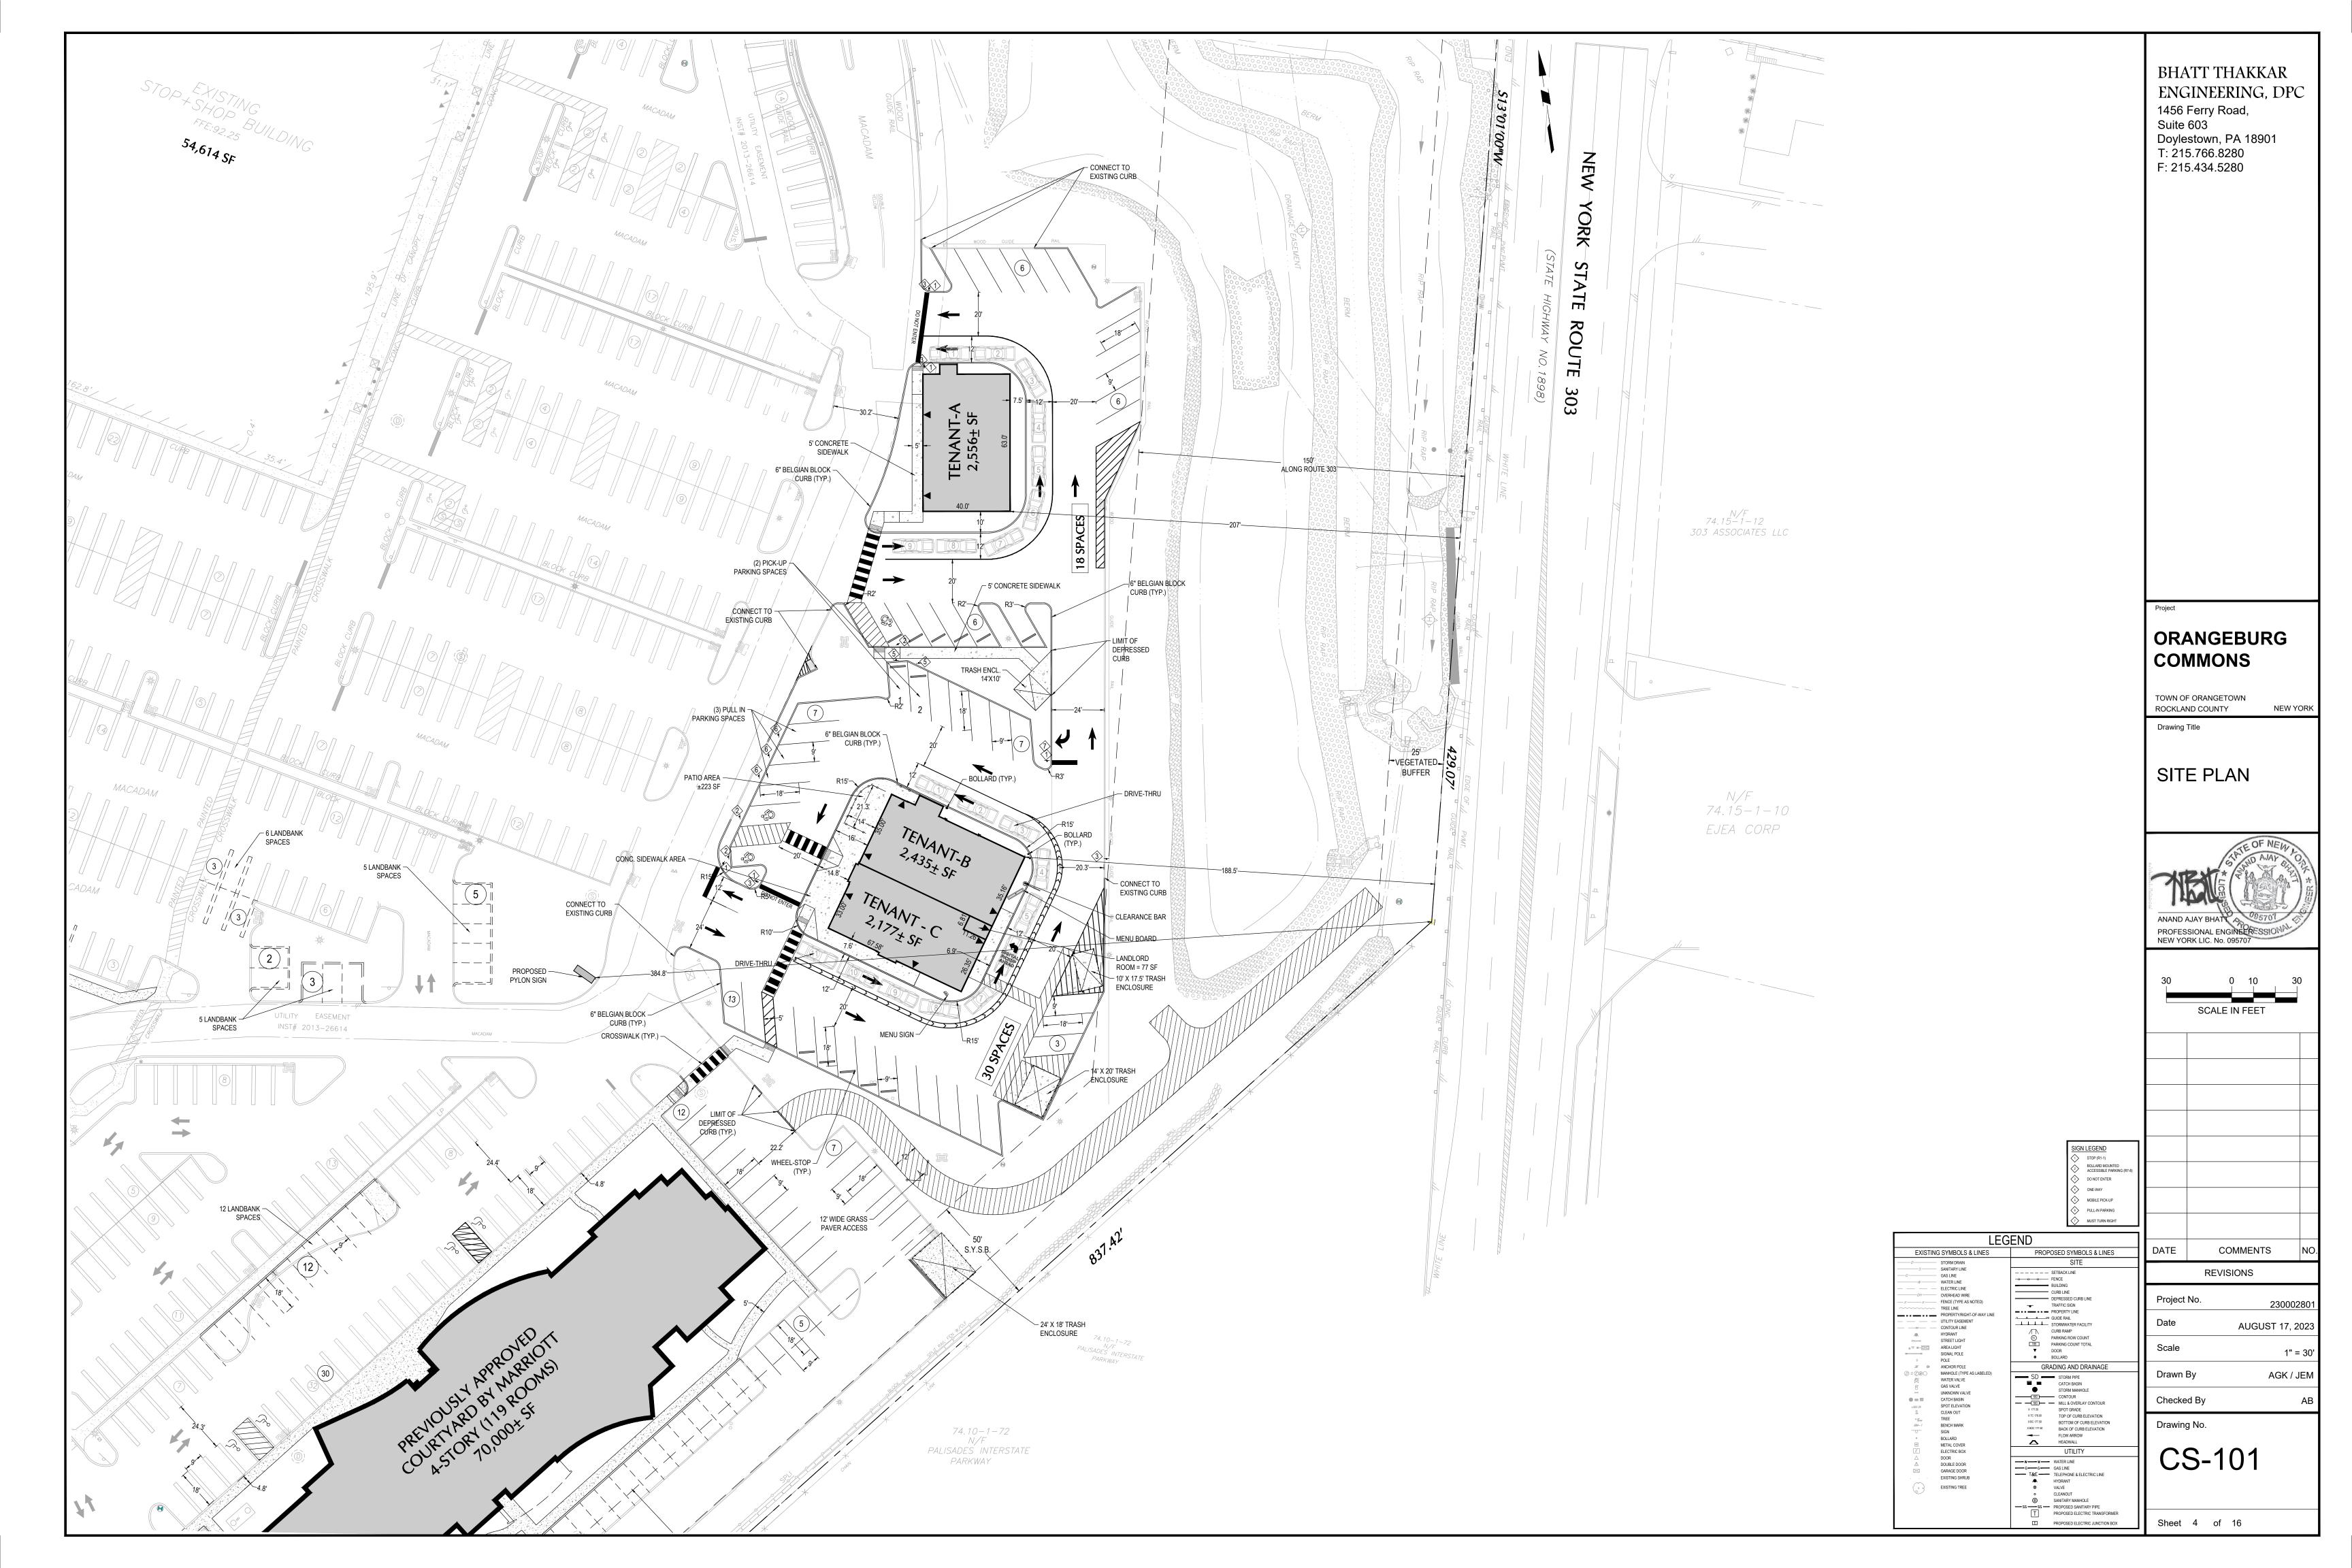

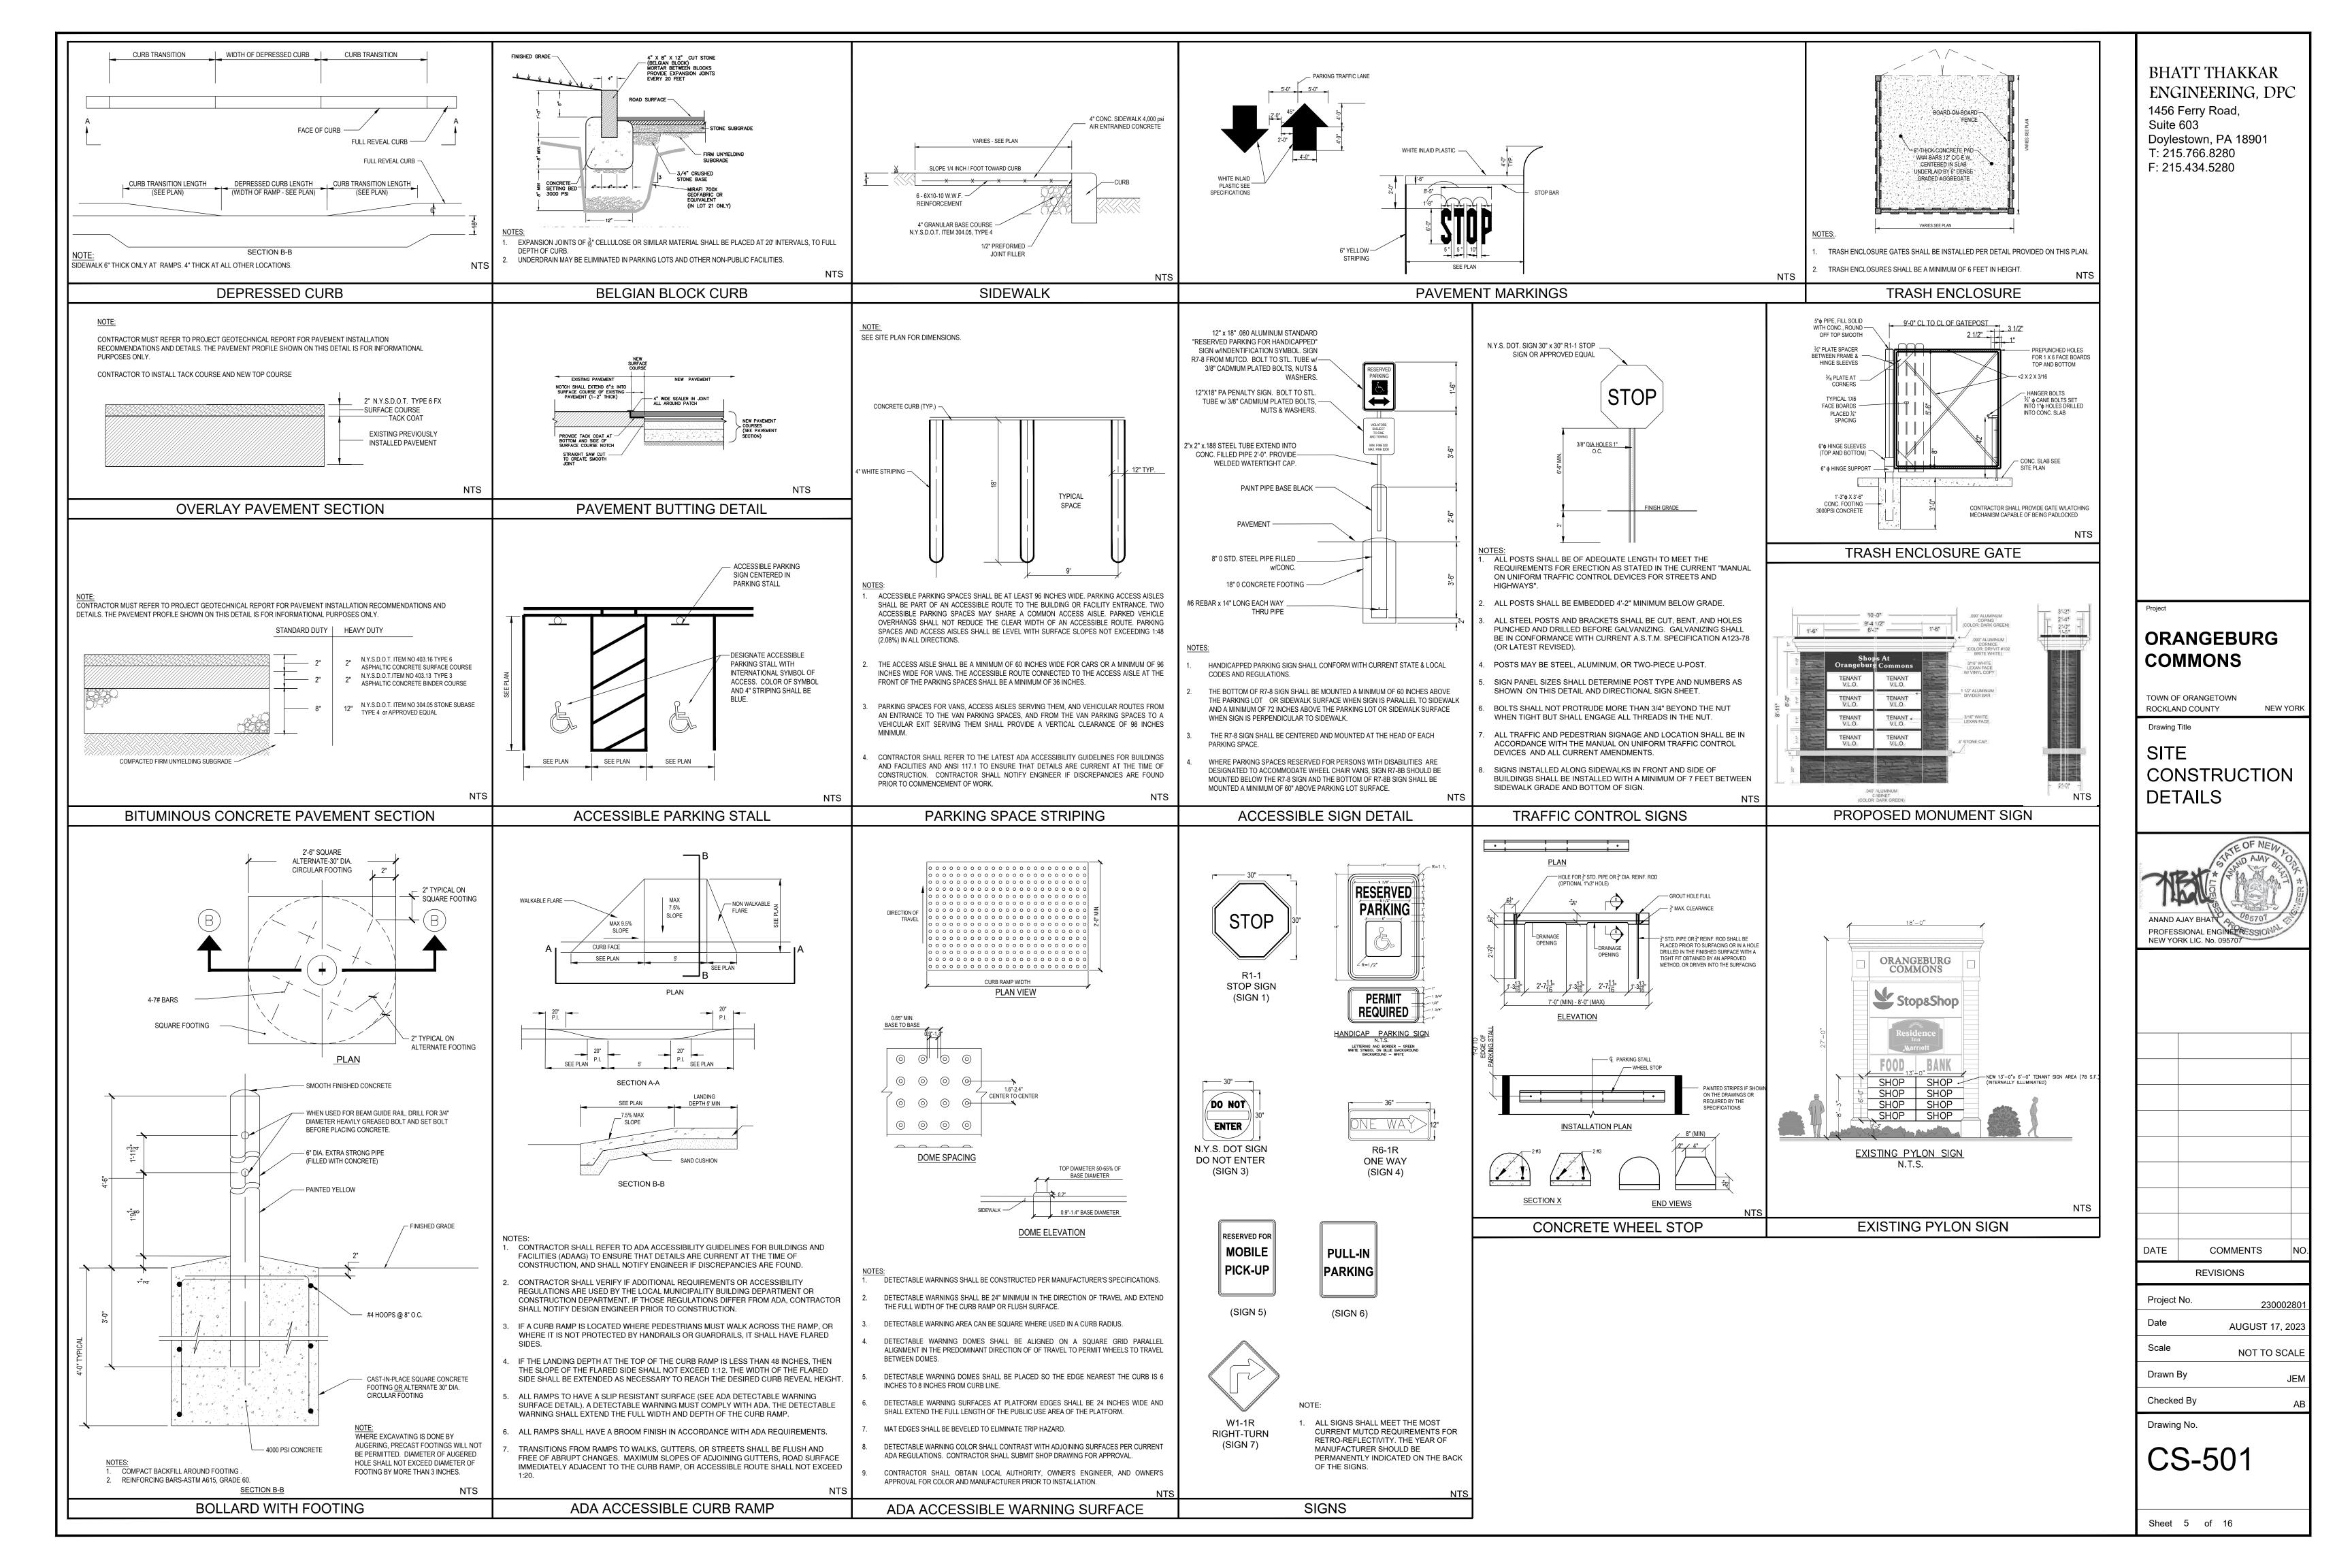




		BHATT THAKKAR ENGINEERING, DPC1456 Ferry Road, Suite 603Doylestown, PA 18901T. 215.766.8280F. 215.434.5280
ENTION MI	EASURES:	<section-header><section-header><section-header><section-header><section-header><section-header><section-header><section-header><section-header><section-header><section-header><section-header><section-header><section-header><section-header><section-header><section-header><section-header><text><text></text></text></section-header></section-header></section-header></section-header></section-header></section-header></section-header></section-header></section-header></section-header></section-header></section-header></section-header></section-header></section-header></section-header></section-header></section-header>
IG CONSTRU RIALS REQUIR ALIFIED PE INING TO REQUIRED O THE HA OUS MATERI AT THE PR DN. SAL EVELOPMEN OLID WASTE IGNATED LOU JENCY BY PR INLETS I BICYCLE ALL PRO LENGTH CENTER	HAT MAY BE PRESENT AT THE JCTION IN THE FORM OF DIESEL, RED FOR CONSTRUCTION WILL BE ERSONNEL POSSESSING THE HANDLE SUCH MATERIALS. TO HAVE HEALTH AND SAFETY ADDLING OF ANY HAZARDOUS IALS ARE NOT PROPOSED TO BE COJECT SITE AS PART OF THE IT PROJECT WILL RESULT IN THE E (LITTER AND CONSTRUCTION JCTION AND DURING OPERATION E DISPOSAL WILL BE COLLECTED CATIONS AND COLLECTED AT AN RIVATE HAULERS.	ANND AJAY BHAT POFESSIONAL ENGINEER NEW YORK LIC. No. 095707 30 30 30 30 30 30 30 30 30 30 30 30 30
LEG S & LINES 4 e e rreas Noted) GHT-OF-WAY LINE MENT ie t t e e e AS LABELED) t v v e t v e t v e t t t t t t t t t t	PROPOSED SYMBOLS & LINES SITE SITE SITE SITE SITE SITE SITE SI	DATE COMMENTS NO. DATE COMMENTS NO. REVISIONS NO. 230002801 Date AUGUST 17, 2023 Scale 1" = 30' Drawn By AG AG Checked By AB Drawing No. CG-110
R IR RUB E	WWATER LINE GSUNE GSUNE T&E T&E T&E T&E SS SS SS SS PROPOSED ELECTRIC TRANSFORMER E PROPOSED ELECTRIC TRANSFORMER E PROPOSED ELECTRIC TRANSFORMER	Sheet 7 of 16

POLLUTION PREVENTION


HAZARDOUS MATERIALS ANY HAZARDOUS MATERIA PROJECT SITE DURING CON OIL OR OTHER MATERIALS R HANDLED BY QUALIFIED APPROPRIATE TRAINING CONTRACTORS ARE REQUI PLANS RELATED TO THE MATERIALS. HAZARDOUS MA USED OR STORED AT THE PROJECT'S OPERATION.

SOLID WASTE DISPOSAL THE PROPOSED REDEVELOR GENERATION OF SOLID W DEBRIS) BOTH DURING CON OF THE FACILITIES. SOLID W AT THE SITE IN DESIGNATE APPROPRIATE FREQUENCY F


EXISTING SYMBOLS & LINE EXISTING TREE

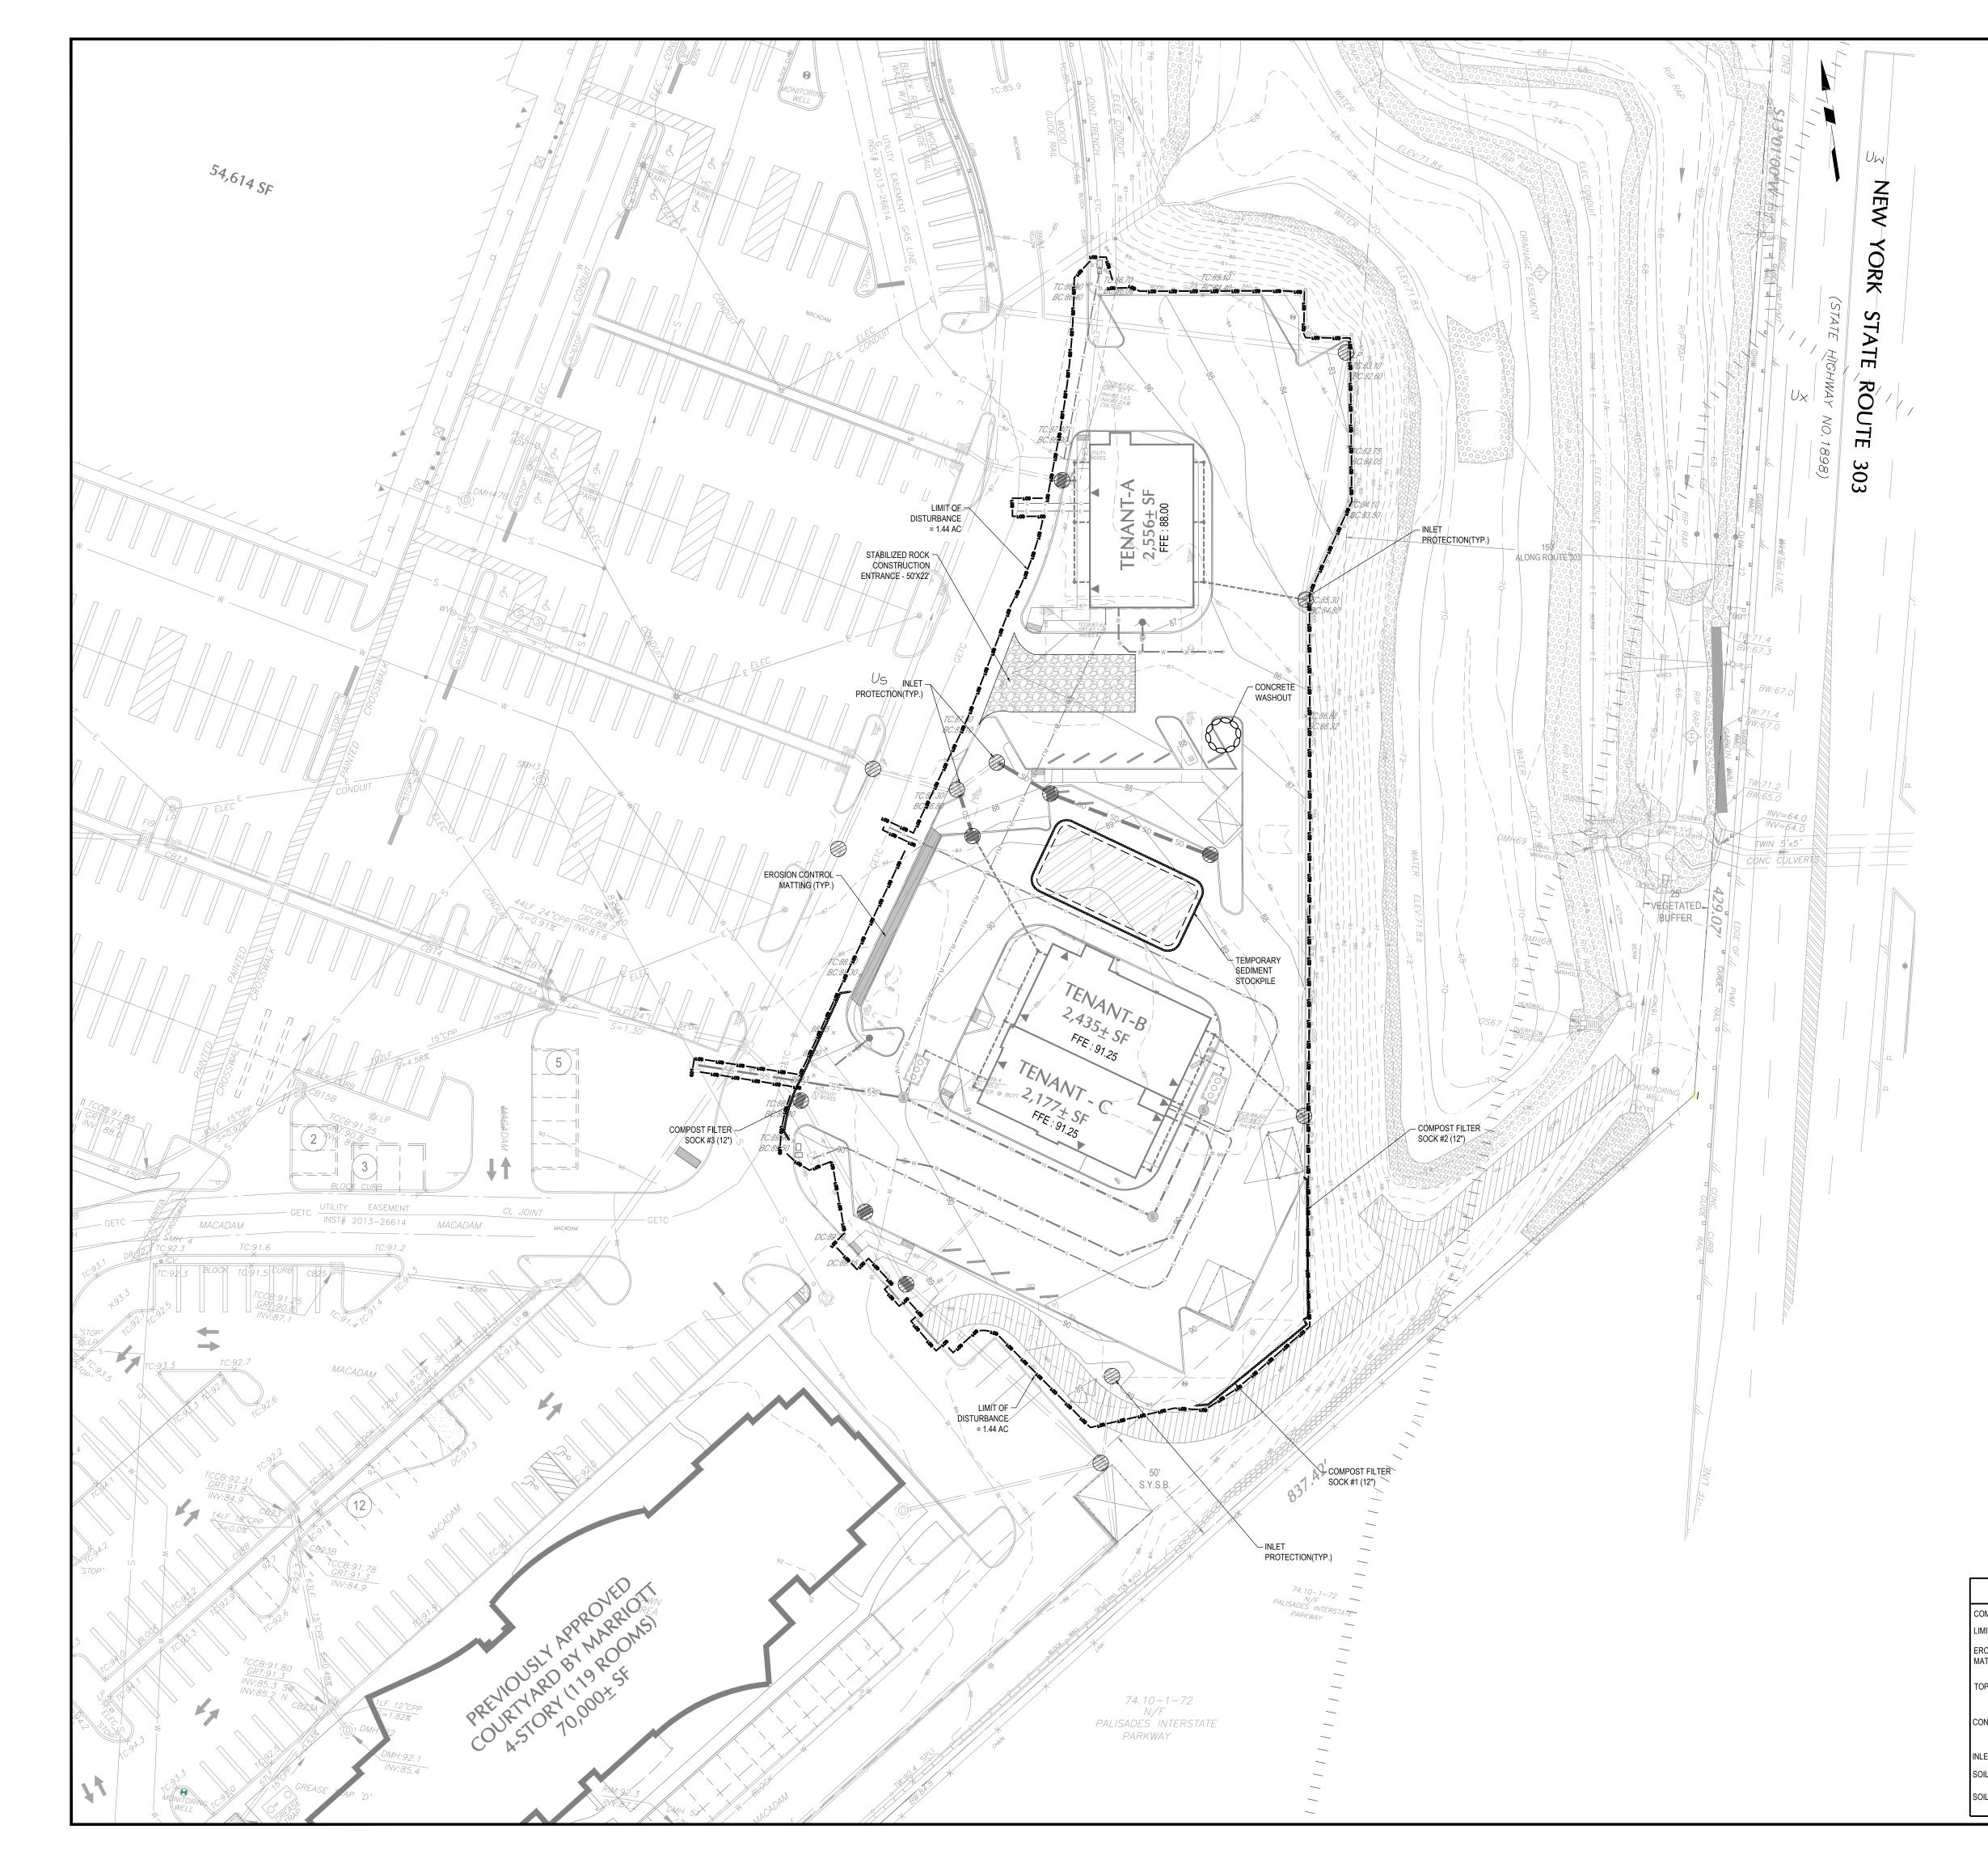


	Мар	ON	-SITE SOIL TYPE DESCRIPT	ION	Hydological	DITA		D
	Symbol		Soil		Soil Group		TT THAKKA INEERING, I	
	Us		Jdorthents, Smoothed		А	1456 F	Ferry Road,	
	Ux	Ude	orthents, Wet Sabstratun	n	А	Suite Doyles	603 stown, PA 18901	
	Uw		Urban Land		-	T: 215	.766.8280 .434.5280	
]	1.210		
			ERMAL IMPACT					
		THROUG	SH NATURAL VEGETATION, AND COMPOST SWM FACILITY.					
			ECEIVING WATER					
		KI	CEIVING WATER. LOW		ATERSNED			
		MIT OF	DISTURBANCE =	= + 1 44 A	CRES			
				<u> </u>				
SEC	QUENCE O	F CONS	TRUCTION					
THE FC PLAN:	DLLOWING SEQUENCE	OF CONSTRUCTION	ON IS INDICATED ON THE EROSION	I AND SEDIMENT POI	LUTION CONTROL			
			ATED REPRESENTATIVE SHOULD					
OF RE	RANGETOWN'S DESIG	NATED REPRESE SITE CONTRAC	PRE-CONSTRUCTION MEETING ENTATIVE, ON-SITE, PRIOR TO TOR, PROJECT ENGINEER, ORA PERSONNEL SHOULD ATTEND. TH	EARTH DISTURBAN	CES. AN OWNER CONSERVATION			
ME	EETING.		NE, 6" DEEP AT THE LOCATION			Project		
IMI UN	MEDIATELY AFTER IN IDERLAIN BY FILTER F	NITIAL DISTURBAI FABRIC, SEE DETA	NCES AS PER STANDARDS ON IL ON CE-501. TRAFFIC SHOULD U THESE LOCATIONS MAY BE MODIF	DRAWINGS. GRAVE SE ONLY THESE AR	_ BUFFER TO BE EAS FOR INGRESS		NGEBUR	G
OF	ORANGETOWN'S DES	SIGNATED REPRES					MONS	
INI YC	DICATED ON DRAWIN DRK GUIDELINES FOR	G CE-100. METHO URBAN EROSION	D OF INSTALLATION AND MAINT AND SEDIMENT CONTROL REQUI THE CONSTRUCTION ENTRANCES	ENANCE IN ACCORI REMENTS AND AS II	NANCE WITH NEW			
DE	TAILS ON SHEET CE	-501) AT THE INC	ICATED LOCATIONS SHOULD BE IT THE EXTENT OF CLEARING AS	DONE PRIOR TO A	NY OTHER EARTH		ORANGETOWN D COUNTY N	IEW YORK
			IOLITION OF THE EXISTING IMPER SION AND REMOVE THE EXISTING			Drawing T		
			E HAVE BEEN INSTALLED. EDIMENT CONTROL MEASURES, IN	ICLUDING STOCKPIL	E AREA AND TREE		DSION ANE)
	COTECTION FENCES(IF	,	FROM THIS POINT ON MAY BE PE	RFORMED CONCUR	RENTLY WITH ANY	_	DIMENT	
SE		OUSLY BUT SHALL	QUENCE. THE CONTRACTOR MAY NOT BE PERMITTED TO MOVE ON					
	EAR AND GRUB AREA	S CONTAINING VE	GETATION WITHIN THE LIMITS OF I	DISTURBANCE AS RE	QUIRED TO BEGIN		TEOFNE	1
TH			BITE. THE EARTH MOVING ACTIVITY S OF FILL. PLACE EXCESS FILL MA				S AND AJAY	Contra Contra
9. PL	ACE TOPSOIL IN AREA		N THE PLAN. ADD A MINIMUM OF A HEVER IS GREATER) TO FINAL SITI					(F) *))
NA		· ·	. MATTING IN ALL FILL AREAS WITH				JAY BHATT	
DR		HE PROPOSED CA	R CONVEYANCE SYSTEM, CONT TCH BASIN. ADVANCE TRENCH EX D IN THE SAME DAY.			PROFESS NEW YOF	SIONAL ENGINEERESSIO RK LIC. No. 095707	WAL
11. BE	GIN FOUNDATION AND	CONSTRUCTION	OF BOTH BUILDINGS.					
EL TH	ectric, telephone, Ie length of pipe	WATER, AND SA THAT CAN BE	'ILITIES. ON-SITE SUBSURFACE NITARY SEWER. ADVANCE TRENC COMPLETED IN THE SAME DAY	H EXCAVATION SHA . ON THE DAY FO	LL BE LIMITED TO LLOWING UTILITY	30	0 10	30
OF	DISTURBED AREAS S	HALL BE COMPLE	BE GRADED TO SUB-GRADE ELE TED AT THE END OF EACH WEEK.				SCALE IN FEET	
IMI	PROVEMENTS.		JRBING IN PARKING AREAS, DRIVE					
PE	RMITTED TO MOVE OF	NTO THE NEXT AR	RATE STEPS IN THIS SEQUENCE S EA IN THE SEQUENCE UNTIL THE P .PPROPRIATE AREAS TO AREA IND	REVIOUS AREA IS S	TABILIZED.			
OF	8 INCHES OF TOP SO	OIL OR THE DEPT	HOR THE EXISTING TOP SOIL (WE NT SEED AND MULCH.					
CC		ERMANENTLY STA	THE SITE. ONCE THE FINE GRA BILIZE THE SITE AND INSTALL TH		,			
17. CC AL	DNSTRUCTION ENTRA	NCES, COMPOST	FILTER SOCKS, AND INLET PROT MPLETED, AND 70% UNIFORM PER					
BE 18. WI	EN ESTABLISHED.	OM THE TOWN (DF ORANGETOWN'S DESIGNATED	REPRESENTATIVE	AND AFTER ALL			
SC	CKS, AND INLET PRO	TECTION. ALL DI	TALLED, REMOVE THE CONSTRUC STURBED AREAS CAUSED BY THE PERMANENTLY STABILIZED.	,				
			EXISTING SYMBOLS & LINES		MBOLS & LINES	DATE	COMMENTS	NO.
					ITE IE		REVISIONS	
				CURB LINE CURB LINE DEPRESSED TRAFFIC SIG	N	Project I	No. 23	30002801
	SION LEGE		PROPERTYRIGHT-OF-WAY LINE OPPERTYRIGHT-OF-WAY LINE UTILITY EASEMENT CONTOUR LINE HYDRANT HYDRANT	Giberting RC	R FACILITY	Date	AUGUST	17, 2023
POST FILTER SOCK			c→→ STREET LIGHT ⊕ ♥ ■ → → AREA LIGHT ■ → SIGNAL POLE + POLE	165 PARKING CC ▼ DOOR ● BOLLARD	UNT TOTAL	Scale		1" = 30'
	— LOD —— LOD	LOD	ダンドン・ANCHOR POLE ② S ② ② ● MANHOLE (TYPE AS LABELED) 桜 WATER VALVE ③ GAS VALVE		BASIN	Drawn E	Зу	AG
SION CONTROL TING (NAG S75)	م م	.00	UNKNOWN VALVE UNKNOWN VALVE CATCH BASIN AD22.39 SPOT ELEVATION CLEAN OUT		VERLAY CONTOUR RADE	Checked	Ву	СТ
SOIL STOCKPILE			CLEAN OUT	X BC 177.50 BOTTOM X BOC 177.50 BACK O		Drawing	No.	
CRETE WASHOUT	\bigcirc)	Image: Metal cover Image: Electric box △ Door	HEADW/	LITY		E-100	
T PROTECTION	۲		DOUBLE DOOR GARAGE DOOR COR C	GAS LINE	- E & ELECTRIC LINE			
S LIMITS S TYPE	Us		EXISTING TREE	CLEANOUT SANITARY SS SS PROPOSED	MANHOLE SANITARY PIPE ELECTRIC TRANSFORMER			
-	03			_	ELECTRIC TRANSFORMER	Sheet	8 of 16	

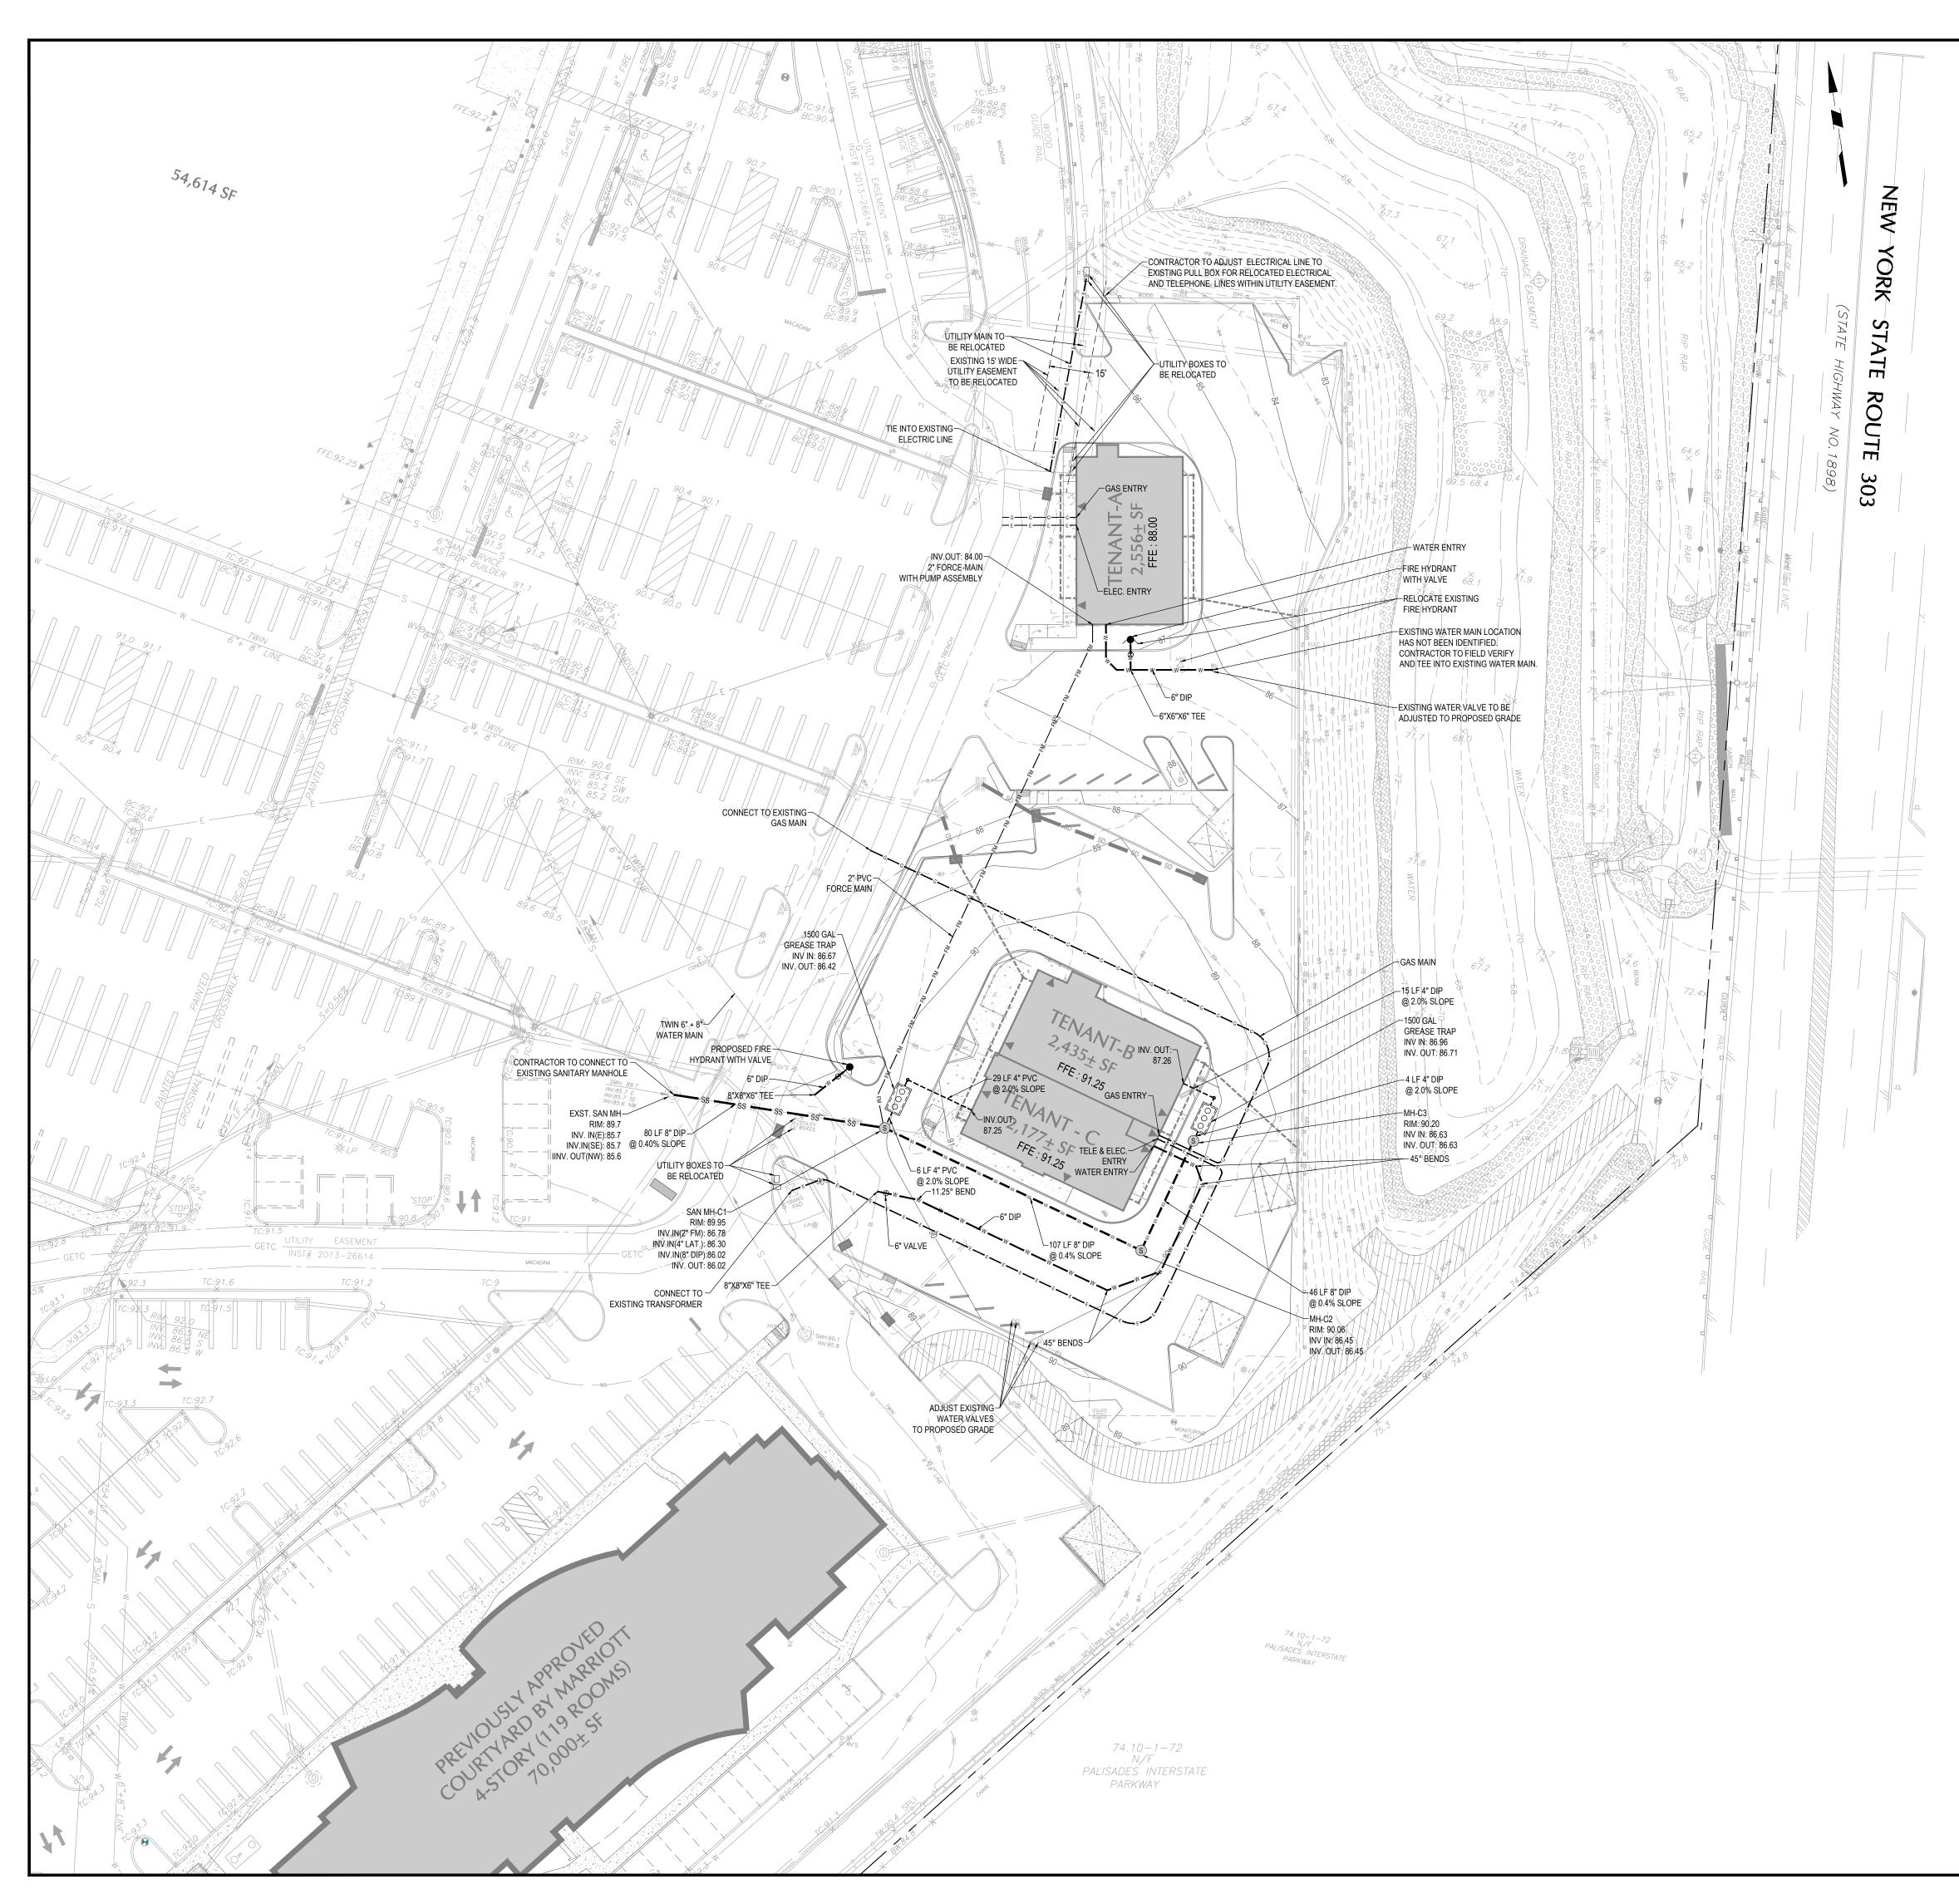

<u>U1</u> 1. 2. 3. 4.	 ILITY NOTES: ALL UTILITY SERVICES TO BE COORDINATED WITH ARCHITECTURAL DRAWINGS AND SHALL BE INSTALLED IN ACCORDANCE WITH THE REQUIREMENTS OF THE RESPECTIVE SERVICE PROVIDER. THE CONTRACTOR IS RESPONSIBLE FOR OBTAINING, REVIEWING AND ADHERING TO THESE RULES AND REGULATIONS PRIOR TO SITEWORK BID AND DURING THE COURSE OF CONSTRUCTION. ALL TELEPHONE, ELECTRICAL, TELEVISION AND COMMUNICATION FACILITIES, BOTH MAIN AND SERVICE LINES, SHOULD BE UNDERGROUND. CONTRACTOR SHALL COORDINATE INSTALLATION OF UTILITIES IN SUCH A MANNER AS TO AVOID CONFLICTS AND ASSURE PROPER DEPTHS ARE ACHIEVED AS WELL. AS COORDINATING WITH THE REGULATORY AGENCY AS TO LOCATION AND SCHEDULING OF CONNECTIONS TO THEIR FACILITIES. ALL DUCTILE IRON PIPE AND FITTINGS FOR WATER SERVICES SHALL BE CEMENT LINED IN ACCORDANCE WITH ANSI A21.51 (AWWA C151). CONTRACTOR MUST PROVIDE A SUBMITTAL TO OWNER'S ENGINEER PRIOR TO ORDERING OR CONSTRUCTION. PROVIDE EIGHTEEN INCHES (18") OF CLEARANCE BETWEEN BOTTOM OF WATER PIPE AND TOP OF SANITARY SEWER CROSSING ABOVE A PVC SANITARY SEWER/LATERAL OR CONSTRUCT A CONCRETE CRADLE. MINIMUM VERTICAL CLEARANCE SHALL BE NO LESS THAN TWELVE INCHES (12") WITH A CONCRETE CRADLE AND PVC. MINIMUM VERTICAL CLEARANCE SHALL BE NO LESS THAN SIX INCHES (6") WITH CONCRETE CRADLE AND DUCTILE IRON PIPE. 	BHATT THAKKAR ENGINEERING, DPC 1456 Ferry Road, Suite 603 Doylestown, PA 18901 T: 215.766.8280
5.	THE CONTRACTOR SHALL PROVIDE THREE (3) SETS OF AS-BUILT PLANS CONFORMING TO THE AUTHORITY'S "AS-BUILT" DRAWINGS REQUIREMENTS. THE PLANS MUST SHOW THE NEW WATER AND SANITARY SEWER SYSTEMS AND INCLUDE THE PORTION OF THE EXISTING SYSTEMS WHERE THEY TIE INTO. THE PLANS MUST BE SIGNED AND SEALED BY A NEW YORK LICENSED LAND SURVEYOR. IN ADDITION TO THE THREE (3) PAPER COPIES, THE CONTRACTOR MUST PROVIDE A DISK OR CD IN AUTOCAD FORMAT OF THE SUBMITTED	F: 215.434.5280
6.	PLANS. ALL WATER MAINS AND SANITARY SEWER LINES SHALL BE SEPARATED BY A HORIZONTAL DISTANCE OF 10 FEET. IF SUCH HORIZONTAL SEPARATION IS NOT POSSIBLE, THE WATER AND SEWER LINES SHALL BE IN SEPARATE TRENCHES WITH THE TOP OF THE SEWER LINE AT LEAST 18 INCHES BELOW THE BOTTOM OF THE WATER MAIN OR WITH SUCH OTHER SEPARATION EXPRESSLY APPROVED BY THE MUA ENGINEER. AT CROSSINGS OF SEWER AND WATER MAINS, THE TOP OF THE SEWER LINES SHALL BE AT LEAST 18 INCHES BELOW THE BOTTOM OF THE WATER MAIN (SEWER SERVICE LATERALS ARE NOT SUBJECT TO THIS REQUIREMENT). IF SUCH VERTICAL SEPARATION IS NOT POSSIBLE, THE SEWER SHALL BE CONSTRUCTED OF DUCTILE IRON PIPE WITH "PUSH-ON" OR MECHANICAL JOINTS FOR A DISTANCE OF 10 FEET ON EITHER SIDE OF CROSSING	
7.	THE LOCATION OF EXISTING UTILITIES (I.E. ELECTRIC. TELEPHONE, GAS, SEWER & WATER) ARE APPROXIMATE. CONTRACTOR SHALL COORDINATE INSTALLATION OF UTILITIES IN SUCH A MANNER AS TO AVOID CONFLICTS AND ASSURE PROPER DEPTHS ARE ACHIEVED AS WELL AS COORDINATING WITH THE REGULATORY AGENCY AS TO LOCATION AND SCHEDULING OF CONNECTIONS TO THEIR FACILITIES. ALL UTILITIES (INCLUDING APPURTENANCES) MUST BE CONSTRUCTED IN CONFORMANCE WITH APPLICABLE LOCAL, COUNTY, STATE AND FEDERAL GUIDELINES, RULES, STANDARDS AND REQUIREMENTS. THE CONTRACTOR IS RESPONSIBLE FOR OBTAINING, REVIEWING AND ADHERING TO THESE RULES AND REGULATIONS PRIOR TO SITEWORK BID AND DURING THE COURSE OF CONSTRUCTION.	
8.	THE CONTRACTOR SHALL COORDINATE THE SANITARY SEWER AND WATER WORK WITH THE ORANGE COUNTY SEWER DISTRICT AND VILLAGE OF HARRIMAN RESPECTIVELY. THE CONTRACTOR IS RESPONSIBLE FOR OBTAINING, REVIEWING AND ADHERING TO ALL REQUIREMENTS, DETAILS AND RULES & REGULATIONS PRIOR TO SITEWORK BID AND DURING THE COURSE OF CONSTRUCTION. CONTRACTOR IS CAUTIONED THAT UTILITY DETAILS PROVIDED ON THE LAND DEVELOPMENT SET ARE FOR INFORMATIONAL PURPOSES ONLY.	
9. 10. 11.	BUILDING UTILITIES ARE TO BE STUBBED WITHIN 5' OF BUILDING. REFER TO ARCHITECTURAL PLANS FOR EXACT LOCATION AND SIZE OF UTILITY TIE IN TO THE PROPOSED BUILDINGS. PHONE, ELECTRIC AND GAS SERVICES INDICATED ON THE PLANS ARE FOR INFORMATION ONLY. THE LOCATION OF THESE FACILITIES ARE TO BE VERIFIED, BY RESPECTIVE SERVICE PROVIDERS. CONTRACTOR MUST NOTIFY OF ANY UTILITY CONFLICTS TO THE OWNER AND OWNER'S ENGINEER IN WRITING PRIOR TO ORDERING MATERIAL OR CONSTRUCTION. ANY COST ASSOCIATED WITH CURING OR REMEDY THE UTILITY CONFLICTS DISCOVERED AFTER ORDERING OF THE MATERIAL OR COMMENCEMENT OF CONSTRUCTION SHALL BE	
12.	RESPONSIBILITY OF THE CONTRACTOR. THE PROJECT ARCHITECT WILL PROVIDE THE DETAILED FIRE SPRINKLER SYSTEM DRAWINGS PRIOR TO OBTAINING BUILDING PERMITS AND COORDINATE THE FIRE DEPARTMENT CONNECTIONS WITH THE MONROE JOINT FIRE DISTRICT.	
13. 14. 15.	ALL TRANSFORMER/METER PIT/GREASE TRAP, ETC., LOCATIONS, DETAILS AND SPECIFICATION SHALL BE COORDINATED BY THE MEP. WATER SERVICE METERS SHALL BE PER MONROE TOWNSHIP MUA SPECIFICATIONS AND DETAILS. THE CONTRACTOR IS RESPONSIBLE FOR OBTAINING, REVIEWING AND ADHERING TO THESE RULES AND REGULATIONS PRIOR TO SITEWORK BID AND DURING THE COURSE OF CONSTRUCTION. CONTRACTOR TO INSTALL SANITARY LATERALS WITH A INSULATION JACKET ACCEPTABLE BY THE UTILITY PROVIDER WHERE LESS THAN 3 FEET OF COVER IS PROPOSED FOR THE	
16.	CONTRACTOR TO INSTALL SANITARY LATERALS WITH A INSOLATION JACKET ACCEPTABLE BY THE UTILITY PROVIDER WHERE LESS THAN SPEET OF COVER IS PROPOSED FOR THE LATERALS. THE LOCATION & DETAILS OF ALL PROPOSED FIRE HYDRANTS SHALL BE APPROVED BY THE ADMINISTRATIVE AUTHORITY HAVING JURISDICTION THEREOF. ALL EXISTING FIRE HYDRANTS SHALL BE TESTED PRIOR TO CONSTRUCTION. THE CONTRACTOR IS RESPONSIBLE FOR OBTAINING, REVIEWING AND ADHERING TO THESE RULES AND REGULATIONS PRIOR TO SITEWORK BID AND DURING THE COURSE OF CONSTRUCTION.	
17. 18.	ALL GRAVITY SANITARY SEWER MAINS AND LATERALS SHALL BE ABS PIPE CONFORMING TO ORANGE COUNTY SEWER DISTRICT REQUIREMENTS. MINIMUM COVER OVER ABS SANITARY SEWER MAINS AND LATERALS SHALL BE THREE (3) FEET. MINIMUM COVER OVER DUCTILE IRON SANITARY SEWER MAINS AND LATERALS SHALL BE THIRTY (30) INCHES. IN NO INSTANCE SHALL THE COVER BE LESS THAN 30 INCHES.	40 0 20 40
19. 20.	CONTRACTOR SHALL BE RESPONSIBLE FOR OBTAINING ALL APPLICABLE APPROVALS & PERMITS FROM THE JURISDICTIONAL AGENCIES PRIOR TO COMMENCEMENT OF WORK.	SCALE IN FEET
21.	THEY ARE FLUSHED WITH THE FINAL GRADES. THE CONTRACTOR MUST NOTIFY UTILITIES COMPANIES PRIOR TO COMMENCEMENT OF CONSTRUCTION OR EXCAVATION.	Project
22. 23. 24.	ROUTING AND LAYOUT OF ALL UTILITIES SHOWN ON THIS PLAN IS SUBJECT TO ADJUSTMENT TO MEET UTILITY PROVIDER REQUIREMENTS AND COORDINATION WITH BUILDING MECHANICAL DESIGN. CONTRACTOR MUST REFER TO SITE LIGHTING ELECTRICAL PLANS PREPARED BY OTHERS FOR SITE ELECTRIFICATION. ELECTRIC LINES SHOWN ON THIS PLAN ARE ANTICIPATED LINE ROUTING, SUBJECT TO ADJUSTMENTS PER NOTE 5 ABOVE. ALL PROPOSED WATER MAINS SHALL HAVE A 20 FT WIDE EASEMENT CENTERED OVER THE LINE. EXISTING WATER EASEMENTS ARE TO BE ADJUSTED FOR UTILITY CHANGES	ORANGEBURG COMMONS
	SHOWN ON THIS PLAN. TELEPHONE, ELECTRIC AND GAS	
	LINES SHOWN ON THIS PLAN ARE ANTICIPATED LINE ROUTES WHICH ARE SUBJECT TO ADJUSTMENT PER	TOWN OF ORANGETOWN ROCKLAND COUNTY NEW YORK Drawing Title
	UTILITY PROVIDER. FINAL UTILITY SIZES AND LOCATION ARE TO BE COORDINATED WITH RESPECTIVE	Drawing hue
	UTILITY PROVIDER AND PROJECT MEP DESIGNER.	UTILITY PLAN
	IN THE AREAS OF EXCAVATION, ALL EXISTING UTILITIES TO REMAIN SHALL BE CHECKED FOR PROPER	
	COVER AS REQUIRED BY THE UTILITY OWNER. SHOULD MINIMUM COVER NOT EXIST, THE	TE OF NEW
	CONTRACTOR SHALL BE RESPONSIBLE TO COORDINATE WITH THE RESPECTIVE UTILITY	STATUS AVAIL OF
	PROVIDER TO ADJUST THE UTILITIES TO PROVIDE PROPER COVER.	
	TOPSOIL EXCAVATED FROM THE SITE DURING CONSTRUCTION SHALL BE RE-SPREAD ON SITE IN THE PERVIOUS AREAS. NO TOPSOIL SHALL BE EXPORTED OFF-SITE	ANAND AJAY BHAT PROFESSIONAL ENGINEERESSIONAL NEW YORK LIC. No. 095707
	BACKFILLING OF ALL PROPOSED UTILITY TRENCHES, INCLUDING BUT NOT LIMITED TO STORM, WATER, SANITARY, ELECTRIC AND GAS SHALL UTILIZE DENSE GRADED AGGREGATE ABOVE THE	30 0 10 30 SCALE IN FEET
	PIPE CRADLE WHEN BACKFILLING WITHIN PAVEMENT AREAS.	
	CONTRACTOR MUST COMPLY WITH ALL ORANGE COUNTY SEWER DISTRICT 1 RULES, REGULATIONS, SPECIFICATIONS AND DETAILS.	
	EXISTING SYMBOLS & LINES PROPOSED SYMBOLS & LINES	DATE COMMENTS NO.
	Sanitary LINE	REVISIONS
	OH OVERHEAD WIRE OUCERHEAD WIRE	Project No. 230002801
	CONTOUR LINE STORMWATER FACILITY STORMWATER FACILITY CURB RAMP STORMWATER FACILITY CURB RAMP STORMWATER FACILITY STORMWATER FACILITY CURB RAMP STORMWATER FACILITY	AUGUST 17, 2023 Scale 1" = 30'
	SIGNAL POLE ● BOLLARD → POLE GRADING AND DRAINAGE ∅ ≤ @@○ MANHOLE (TYPE AS LABELED) ∅ SD → STORM PIPE ∅ VATER VALVE	Drawn By AG
	B GAS VALVE CALCH BASIN □ UNKNOWN VALVE INFORM MANHOLE □ CATCH BASIN INFORM MANHOLE 0 CATCH BASIN INFORM MANHOLE 0 SPOT ELEVATION INFL & OVERLAY CONTOUR 2522.5 CLEAN OUT X 17750 2620.00 CLEAN OUT X 17750	Checked By CT
	TREE X TO P OF CURB ELEVATION BM-7 BENCH MARK X 80 177.30 BOTTOM OF CURB ELEVATION SIGN SIGN COLUBE ALEVATION BOLLARD FLOW ARROW	Drawing No.
	Image: Mining Strest Image: Mining Strest Image: Mining Strest Image: Mining Strest	CU-100
	CLEANOUT CLEANOUT SUTTARY MANHOLE T PROPOSED SANITARY PIPE T PROPOSED ELECTRIC TRANSFORMER EI PROPOSED ELECTRIC JUNCTION BOX	Sheet 10 of 16
	LEJ PROPOSED ELECTRIC JUNCTION BOX	

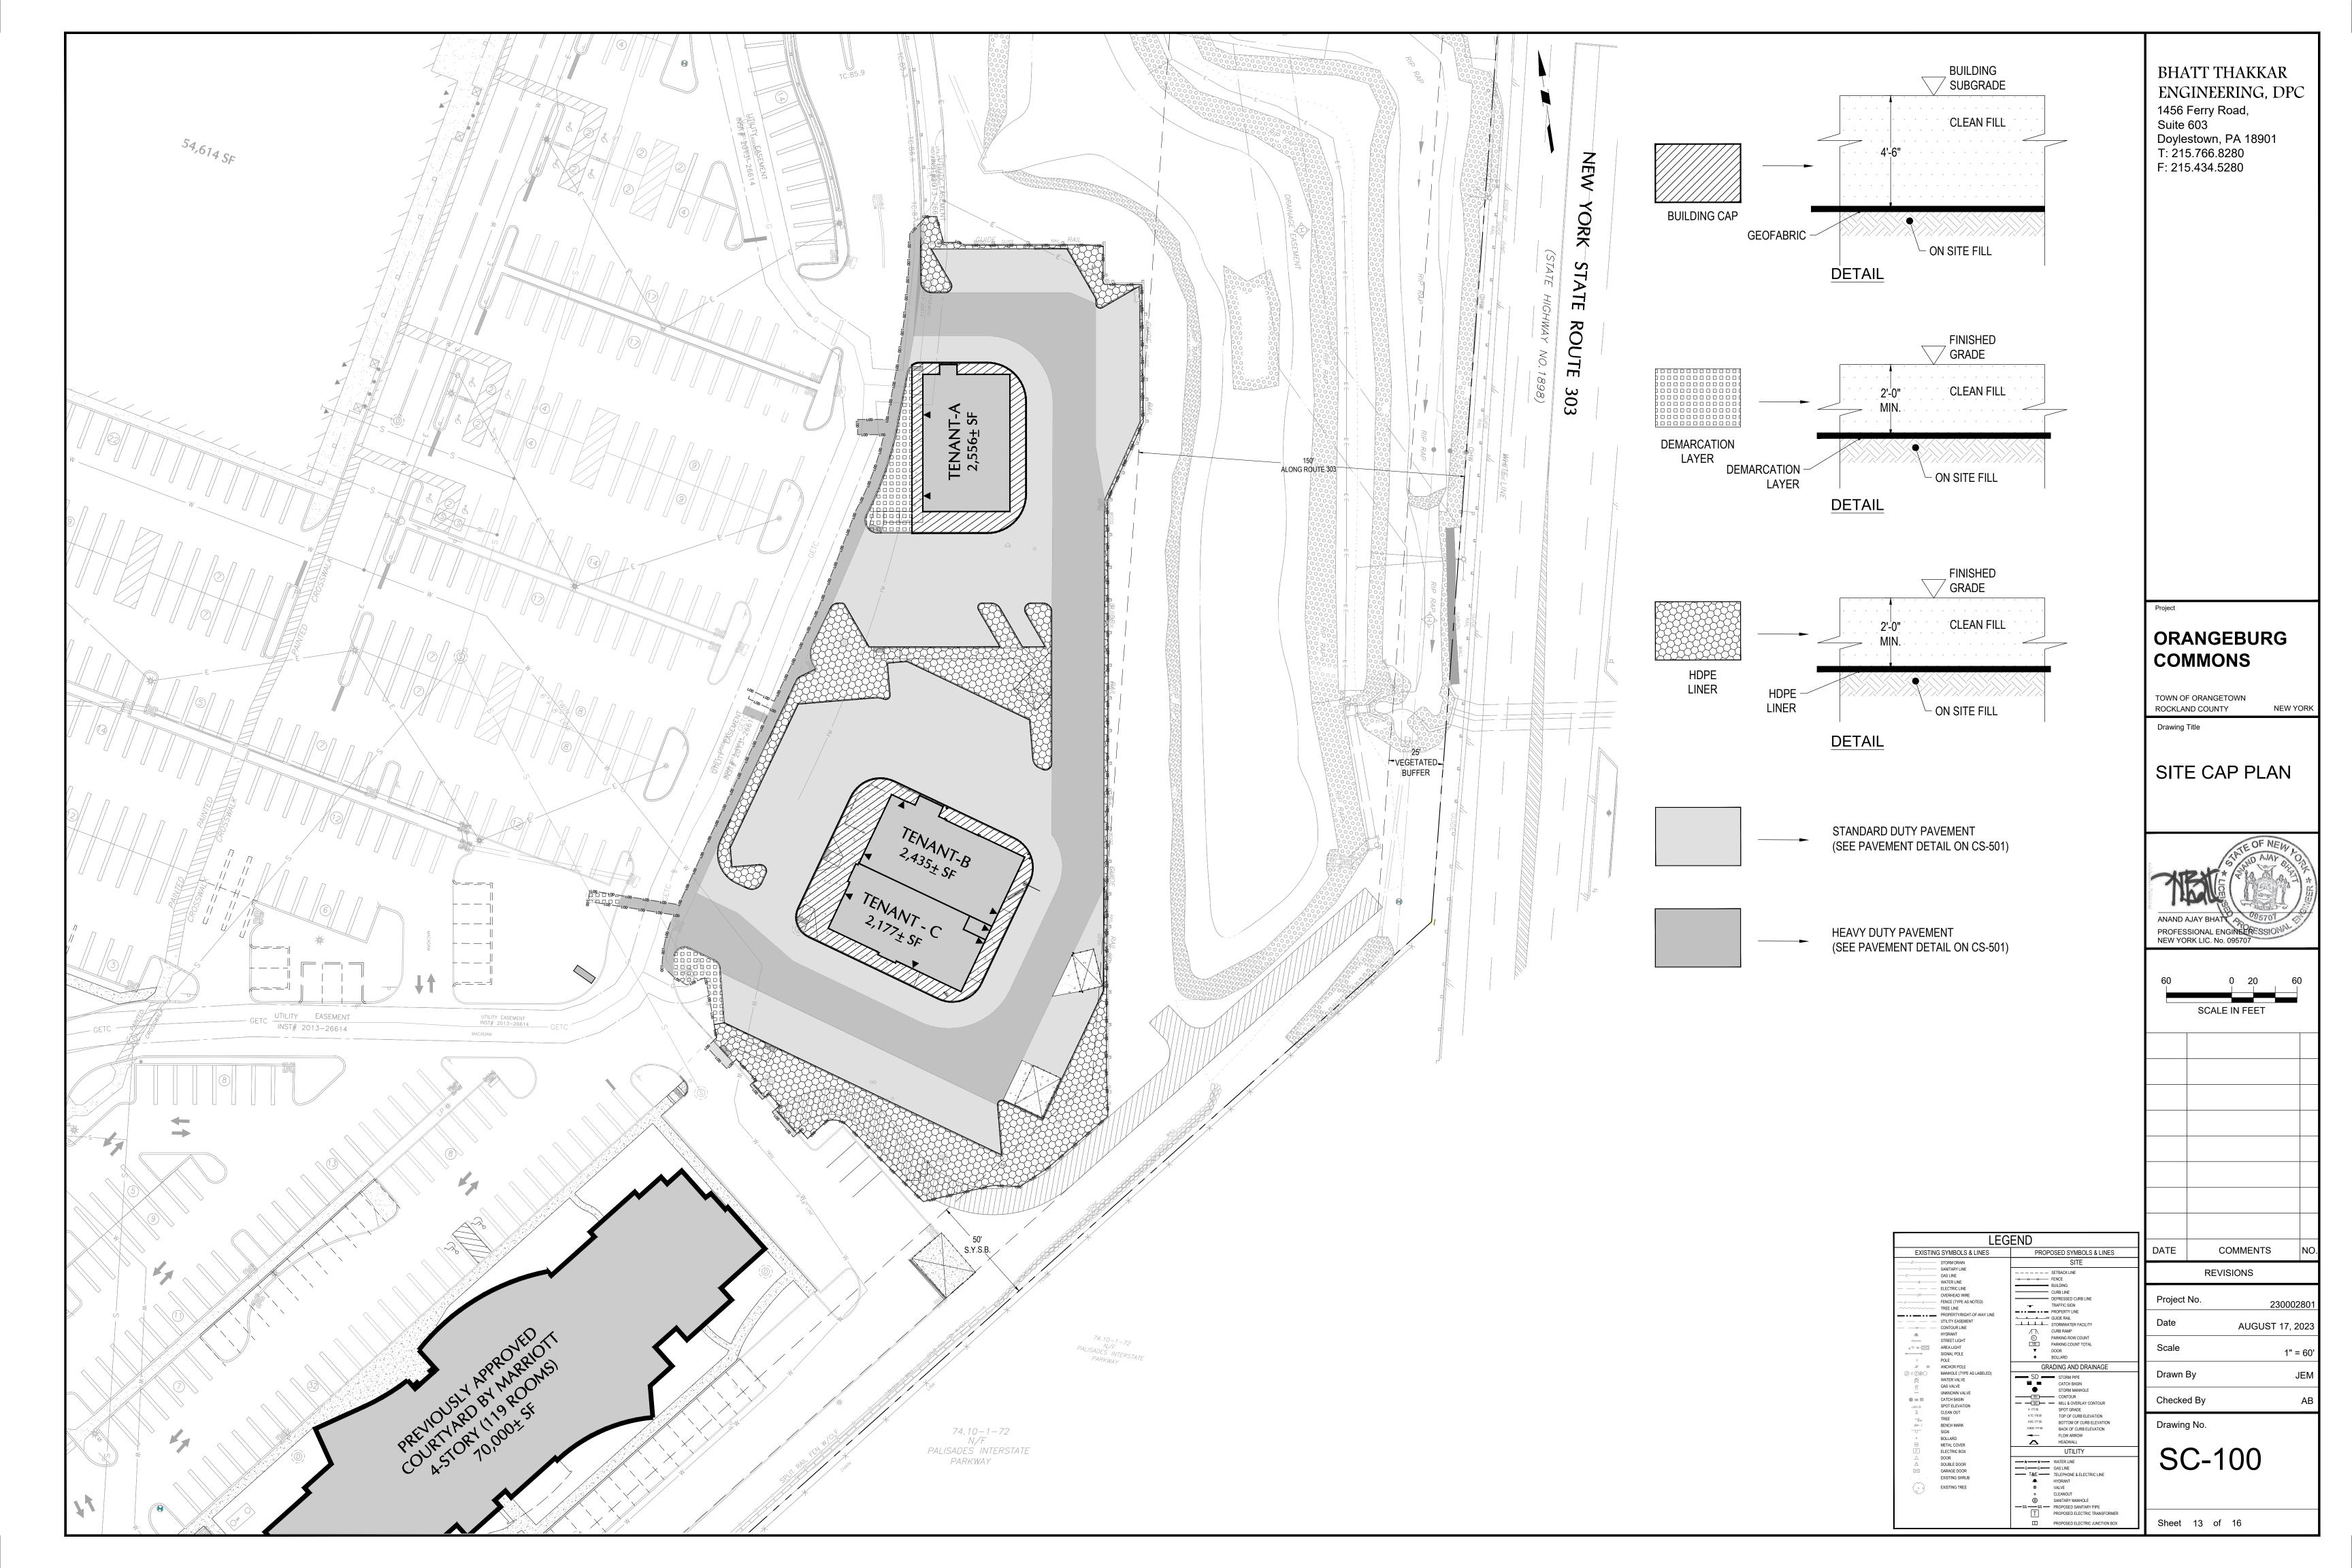

BIE SOLENTE TO MARE COMMON NAME OT/L SIZE AVGG Lor Adams: Under Gray State State State State 3 227-32 BIE State		RIAL SCHEDULE					
4033 Aven dutus College Diagni Apple E 2.9 - 3.0" GTE Kennel Transmission Staturnization Staturnization Staturnization GTE Collect Costines Staturnization Staturnization Staturnization PR04 Proceedings Staturnization TOTA 19 PR04 Proceedings Staturnization Staturnization Staturnization M04 Proceedings Write Sprace TOTA 19 Staturnization M04 Proceedings Write Sprace TOTA 10 Staturnization M04 Proceedings Write Sprace TOTA 10 Staturnization M04 Proceedings Write Sprace TOTA 10 Staturnization M05 OverShite Staturnization 10 24 24* 30* 30* M05 OverShite Staturnization TOTA 10 20 10 10 10 10 10 10 10 10 10 10 <		SCIENTIFIC NAME	COMMON NAME	<u>QTY.</u>	SIZE		
BTS Status Souther Color 0.2 Jakenia Coloriva Souther Color 1076. 0.2 Jakenia Coloriva Souther Color 1076. PEL Formation Coloriva Souther Color 1076. PEL Formation Coloriva TOTEL 16 PEL Formation Coloriva TotEL 1 PEL Formation Coloriva TotEL 1 PEL Formation Coloriva TotEL 1 VEROBELINES TotEL 1 8.47.31 Pt VID TotEL 23 27.32 Pt VID Souther Andralis Places* TotEL 23 ECIONS SHUES TotEL 24 27.33 Pt Fill Souther Andralis Places* TotEL 23 ECIONS SHUES TotEL 1 3.64.1 Fill Souther Andralis Places* TotEL 5 Fill Souther TotEl 1 3.64.1 Fill Souther TotEl 5 5 5		Acer Rubrum 'October Clear'	October Clony Red Maple	6	ר איי איי איי איי איי איי איי איי איי אי		
USB Juence Statistication Biodefinitian Protocol III Biodefinitian Protocol III Biodefinitian Protocol III Biodefinitian Protocol IIII Biodefinitian Protocol IIIIIIIIIIIIIIIIIIIIIIIIIIIIIIIIIII						& La h	
REDERING TOPAL 16 PG. Jones doos Weisson Weis Drace 1 6-17 H PS Jones doos Weisson Weis Drace TOTAL 1 DP Mora Avorance Weisson Weis Drace 1 8-17 H DP Mora Avorance Total 1 8-17 H VRS Mora Avorance Total 1 8-17 H VRS Mora Avorance Total 1 8-17 H VRS Mora Avorance Total 24 24' - 30' H VRS Moran Avorance Door Loaderoal Victurum 4 24' - 30' H VRS Moran Avorance Door Loaderoal Victurum 4 364. FIND Mercellia Avorance Note of Provision 00 graphed B' Oo. No Mercellia Avorance Note of Provision 00 graphed B' Oo. No Mercellia Avorance Note of Provision 00 graphed B' Oo. No Mercellia Avorance Note of Provision 00 graphed B' Oo. <td>GTIS</td> <td></td> <td>Shademaster HoneyLocust</td> <td>6</td> <td>2.5" - 3.0"</td> <td></td> <td></td>	GTIS		Shademaster HoneyLocust	6	2.5" - 3.0"		
CENCENT TREES PG. POL Formation of the source o	QC	Quercus Coccinea			2.5" - 3.0"		
Pol. Pols Pols Number of Maile Structure 1 8-10 Hz TOTAL 1			TOTAL	18			
PS Proc Stabus Wastern Wills Fire B-10 Hi VEX.0EEM SHRUBS Intrime Region // 10 00 - 385 Hi 00 - 385 Hi VP Webrie Procynological or Coard Creat Lastrated Vicurum 1 5 24 - 307 Hi VRC Region // 10 - 20 Creat Lastrated Vicurum 1 5 24 - 307 Hi VRC Region // 10 - 20 Creat Lastrated Vicurum 1 5 24 - 307 Hi FRG Antriva Anadali "Reset" Prick Summersonal Contra 24 24 - 307 Hi FRG Antriva Anadali "Reset" Prick Summersonal Contra 24 - 307 Hi 10 - 30 - 24 Hi FRG Antriva Anadali "Reset" Prick Summersonal Contra 24 - 307 Hi 10 - 30 - 32 Hi FRG Antriva Anadali "Reset" Prick Summersonal Contra 24 - 307 Hi 10 - 30 - 30 - 30 - 30 - 30 - 30 - 30 -			White Spruce	1	Q 101 LI4		
IDTAL 1 60° Morce Provewaver: Nurheen Baytony 18 32°-30°-94. VRC Morce Provewaver: Torse 'Lashedal Yldururun 6 24°-30°-94. VRC September Auforse 'Touse' Torse 'Lashedal Yldururun 6 24°-30°-94. 10 CODUS SHRUES				I			
ERGEN SHUBS Implementation Implementa				1			
MP Mytics Prescywarch Noffer ift Baybarry 18 32* 36* HL VPC Myticsportune Coart Ladineral Vitorrun 5 24* -30* HL VPC Myticsportune Coart Ladineral Vitorrun 5 24* -30* HL VPC Myticsportune Coart Ladineral Vitorrun 5 24* -30* HL VPC Myticsportune Coart Ladineral Vitorrun 15 24* -30* HL VPC Myticsportune Deart Fortugilia 101 15* -24* -30* HL HD Hytigsga Gaechical Baateler Hytigsgame 101 4 35 Statu Mytigsga Gaechical Baateler Hytigsgame 101 14 35 Statu LB Lidge Adactan * Stat Back Mytigs Baateler 63 5 65 C CA Caturesprate acchica Kat Forsheit 163 16 C 16 16 C						//////////////////////////////////////	
VRC Jest Markan, Care Tore * Leatherest Virunum 5 24*30*H TORL 23 CLIDOUS SHRUBS Control Attolutu *Recent Prink Burmersweit Centra 24 24*-30*H FG Soldward & Control Odder Försegleit 10 88*-30*H HO Markensile Carlina 12 24*-30*H HO Markensile Carlina 12 34*-30*H HO Markensile Carlina 13 364L HO Markensile Carlina 14 364L HO Markensile Carlina 16 364L KOND COVERS TORL 51 50 CA Caterospools acatification 164 164 164 LB Sepecial Bill 164 164 164 164 CA Caterospools acatificatin 164 164							/
UPL Phytotogenuture (Case) User Listing Real minimum 0 4 + -3.0 III TOTAL 28	MP		Northern Bayberry	18	30" - 36" Ht.		ED
Line Line <thline< th=""> Line Line <thl< td=""><td>VRC</td><td></td><td>"Cree" Leatherleaf Virburnum</td><td>5</td><td>24" - 30" Ht.</td><td></td><td></td></thl<></thline<>	VRC		"Cree" Leatherleaf Virburnum	5	24" - 30" Ht.		
CAR Detron Allindio Proced Data Summersweet Cothra 24 32*-07 Ht FG /rothogilla Galdoui Data Forhungilla 10 10 12*-24*-37 Ht HG Hydragea Councibia Disklad Fylangaa 12 22*-37 37 Ht HO Hydragea Councibia Disklad Fylangaa 12 24*-37 Ht HO Hydragea Councibia Disklad Fylangaa 10 24 3.04L HYD Hydragea Councibia Disklad Fylangaa 10 3.04L HYD Hydragea Councibia Disklad Fylangaa 10 10 10 LB Monore Moncer Big Blue: LighTout 80 1004L 14 LB Moncer Big Blue: LighTout 10 10 10 LB Moncer Big Blue: LighTout 14 10 10 LB Moncer Big Blue: LighTout 10 10 10 LB Moncer Big Blue: LighTout 10 10 10			TOTAL	23	1		
CAR Deriva Altrificial 'Netad" Park i ammensed : Clerha iii 24 24' - 32' Ht FG Frain Traingelle Gardoni '' Deel Fichongilia 10 115' - 24' Ht 13' - 24' Ht H2 Hydrograp OuecRilla Cakkoff Hydrograp 1 24' - 32' Ht 3 (24' - 32' Ht IVD Kir Vorcillate 'Im Davd' Mae Bellinger Milling train Huly 1 3 (24' - 32' Ht IVD Kir Vorcillate 'Non Davd' Mae Bellinger Millinger Huly 1 3 (24' - 32' Ht IVD Kir Vorcillate 'Non Davd' Mae Bellinger Millinger Huly 1 3 (24' - 32' Ht IVD Kir Vorcillate 'Non South' TOTAL 51 10' Ht COUND COVERS 1 (3ai gazed 18' o.c. 1 (3ai gazed 18' o.c. 1 (3ai gazed 18' o.c. LB Linoph Maecan 'Say Slow' Big Bue LinyTurf 50 1 (3ai gazed 20' o.c. TOTAL H0 10' Ht 1 (3ai gazed 20' o.c. 1 (3ai gazed 20' o.c. 1 (3ai gazed 20' o.c. CA Calemagnetis auxifiori Karl Peeris / 1 (3ai gazed 20' o.c. 1 (3ai gazed 20' o.c. CA Cal							
FG etergete General Date of There pila 10 10*-24* HL HG Hydrasge Datecolia Dotted Hydrasge at 12 24*-32* HL NUD Bit Vehicibies Wind Status Vehice 13 364. VPRS Bit Vehicibies Wind Status Vehice 13 364. VPRS Bit Vehicibies Wind Status Vehice 13 364. VPRS Bit Vehicibies Vehice Vehice 10 364. VOIA 51 Outbook 10 890. 10 CA Caleragrossis auctilica Kat Poencier 09 gazed 18* o.c. TOTAL 140 Vehice 140 140							
HQ Hydrarges Questione Dakked Hydrarges 12 24' - 30' H MUD Bit Voncklaus Jun Dandy Kale Polinator Winteherry Holy 1 3 GAL TOTAL 51 CA Catemagnostis acutotics (Signer Winstherry Holy 4) 3 GAL TOTAL 50 TOTAL CA Catemagnostis acutotics (Signer Winstherry Holy 4) TOTAL Advect For C.C. CA Catemagnostis acutotics (Signer Winstherry Holy 4) TOTAL Advect For C.C. CA Catemagnostis acutotics (Signer Winstherry Holy 4) TOTAL Advect For C.C. CA Catemagnostis acutotics (Signer Winstherry Holy 4) TOTAL Advect For C.C. TOTAL							

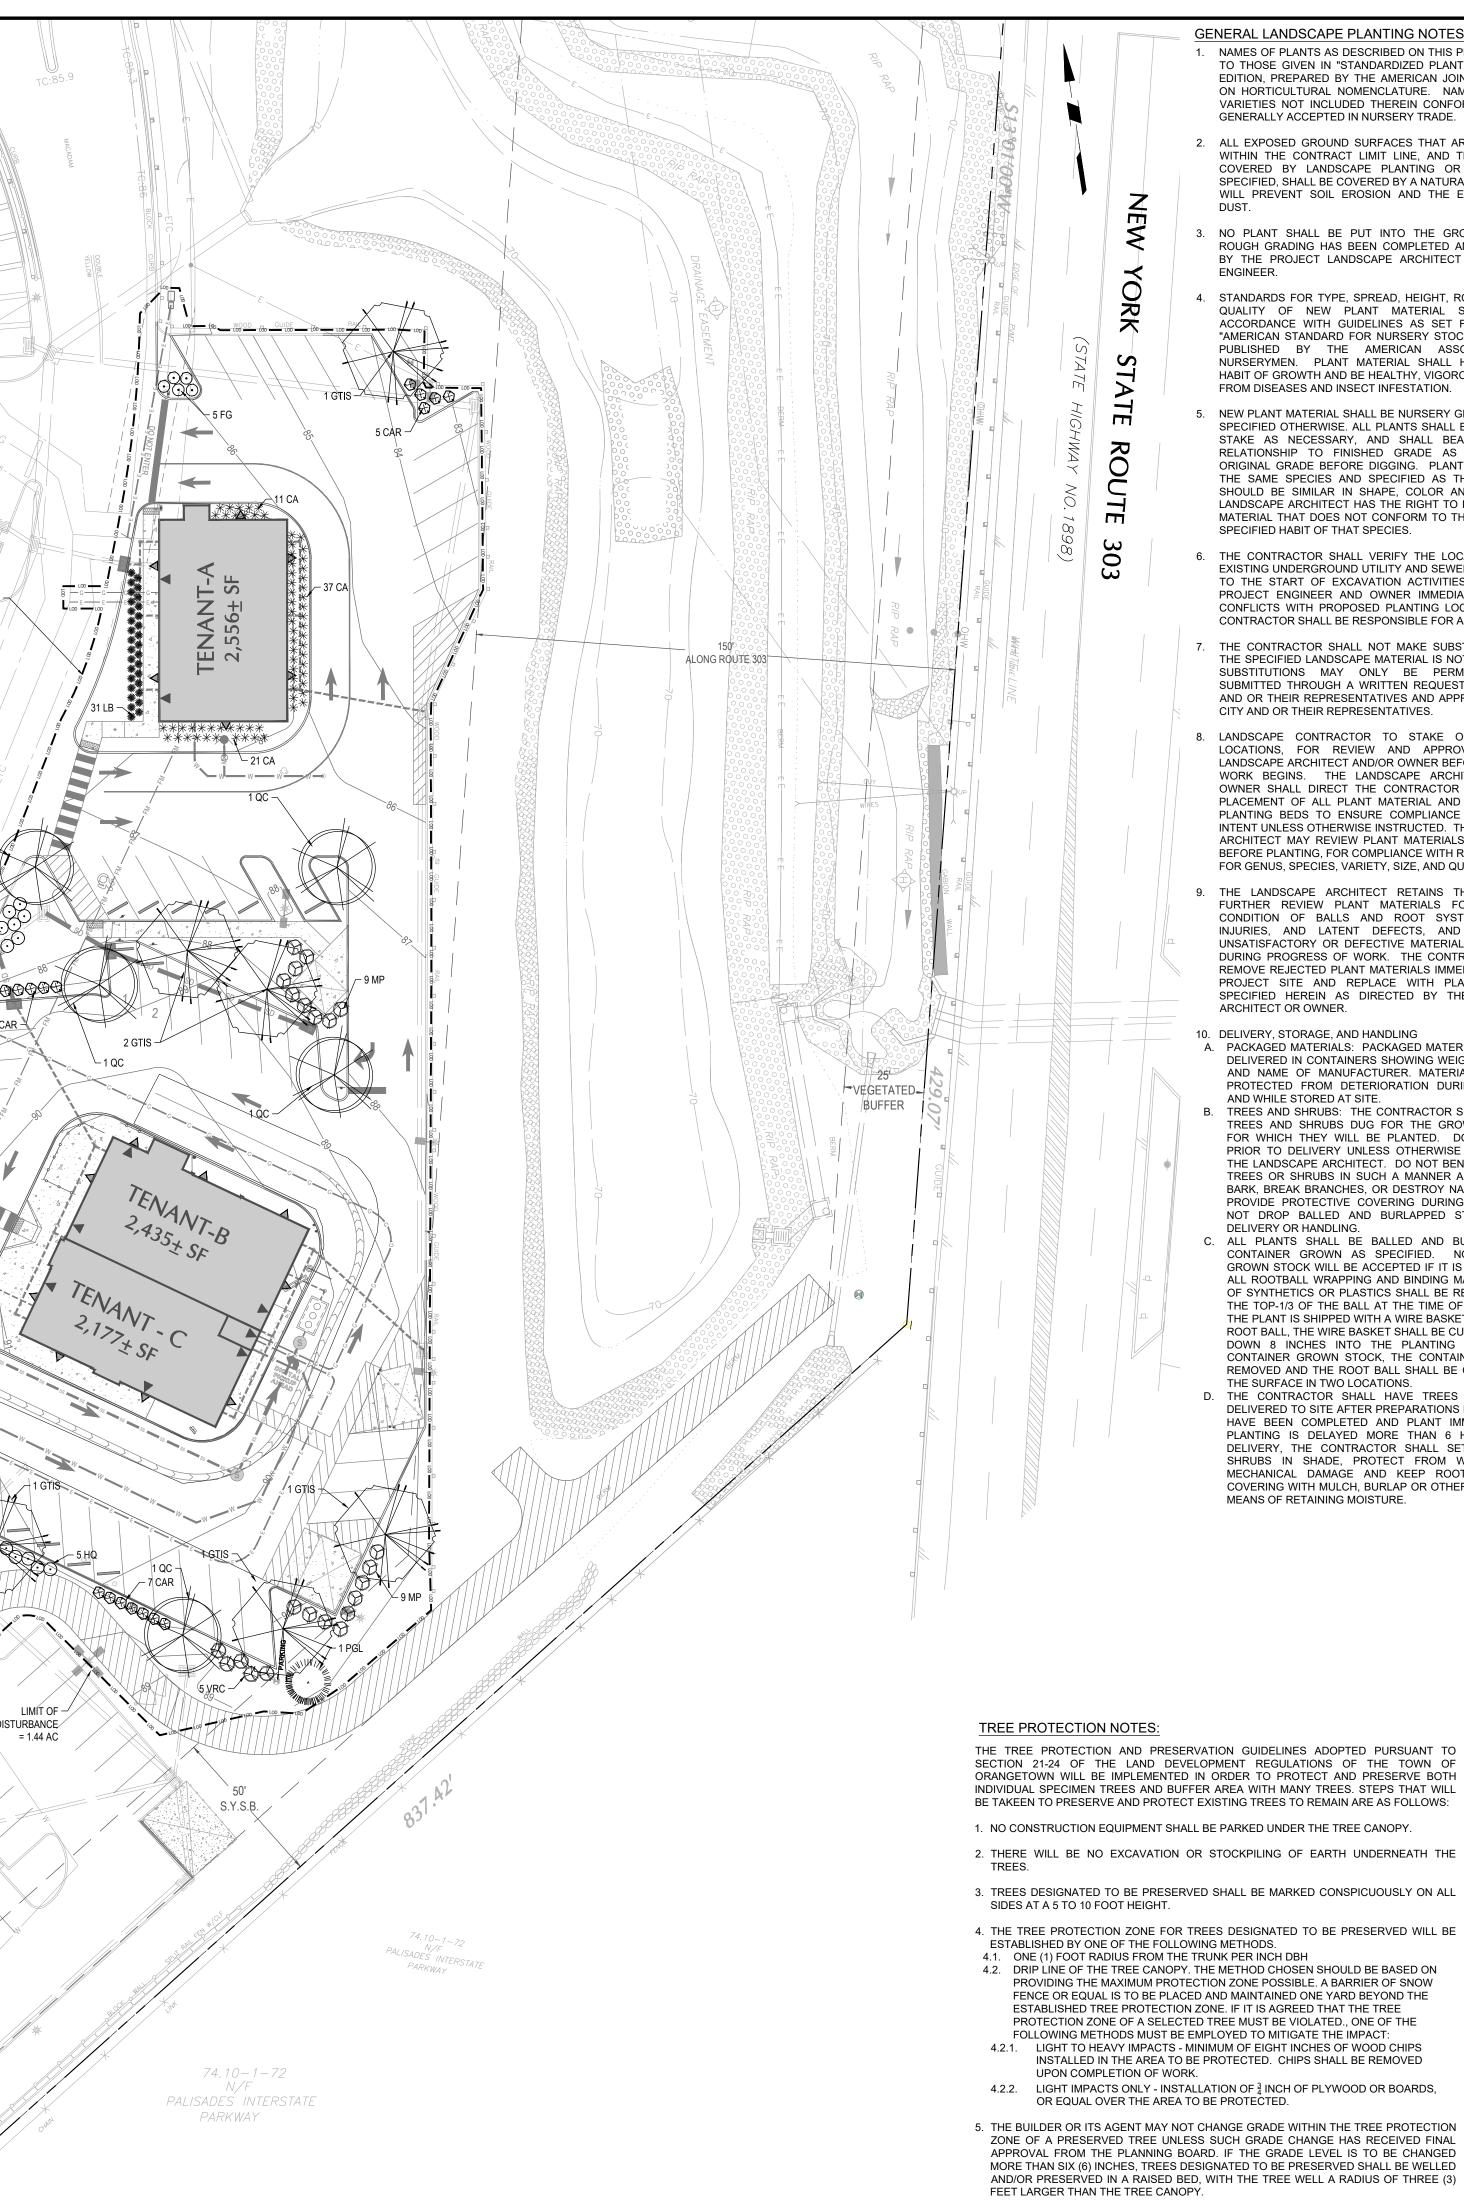


GENERAL LANDSCAPE PLANTING NOTES

- 1. NAMES OF PLANTS AS DESCRIBED ON THIS PLAN CONFORM TO THOSE GIVEN IN "STANDARDIZED PLANT NAMES", 1942 EDITION, PREPARED BY THE AMERICAN JOINT COMMITTEE ON HORTICULTURAL NOMENCLATURE. NAMES OF PLANT VARIETIES NOT INCLUDED THEREIN CONFORM TO NAMES GENERALLY ACCEPTED IN NURSERY TRADE.
- 2. ALL EXPOSED GROUND SURFACES THAT ARE NOT PAVED WITHIN THE CONTRACT LIMIT LINE, AND THAT ARE NOT COVERED BY LANDSCAPE PLANTING OR SEEDING AS SPECIFIED, SHALL BE COVERED BY A NATURAL MULCH THAT WILL PREVENT SOIL EROSION AND THE EMANATION OF DUST
- 3. NO PLANT SHALL BE PUT INTO THE GROUND BEFORE ROUGH GRADING HAS BEEN COMPLETED AND APPROVED BY THE PROJECT LANDSCAPE ARCHITECT OR PROJECT FNGINFFR
- 4. STANDARDS FOR TYPE, SPREAD, HEIGHT, ROOT BALL AND QUALITY OF NEW PLANT MATERIAL SHALL BE IN ACCORDANCE WITH GUIDELINES AS SET FORTH IN THE "AMERICAN STANDARD FOR NURSERY STOCK. ANSI Z60.1" PUBLISHED BY THE AMERICAN ASSOCIATION OF NURSERYMEN. PLANT MATERIAL SHALL HAVE NORMAL HABIT OF GROWTH AND BE HEALTHY, VIGOROUS, AND FREE FROM DISEASES AND INSECT INFESTATION.
- . NEW PLANT MATERIAL SHALL BE NURSERY GROWN UNLESS SPECIFIED OTHERWISE. ALL PLANTS SHALL BE SET PLUMB, STAKE AS NECESSARY, AND SHALL BEAR THE SAME RELATIONSHIP TO FINISHED GRADE AS THE PLANT'S ORIGINAL GRADE BEFORE DIGGING. PLANT MATERIAL OF THE SAME SPECIES AND SPECIFIED AS THE SAME SIZE SHOULD BE SIMILAR IN SHAPE COLOR AND HABIT THE LANDSCAPE ARCHITECT HAS THE RIGHT TO REJECT PLANT MATERIAL THAT DOES NOT CONFORM TO THE TYPICAL OR SPECIFIED HABIT OF THAT SPECIES.
- 6. THE CONTRACTOR SHALL VERIFY THE LOCATION OF ALL EXISTING UNDERGROUND UTILITY AND SEWER LINES PRIOR TO THE START OF EXCAVATION ACTIVITIES. NOTIFY THE PROJECT ENGINEER AND OWNER IMMEDIATELY OF ANY CONFLICTS WITH PROPOSED PLANTING LOCATIONS. THE CONTRACTOR SHALL BE RESPONSIBLE FOR ANY DAMAGE.
- 7. THE CONTRACTOR SHALL NOT MAKE SUBSTITUTIONS. IF THE SPECIFIED LANDSCAPE MATERIAL IS NOT OBTAINABLE. SUBSTITUTIONS MAY ONLY BE PERMITTED WHEN 18. MULCH SHOULD NOT BE PILED UP AROUND THE TRUNK OF SUBMITTED THROUGH A WRITTEN REQUEST TO THE CITY AND OR THEIR REPRESENTATIVES AND APPROVED BY THE CITY AND OR THEIR REPRESENTATIVES.
- LOCATIONS, FOR REVIEW AND APPROVAL BY THE LANDSCAPE ARCHITECT AND/OR OWNER BEFORE PLANTING WORK BEGINS. THE LANDSCAPE ARCHITECT AND/OR PLACEMENT OF ALL PLANT MATERIAL AND LOCATION OF PLANTING BEDS TO ENSURE COMPLIANCE WITH DESIGN INTENT UNLESS OTHERWISE INSTRUCTED. THE LANDSCAPE ARCHITECT MAY REVIEW PLANT MATERIALS AT THE SITE. BEFORE PLANTING, FOR COMPLIANCE WITH REQUIREMENTS 21. WHEN DIGGING PLANT HOLES CHECK FOR ADEQUATE FOR GENUS, SPECIES, VARIETY, SIZE, AND QUALITY.
- 9. THE LANDSCAPE ARCHITECT RETAINS THE RIGHT TO CONDITION OF BALLS AND ROOT SYSTEM, INSECTS, INJURIES, AND LATENT DEFECTS, AND TO REJECT UNSATISFACTORY OR DEFECTIVE MATERIAL AT ANY TIME DURING PROGRESS OF WORK. THE CONTRACTOR SHALL REMOVE REJECTED PLANT MATERIALS IMMEDIATELY FROM PROJECT SITE AND REPLACE WITH PLANT MATERIAL SPECIFIED HEREIN AS DIRECTED BY THE LANDSCAPE ARCHITECT OR OWNER.
- 10. DELIVERY, STORAGE, AND HANDLING A. PACKAGED MATERIALS: PACKAGED MATERIALS SHALL BE
- DELIVERED IN CONTAINERS SHOWING WEIGHT ANALYSIS AND NAME OF MANUFACTURER. MATERIALS SHALL BE PROTECTED FROM DETERIORATION DURING DELIVERY, AND WHILE STORED AT SITE.
- B. TREES AND SHRUBS: THE CONTRACTOR SHALL PROVIDE TREES AND SHRUBS DUG FOR THE GROWING SEASON FOR WHICH THEY WILL BE PLANTED. DO NOT PRUNE PRIOR TO DELIVERY UNLESS OTHERWISE DIRECTED BY THE LANDSCAPE ARCHITECT. DO NOT BEND OR BIND-TIE TREES OR SHRUBS IN SUCH A MANNER AS TO DAMAGE BARK, BREAK BRANCHES, OR DESTROY NATURAL SHAPE. PROVIDE PROTECTIVE COVERING DURING TRANSIT. DO NOT DROP BALLED AND BURLAPPED STOCK DURING DELIVERY OR HANDLING.
- C. ALL PLANTS SHALL BE BALLED AND BURLAPPED OR CONTAINER GROWN AS SPECIFIED. NO CONTAINER GROWN STOCK WILL BE ACCEPTED IF IT IS ROOT BOUND. ALL ROOTBALL WRAPPING AND BINDING MATERIAL MADE OF SYNTHETICS OR PLASTICS SHALL BE REMOVED FROM THE TOP-1/3 OF THE BALL AT THE TIME OF PLANTING. IF THE PLANT IS SHIPPED WITH A WIRE BASKET AROUND THE ROOT BALL, THE WIRE BASKET SHALL BE CUT AND FOLDED DOWN 8 INCHES INTO THE PLANTING HOLE. WITH CONTAINER GROWN STOCK, THE CONTAINER SHALL BE REMOVED AND THE ROOT BALL SHALL BE CUT THROUGH THE SURFACE IN TWO LOCATIONS.
- D. THE CONTRACTOR SHALL HAVE TREES AND SHRUBS DELIVERED TO SITE AFTER PREPARATIONS FOR PLANTING HAVE BEEN COMPLETED AND PLANT IMMEDIATELY. IF PLANTING IS DELAYED MORE THAN 6 HOURS AFTER DELIVERY, THE CONTRACTOR SHALL SET TREES AND SHRUBS IN SHADE, PROTECT FROM WEATHER AND MECHANICAL DAMAGE AND KEEP ROOTS MOIST BY COVERING WITH MULCH, BURLAP OR OTHER ACCEPTABLE MEANS OF RETAINING MOISTURE.

- THE TREE PROTECTION AND PRESERVATION GUIDELINES ADOPTED PURSUANT TO SECTION 21-24 OF THE LAND DEVELOPMENT REGULATIONS OF THE TOWN OF ORANGETOWN WILL BE IMPLEMENTED IN ORDER TO PROTECT AND PRESERVE BOTH INDIVIDUAL SPECIMEN TREES AND BUFFER AREA WITH MANY TREES. STEPS THAT WILL BE TAKEEN TO PRESERVE AND PROTECT EXISTING TREES TO REMAIN ARE AS FOLLOWS:
- 2. THERE WILL BE NO EXCAVATION OR STOCKPILING OF EARTH UNDERNEATH THE
- 3. TREES DESIGNATED TO BE PRESERVED SHALL BE MARKED CONSPICUOUSLY ON ALL
- 4. THE TREE PROTECTION ZONE FOR TREES DESIGNATED TO BE PRESERVED WILL BE
 - PROVIDING THE MAXIMUM PROTECTION ZONE POSSIBLE. A BARRIER OF SNOW FENCE OR EQUAL IS TO BE PLACED AND MAINTAINED ONE YARD BEYOND THE ESTABLISHED TREE PROTECTION ZONE. IF IT IS AGREED THAT THE TREE
- 4.2.1. LIGHT TO HEAVY IMPACTS MINIMUM OF EIGHT INCHES OF WOOD CHIPS INSTALLED IN THE AREA TO BE PROTECTED. CHIPS SHALL BE REMOVED
- 4.2.2. LIGHT IMPACTS ONLY INSTALLATION OF $\frac{3}{4}$ INCH OF PLYWOOD OR BOARDS,
- ZONE OF A PRESERVED TREE UNLESS SUCH GRADE CHANGE HAS RECEIVED FINAL APPROVAL FROM THE PLANNING BOARD. IF THE GRADE LEVEL IS TO BE CHANGED MORE THAN SIX (6) INCHES, TREES DESIGNATED TO BE PRESERVED SHALL BE WELLED AND/OR PRESERVED IN A RAISED BED, WITH THE TREE WELL A RADIUS OF THREE (3)

- 11. ALL LANDSCAPED AREAS TO BE CLEARED OF ROCKS, STUMPS, TRASH AND OTHER UNSIGHTLY DEBRIS. ALL FINE GRADED AREAS SHOULD BE HAND RAKED SMOOTH ELIMINATING ANY CLUMPS AND AND UNEVEN SURFACES PRIOR TO PLANTING OR MULCHING.
- 12. ALL PLANT MATERIAL SHALL BE INSTALLED AS PER DETAILS, NOTES AND CONTRACT SPECIFICATIONS. THE LANDSCAPE ARCHITECT MAY REVIEW INSTALLATION AND MAINTENANCE PROCEDURES.
- 13. PLANT MATERIAL SHALL BE GUARANTEED TO BE ALIVE AND IN VIGOROUS GROWING CONDITION FOR A PERIOD OF TWO YEARS FOLLOWING ACCEPTANCE BY THE OWNER. PLANT MATERIAL FOUND TO BE UNHEALTHY, DYING OR DEAD DURING THIS PERIOD, SHALL BE REMOVED AND REPLACED IN KIND BY THE CONTRACTOR AT NO EXPENSE TO THE OWNER. IN ADDITION, ALL PLANT MATERIAL SHALL BE MAINTAINED FOR THE PERPETUITY OF THE SITE. ANY PLANT MATERIAL WHICH DIES SHALL BE REPLACED WITH PLANT MATERIAL OF THE SAME SIZE AND SPECIES.
- 14. THE CONTRACTOR SHALL KEEP AREA CLEAN DURING DELIVERY AND INSTALLATION OF PLANT MATERIALS. REMOVE AND DISPOSE OF OFF-SITE ANY ACCUMULATED DEBRIS OR UNUSED MATERIALS. REPAIR DAMAGE TO ADJACENT AREAS CAUSED BY LANDSCAPE INSTALLATION OPERATIONS.
- 15. ALL PLANTS SHALL BE WATERED THOROUGHLY TWICE DURING THE FIRST 24- HOUR PERIOD AFTER PLANTING. ALL PLANTS SHALL THEN BE WATERED WEEKLY OR AS REQUIRED BY SITE AND WEATHER CONDITIONS TO MAINTAIN VIGOROUS AND HEALTHY PLANT GROWTH. THE CONTRACTOR IS RESPONSIBLE FOR PROVIDING ADEQUATE WATER TO ALL PLANTS UNTIL THE JOB IS ACCEPTED AS COMPLETE.
- 16. THE BACKFILL MIXTURE AND SOIL MIXES ARE TO BE INSTALLED PER THE SPECIFICATIONS.
- 17. AFTER PLANT IS PLACED IN PLANTING HOLE, ALL TWINE HOLDING ROOT BALL TOGETHER SHOULD BE COMPLETELY REMOVED AND THE BURLAP SHOULD BE PULLED DOWN SO 1/3 OF THE ROOT BALL IS EXPOSED. SYNTHETIC BURLAP SHOULD BE COMPLETELY REMOVED AFTER INSTALLATION.
- ANY PLANT MATERIAL. NO MULCH OR TOPSOIL SHOULD BE TOUCHING THE BASE OF THE TRUNK ABOVE THE ROOT COLLAR.
- 8. LANDSCAPE CONTRACTOR TO STAKE OUT PLANTING 19. ALL FENCE INSTALLATION SHALL BE COMPLETED PRIOR TO COMMENCEMENT OF ANY LANDSCAPE PLANTING, SEEDING, SODDING, OR IRRIGATION WORK.
- OWNER SHALL DIRECT THE CONTRACTOR IN THE FINAL 20. CONTRACTOR TO COORDINATE FENCE INSTALLATION WITH OTHER TRADES INVOLVED WITH SITE WORK. CONTRACTOR IS RESPONSIBLE TO COORDINATE ALL FENCE POST INSTALLATION WITH EXISTING AND PROPOSED UTILITIES.
 - DRAINAGE WITH EMPIRICAL PERC TESTING ,I.E, FILL THE HOLE WITH WATER TO SEE HOW LONG IT TAKES TO DRAIN.
- FURTHER REVIEW PLANT MATERIALS FOR SIZE AND 22. CHECK MULCH AND PLANTS FOR ASIAN EXOTIC JUMPING WORMS

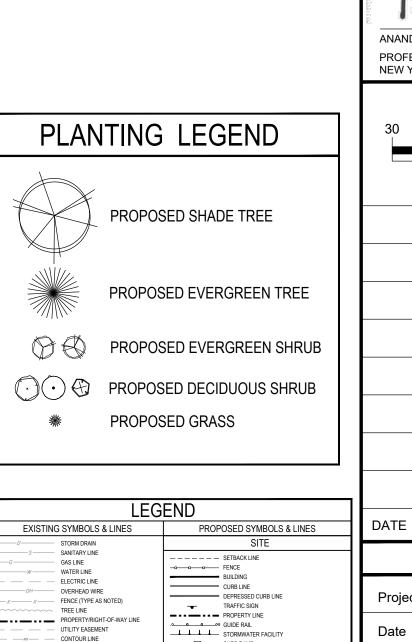

CURB RAMP

BOLLARD

CATCH BASIN CATCH BASIN STORM MANHOLE

STORM MANHOLE
 STORM MANHOLE
 CONTOUR
 CONTOUR
 X1750
 SPOT GRADE
 X1750
 SPOT GRADE
 X1750
 SPOT GRADE
 X1750
 SPOT OF CURB ELEVATION
 X80C 17750
 BACK OF CURB ELEVATION
 X80C 17750
 BACK OF CURB ELEVATION

SD - STORM PIPE

PARKING ROW COUN

PARKING COUNT TOTAL DOOR

GRADING AND DRAINAGE

BACK OF CURB ELEVATION

UTILITY

FLOW ARROW

HEADWALL

T&E ----- TELEPHONE & ELECTRIC LINE

CLEANOUT SANITARY MANHOLE

-ss — ss — PROPOSED SANITARY PIPE T PROPOSED ELECTRIC TRANSFORMER

E PROPOSED ELECTRIC JUNCTION BOX

W WATER LINE

GAS LINE

HYDRANT
 VALVE

165

-

 $\boldsymbol{\Delta}$

6

HYDRANT

STREET LIGHT

AREA LIGHT SIGNAL POLE

ANCHOR POLE

WATER VALVE GAS VALVE

CATCH BASIN

BENCH MARK

METAL COVER ELECTRIC BOX

DOUBLE DOOR

GARAGE DOOR

EXISTING TREE

EXISTING SHRUB

BOLLARD

DOOR

SPOT ELEVATION CLEAN OUT TREE

UNKNOWN VALVE

MANHOLE (TYPE AS LABELED)

o ∀ 8--⊠

5 E @O

•

T: 21	603 stown, PA 18901 5.766.8280 5.434.5280	
Project		
ORA	ANGEBURG MMONS	
ROCKLAN	F ORANGETOWN ND COUNTY NEW Y	ORK
Drawing		
TRE	E PLAN	
20	STATE OF NEW J	20
		SNEER + 1
PROFES	JAY BHAT SIONAL ENGINEERESSIONAL RK LIC. No. 095707	
30	0 10 3	0
	SCALE IN FEET	
DATE	COMMENTS	NO.
Project	REVISIONS	
Date	AUGUST 17, 2	
Scale	1" =	= 30'
Drawn I	Зу .	JEM
Checke		AB
Drawing	P-100	
Sheet	14 of 16	

BHATT THAKKAR

1456 Ferry Road,


ENGINEERING, DPC



1 1 </th <th>$\begin{array}{cccccccccccccccccccccccccccccccccccc$</th> <th></th> <th>RIP RIP </th> <th>NEW YORK STATE ROUTE 303 (STATE HIGHWAY NO. 1898)</th>	$\begin{array}{cccccccccccccccccccccccccccccccccccc$		RIP RIP	NEW YORK STATE ROUTE 303 (STATE HIGHWAY NO. 1898)
	$ \begin{array}{cccccccccccccccccccccccccccccccccccc$	нт Fixture ремали р	RIP RAP RIP RAP PUESETATED- BUFFER I I I I I I I I I I I I I	
MH:12 MH	9 9 1 1 1 1 1 1 1 1 1 1 1 1 1	GHT POLE E TO RÉMAIN		
$\begin{array}{c} \text{NLIMAL IN R } \\ \ NLIMAL IN R } \\ \ NLIMAL IN R \\ \ NLIMAL IN R$	74.10-1-72 PALISADES INTERSTATE PARKWAY	Luminaire Schedule Symbol Qty Label 3 E1 1 E2 1 E2A 2 E4 2 E4A 15 WM Calculation Summary Label	LLF Arrangement 0.950 Single 0.950 2 @ 90 degrees 0.950 Back-Back 0.950 4 @ 90 Degrees 0.540 4 @ 90 Degrees 0.950 Single	Description NV-1-T4-64L-1-50K-SINGLE NV-1-T4-64L-1-50K-D90° NV-1-T5-64L-1-50K-TWIN NV-1-T5-64L-1-50K-QUAD LSI GREENBRIAR GFR-V-400-EXTIST-O NV-W2-T4-64L-53-50K7 Units Avg Max Min Fc 4.17 27.3 0.0


N/F PALISADES INTERSTATE PARKWAY

SITE CALCS Illuminance Fc 4.17 27.3 PARKING Fc 10.03 23.7 Illuminance PICK-UP LANE Fc 9.96 15.3 Illuminance

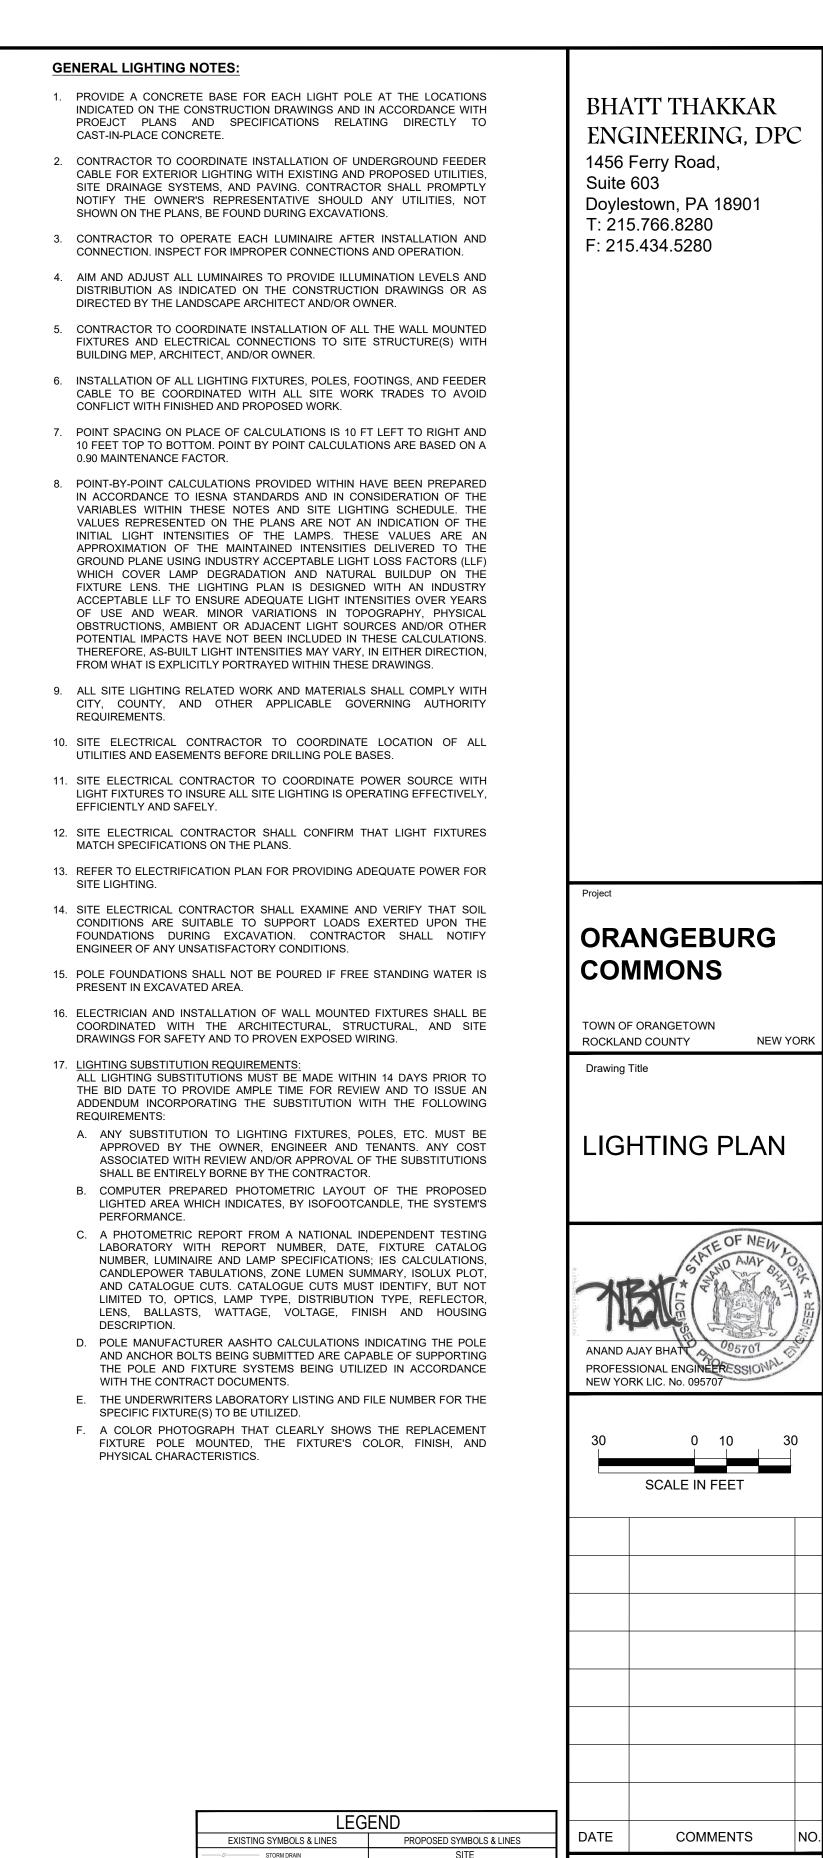

	Watts	MTG HT
	205	18
	205	18
	205	18
	205	18
T-QUAD	452	18
	99	12

Min	Avg/Min	Max/Min
0.0	N.A.	N.A.
5.3	1.89	4.47
5.7	1.75	2.68

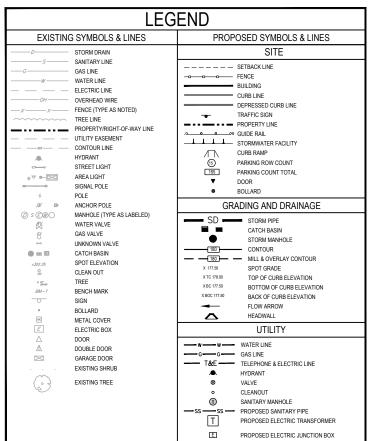

REVISIONS

230002801

1" = 30'

JEM

AUGUST 17, 2023

Project No.

Date

Scale


Drawn By

Checked By

Drawing No.

LT-100

Sheet 15 of 16

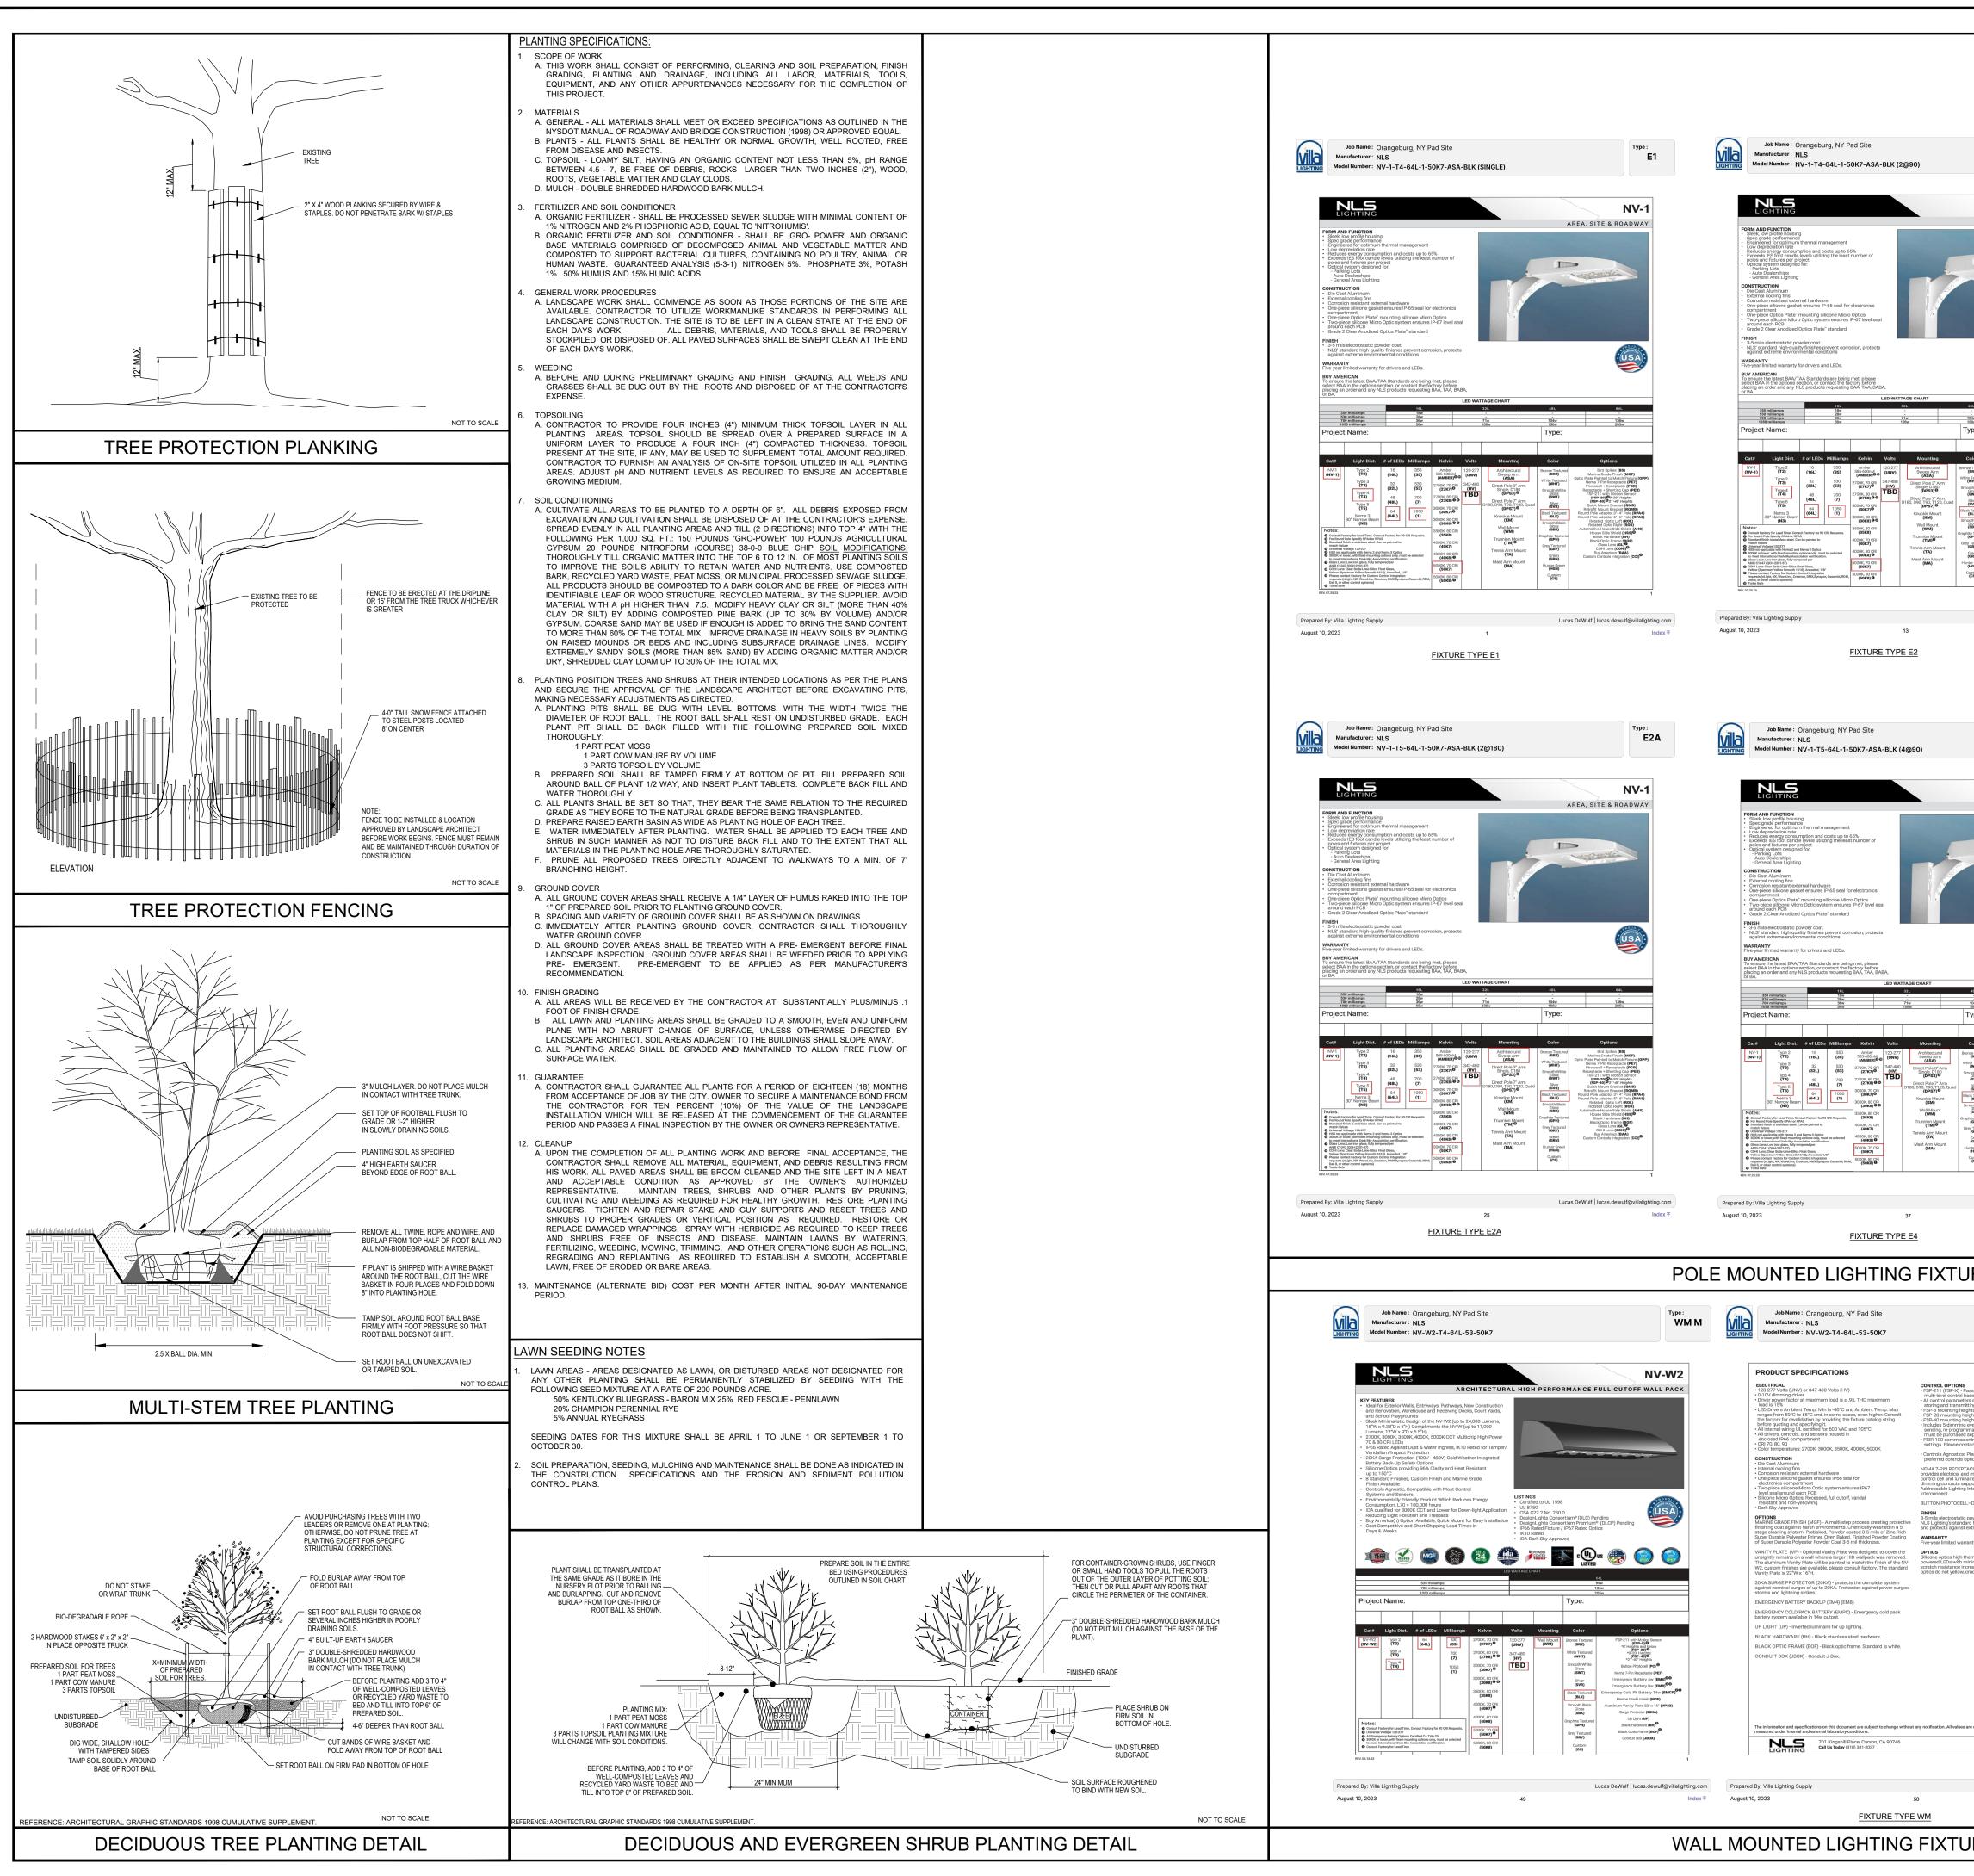

Type :		Job Name : Orangeburg, NY Pad Site		Type :
E2		Manufacturer: NLS Model Number: NV-1-T4-64L-1-50K7-ASA-B	LK (SINGLE)	E1
NV-1		PRODUCT SPECIFICATIONS ELECTRICAL 120-277 Volts (UNV) or 347-480 Volts (HV)	CONTROL OPTIONS • FSP-211 (FSP-3) - Passive infrared (PiR) sensor providing	
		 1202;777 Veits (UNV) or 347-480 Volts (HV) 0-T0V dimming driver 0-Triver power factor at maximum load is 2-95, THD maximum load is 1500. 0-T000 (Table 1000) 0-T000 (T		note
Constanting of the second		All drivers, controls, and sensors housed in enclosed IPSS compartment IPSS compartment IPSS of the sensor of the sensor of the sensor IPSS of the sensor of the sensor of the sensor CONSTRUCTION IPSS of the sensor of the sensor of the sensor of the sensor IPSS of the sensor of the sensor of the sensor of the sensor IPSS of the sensor of the sensor of the sensor of the sensor of the sensor IPSS of the sensor of the sense sense	 Versitaj, re-programma de in tre lead. Versitaj, re-programma de la construcción d	tacle provides
		Die Cast Alumirum External ocoling framewnal hardware Corrosion resistant ausöte faruurus (P65 seel for electronics compartment One-piece Optics Pitte* mounting allicone Micro Optics Two-piece Block Micro Optics system ensures (P67 level	 Iuminaire. Dimming receptacle available two or four dimming oo 0-10 VDC dimming methods or Digital Addressable Lighting Inter providing reliable power interconnect. PHOTOCELL + RECEPTACLE (PCR)-7-Pin Receptacle and Elect Twist Lock Photocell for dusk to dawn operation. 	tacts supports face (DALI),
USA:		seal around each PCB • Grade 2 Clear Anoles Cd Optios Plate ¹⁶ attandard OPTIONS • BIRD SPIKES (BS) • Offers a practical and humane deterrent for larger bird species and provides a cost-effective long-term solution to nuisance bird infestations and provides to your property.	RECEPTACLE + SHORTING CAP (PER)-7-Pin Receptacle and Shorting Cap. FINEH S of will electrostatic powder coat. N.S. Light's standard high-quality finishes prevent corrosion protects against and externe environmental conditions	
		- MARINE GRADE FINISH (MGF) - A multi-step process creating protective finishing cost against hards merivments. Chemically watered in a 5 stage cleaning system. Pre-baked, Powder costad 3-6 milli of Zino Rich Super Duris Polyester Fritme: Over Baked, Finished Powder Costing of Super Durish De Powder Cost 3-5 mil thickness. - OPTIC PLATE PAINTED TO MATCH FXTURE (OPP) - Optic plate in clear an	Vester OPTICS Silicone optios high thermal stability and light output provide high with minimized lumen depreciation. UV stability with scratch resi	ier powered LEDa stance increases
64L - 136w 209w		 as standard. The optic plate can be powder cosited to match the finish of the fixture. QUICK MOUNT BRACKET (QMB) - Optional Cast Aluminum Bracket design quick mounting on Direct Square or Round Poles. Cleat mounts directly to pressly hung fixtures. Has a 2'x#' Drill Pattern. RETROFT MOUNT BRACKET - Optional Cast Aluminum Bracket designed 	bitain to application our parameters and the second of the	or pritte over
Options		quick mounting on Direct Square or Round Poles. Clear mounts directly to pr easily hung flottures. J [11] Pattern is adjustable from 2x ⁴ to 2x ⁶ . • ROUND POLE ADAPTER (RPA). When using round poles, specify Round PA Adapter (RPA). Specify RPA when installing on 3 ⁻⁴ round poles, and RPAS installing on 3 ⁻⁶ round poles.	Design/Dights Cohordium Yermum" (DLCH) Design/Dights Cohordium Yermum" (DLCH) Design/Dights Cohordium Yermum" (DLCH) S0 Vibration Rated per ANSI C136.31-2010 de HO Jank SiX Approved HIVA AMERICAN OPTION	16. fee the Pro-
Bird Spikes (BS) Marine Grade Finish (MGF) Mater Painted to Match Fixture (OPP) Nema 7-Pin Receptacle (PER) Photocol + Receptacle (PER) Fish-211 with Motion Bensor (FSP-20) 2:07 Heights (FSP-20) 2:07 Heights (FSP-20) 2:07 Heights (FSP-20) 2:07 Heights		ROTATED OPTICS (ROL) (ROR): Rotated optics are designed for perimeter lighting for auto designatings. SHIELDG (HSS, AHS) - House Side Shield (HSS) is designed for full property cut-off - Automother House Side Shield (HSS) is a designed for full property partial out-off on either side or front of luminaire.	change our listings without notice.	oses only. We
nd Pole Adaptor 3'- 4' Pole (RPA4) Ind Pole Adaptor 5'- 6' Pole (RPA5) Rotated Optic Left (RPA5) Rotated Optic Left (RO1) Rotated Optic Left (RO1) Rotated Optic Right (RO2) Mark Hardware (INH) Black Optic Frame (BOF) Glass Lens (GL)9 CCH1 Lens (COH)9		BLACK HARDWARE (BH) - Optional black, zino coated steel hardware. BLACK OPTIC FRAME (BOF) - Optional black optic frame. Standard is white.	Additional NLB Products that meet BAA, TAA standards can be for following link: https://ilalighting.com/wp-content/uploads/cs/NLS_BuyAmerics	
Buy American (BAA) ustom Controls Integration (Cct)®		The information and specifications on this document are subject to change measured under internal and external laboratory conditions. NULLS NULLS 701 Kingshill Place, Carson, CA 9074 Call Us Today (310) 341-2037	without any notification. All values are design, nominal, typical or prorated	alues when ighting.com
ulf lucas.dewulf@villalightir In	udov 🖉	Prepared By: Villa Lighting Supply August 10, 2023	Lucas DeWulf lucas.c	lewulf@villalighting.com Index ぞ
	6	Job Name : Orangeburg, NY Pad Site Manufacturer : NLS Model Number : NV-1-T4-64L-1-50K7-ASA-B		Type: E1
Туре : Е	4	PRODUCT SPECIFICATIONS CONTROLS • DIMMING CONTROL (FSP)—Passive infrared (PIR) sensor prov on motion/daylight contribution. • All control parameters adjustable via wireless configuration		Ð
		transmitting eensor profiles. • FSP-8 mounting heights 6 feet and below • FSP-20 mounting heights 9-20 feet • FSP-40 mounting heights 9-21-40 feet • Includes 5 dimming event cycles, 0-10V dimming with mo in the field.	× ×	
NV-1		FSP-8 Coverage Top View (# 12h)	Coverage Site View	
STORE STORE		FSP-20		
USA		FSP-40 Coverage Top Xiew (#4th	- Concerting and Meril	
64L - - 136w 205w				
Options Bird Splices (BS)				
Plate Painted to Match Fixture (OPP) Nema 7-Pin Receptacle (PCR) Photocell + Receptacle (PCR) Receptacle + Shorting Cap (PER) FSP-211 with Motion Sensor (FSP-20) @9-20 ⁻ Heights (FSP-20) @9-21 ⁻⁴⁰ Heights Quick Mount Bracket (QMB) Patroffit Mount Bracket (QMB)		701 Kingshill Place, Carson, CA 9074 Call Us Today (310) 341-2037	5 nisi	ighting.com
Bird Spike (BS) Bird Spike (BS) Marine Grade Finah (Merr) Marine Grade Finah (Merr) Merrison (BS) Merrison (BS) Merrison (BS) Merrison (BS) Reform (Mount Binako (BS) Reform (Mount Binako (ROM)) Deltade Opto Left (ROM) Deltade Opto Left (ROM) Binako (ROM) Deltade Opto Left (ROM) Binako (ROM) Deltade Opto Left (ROM) Deltade Opto Left (ROM) Deltade Opto Left (ROM) Deltade Opto Left (ROM) Binako (ROM) Deltade Opto Left (ROM) Binako (ROM) Deltade Opto Left (ROM) Binako (ROM) Deltade Opto Left (ROM				3
COHL Lens (COHI) COHL Lens (COHI) Buy American (BAA) Custom Controls Integration (CCI)		Prepared By: Villa Lighting Supply August 10, 2023	Lucas DeWulf lucas.o	lewulf@villalighting.com Index
1				
Wulf lucas.dewulf@villalighti 	ing.com Index			NOT TO SCALE
CUT-SHI	EETS			
Туре М	им 🚺	Job Name: Orangeburg, NY Pad Site Manufacturer: NLS Model Number: NV-W2-T4-64L-53-50K7		Type: WM M
IR) sensor providing laylight contribution.		MOTION SENSOR PLACEMENT		
vireless configuration remote s. low V dimming with motion Programmable remote				
quired to change sensor dering. ctory for your		FSP-8 Coverage Top View @ 12tt		
NSI C136.41-2013 receptacle rconnection between photo eptacle available two or four jimming methods or Digital providing reliable power				
ptional Button Photocell. ishes prevent corrosion, iental conditions.				
d LEDs. d light output provide higher ppreciation. UV stability with polication durability. Silicope				
pplication durability. Silicone r time.				
		FSP-40 Coverage for Yow Batt	Generate bias year.	
typical or prorated values when				
nlslighting.com	2	701 Kingshill Place, Carson, CA 90746 Call Us Today (310) 341-2037	nisiigi	ting.com 3
		repared By: Villa Lighting Supply	Lucas DeWulf lucas.dev	ulf@villalighting.com
DeWulf lucas.dewulf@villali		ugust 10, 2023	51	Index 至

ENGINE 1456 Ferry Suite 603 Doylestowr T: 215.766	n, PA 18901 .8280
F: 215.434	
	GEBURG
TOWN OF ORANG ROCKLAND COU	
Drawing Title	CAPE AND
	NG
	STATE OF NEW LOOP
ANAND AJAY BH	
	ENGINEERESSIONAL
DATE	COMMENTS NO
RE	EVISIONS
Project No. Date	23000280
Scale	AUGUST 17, 2023
Drawn By	JEN
Checked By	A
Drawing No.	
	-04
LP-5	501