### PROPERTY INFORMATION

475 KINGS HIGHWAY SPARKILL, NY 10976 PROJECT TYPE: DEVELOPMENT OF EMPTY LOT TO PROVIDE NEW SINGLE-FAMILY WOOD-FRAME DWELLING

LOT NUMBER: 74.20-3-5.1 LOT WIDTH: LOT DEPTH: 173.11'

10,911 SF (.25A) ALLOWABLE F.A.R. .30 (3,273 SF) GROSS FLOOR AREA PROPOSED: 3,269 SF

MAXIMUM BUILDING HEIGHT\*: 30'-0" PROPOSED BUILDING HEIGHT: 24'-7"

SEE SITE PLAN FOR ALL REQUIRED SETBACKS AND PROPOSED BUILDING SETBACKS. MAXIMUM BUILDING HEIGHT IS EQUAL TO 1'-4" PER 1'-0" DISTANCE FROM NEAREST PROPERTY LINE.

## **GENERAL NOTES**

THESE SIGNED & SEALED DOCUMENTS HAVE BEEN PREPARED TO ILLUSTRATE AND EXPLAIN THE SCOPE OF WORK REQUIRED FOR THE CONSTRUCTION OF A NEW SINGLE-FAMILY WOOD-FRAMED DWELLING, AND ARE LIMITED TO BASIC STRUCTURAL & ARCHITECTURAL INFORMATION. NO FURTHER LIABILITY SHALL BE ASSUMED BEYOND THE CONTENTS HEREIN.

ALL MECHANICAL, ELECTRICAL, & PLUMBING INFORMATION AND SCOPE OF WORK SHALL BE PROVIDED BY OTHERS.

ALL WORK SHALL COMPLY WITH NYC BUILDING CODE, NFPA, NYC ELECTRICAL CODE & ALL OTHER APPLICABLE CODES &

ORDINANCES AND IN ACCORDANCE WITH MUNICPALITY RULES. APPLICABLE CODES INCLUDE: 2020 INTERNATIONAL BUILDING CODE NY STATE / 2021 INTERNATIONAL RESIDENTIAL CODE

2017 UNIFORM CONSTRUCTION CODE WITH NY STATE SUPPLEMENT 2020 ENERGY CONSERVATION CODE OF NEW YORK STATE WITH 2020 NYSTRETCH ENERGY CODE SUPPLEMENTS.

IN ADDITION TO WORKMAN'S COMPENSATION AND DISABILITY INSURANCE REQUIRED BY THE DEPARTMENT OF BUILDINGS, ALL CONTRACTORS AND SUBCONTRACTORS PERFORMING WORK IN THE PREMISES SHALL PROVIDE LIABILITY INSURANCE IN AMOUNTS DESIGNATED BY THE BUILDING OWNER.

IN THE EVENT OF CONFLICTS BETWEEN THE DOCUMENTS AND THE REQUIREMENTS OF THE BUILDING CODE. THE MORE STRINGENT REQUIREMENT GOVERNS.

IN THE EVENT OF ERRORS OR INCONSISTENCIES IN THE DOCUMENTS, THE GENERAL CONTRACTOR SHALL NOTIFY THE ARCHITECT. THE ARCHITECT SHALL PROVIDE CLARIFYING INFORMATION TO THE CONTRACTOR. THE CONTRACTOR SHALL IMMEDIATELY NOTIFY THE ARCHITECT OF ANY STRUCTURAL CONDITIONS NOT SHOWN ON THESE PLANS.

THE INTENT OF THESE DOCUMENTS IS TO ILLUSTRATE AND INCLUDE BASIC ITEMS NECESSARY FOR THE PROPER EXECUTION OF THE WORK. THE CONTRACTOR SHALL FURNISH OR CONTRACT FOR ALL LABOR, MATERIALS, TOOLS, EQUIPMENT AND OTHER ITEMS AS MAY BE NECESSARY TO COMPLETE THE WORK CALLED FOR, SHOWN ON OR REASONABLY INFERRED BY THESE DOCUMENTS.

THE ARCHITECT IS NOT RESPONSIBLE FOR CONSTRUCTION METHODS, TECHNIQUES, OR PROCEDURES, OR FOR SAFETY PRECAUTIONS AND PROGRAMS IN CONNECTION WITH THE WORK SINCE THESE ARE SOLELY THE GENERAL CONTRACTOR'S RESPONSIBILITY.

DO NOT SCALE DRAWINGS TO OBTAIN DIMENSIONS. IF UNCERTAINTY ARISES REGARDING DIMENSIONS, ALIGNMENTS, HEIGHTS, ETC. CONTACT THE ARCHITECT FOR CLARIFICATION.

THE CONTRACTOR SHALL COORDINATE THE WORK OF SEPARATE TRADES. THE CONTRACTOR SHALL COORDINATE THE FITTING AND MATCHING OF MATERIALS AND EQUIPMENT SUPPLIED BY THE SUBCONTRACTORS OR THEIR SUPPLIERS.

THE CONTRACTOR SHALL INSURE THAT ALL WORK IS INSTALLED STRAIGHT, TRUE TO LINE, ACCURATELY FITTED AND LOCATED WITH PROPER SUPPORTS, GROUNDS, BLOCKING, HARDWARE, BACKING MATERIAL, JOINTS, SEALANT OR GROUTS AS APPLICABLE USING APPROPRIATE HARDWARE OR CONNECTION DEVICES AND FOR THE PROPER INTEGRATION OF THE WORK OF DIFFERENT TRADES. ALL ITEMS SHALL BE ANCHORED FIRMLY AS REQUIRED BY SUBSTRATE CONDITIONS, EXCEPT ITEMS REQUIRING LOOSE OR SLIP JOINTS OR CONNECTIONS TO ALLOW FOR EXPANSION AND CONTRACTION OR MOVEMENT IN THE BUILDING.

## CONSTRUCTION & MATERIALS NOTES

FOR DESIGN PURPOSES, LOAD VALUES FOR THESE DOCUMENTS WERE TAKEN FROM TABLE R401.41, WITH SOILS MAINTAINING A MINUMUM LOAD-BEARING PRESSURE OF 2,000 PSF. ALL FOOTINGS AND FOUNDATION WORK SHALL ONLY BE INSTALLED ON SOIL WITH PROPER BEARING VALUE.

ALL CONCRETE WORK SHALL BE TRANSIT-MIXED STONE WITH A BEAING CAPACITY OF 3,000 PSI TESTED 28 DAYS AFTER POURING.

ALL LUMBER USED IN THE WORK SHALL BE SOUND, DRY, CONSTRUCTION GRADE DOUGLAS FIR OR KD SPRUCE WITH MINIMUM STRESS VALUES OF FB = 1,500 PSI AND E = 1,750,000.

DOOR, WINDOW, AND OPENING HEADERS FOR SPANS LESS THAN 6'-0" SHALL CONSIST OF (2) 2x10 LUMBER, UNLESS OTHERWISE NOTED. DOOR, WINDOW, AND OPENING HEADERS FOR SPANS BETWEEN 6'-0" AND 8'-0" SHALL CONSIST OF (3) 2x10 OR (2) 2x12 LUMBER IN EXTERIOR WALLS, UNLESS OTHERWISE NOTED.

PROVIDE DOUBLE FLOOR JOISTS AT ALL LOCATIONS WHERE PARTITIONS RUN PARALLEL WITH JOIST SPAN.

STAIRS TO BE CONSTRUCTED AND DIMENSIONED AS PER NEW YORK STATE CODE REQUIREMENTS.

MAXIMUM RISER HEIGHT: 8.25" MINIMUM TREAD DEPTH: 9"

MINIMUM NOSING DEPTH: 3/4"

HANDRAIL HEIGHT: 36" ABOVE FINISHED FLOOR MAXIMUM SPINDLE GAP: 4"

MACHINION STRABLE GAL.	'							
STRUCTURAL DESIGN LOADING CHART								
LOCATION	LIVE LOAD REQUIRED	DEAD LOAD APPLIED	TOTAL LOAD VALUE					
ATTIC	20 LBS / SF	10 LBS / SF	30 PSF					
GUARDRAIL & HANDRAIL	200 LBS / SF	20 LBS / SF	220 PSF					
PASSENGER VEHICLE GARAGE	20 LBS / SF	10 LBS / SF	30 PSF					
NON-SLEEPING ROOMS	40 LBS / SF	10 LBS / SF	50 PSF					
SLEEPING ROOMS	30 LBS / SF	20 LBS / SF	50 PSF					
STAIRS	40 LBS / SF	10 LBS / SF	50 PSF					
DECKS & PORCHES	40 LBS / SF	10 LBS / SF	50 PSF					

## THERMAL & FIRE SAFETY NOTES

INSTALL HARD-WIRED SMOKE/C02 DETECTORS IN ALL BEDROOMS, HALL AREAS NEAR BEDROOMS, ATTICS, AND BASEMENT AND AS PER BUILDING & FIRE SAFTEY CODE-MANDATED REQUIREMENTS.

SECTION N102.4.1. OF THE NEW YORK STATE RESIDENTIAL CODE FOR DETAILED INFORMATION REGARDING CAULKING,

BUILDING THERMAL ENVELOPE SHALL BE PROPERLY SEALED AND SECURED TO LIMIT AIR & MOISTURE INFILTRATION. REFER TO

WEATHERSTRIPPING, & OTHER AIR/VAPOR BARRIER MATERIALS AND INSTALLATIONS.

PROVIDE VAPOR RETARDERS AS PER NEW YORK STATE RESIDENTIAL CODE N1102.5 CLASS 1 (ROCKLAND COUNTY / ZONE 5). AT BASEMENT AND GARAGE STUD WALLS, PROVIDE SHEET POLYETHYLENE, NON PERFORATED ALUMINUM FOIL

TABLE N1102.1 CLIMATE ZONE #5							
LOCATION	PERFORMANCE REQUIRED	PERFORMANCE SPECIFIED					
CEILING	R-49	R-49					
WALL	R-21	R-21					
FLOOR	R-30	R-30					
GLAZING	U-35	U-30					
BASEMENT WALL	R-15	N/A					
ON-GRADE SLAB EDGE	R-10	N/A					
CRAWL SPACE	R-15	N/A					

NOTE: ALL WINDOW & DOOR MODEL NUMBERS REFERENCED APPLY TO TO ANDERSEN WINDOWS WOOD-FRAMED WINDOW LINE SEE MANUFACTURER SPECIFICATIONS FOR MORE INFORMATION.

TABLE R301.2(1) CLIMATIC AND GEOGRAPHIC DESIGN CRITERIA													
WIND DESIGN				SUBJECT TO AMAGE FROM		WINTER	ICE BARRIER		AIR	MFAN			
GROUND SNOW LOAD	SPEED (MPH)*	TOPO- GRAPHIC EFFECTS*	SPECIAL WIND REGION*	WIND- BORNE DEBRIS ZONE*	DESIGN CATE- GORY*	WEATHE R-ING	FROST LINE DEPTH*	TERMITE*	DESIGN TEMP	UNDERLAY- MENT REQUIRED*	FLOOD HAZARDS	FREEZING INDEX*	ANNUAL TEMP*
30 LBS/SF	115	NO	NO	NO	В	SEVERE	3'-0"	MODERATE TO HEAVY	15°	YES	ZONE X	1500 OR LESS	53.1°

NOTE: \* ALL CATEGORIES MARKED WITH AN ASTERISK TO BE DETERMINED BY THE JURISDICTION, AS PER TABLE R301.2(1) FOOTNOTES, FILLED IN ABOVE TO BEST KNOWLEDGE. FLOOD HAZARD ZONE DESIGNATION INDICATED BY FEMA FLOOD MAP SERVICE CENTER MAP #36087C0193G (EFFECTIVE 3/3/2014).

NOTE: ENERGY CODE COMPLIANCE PATH DATA (RESCHECK) TO BE PROVIDED BY OTHERS.

FENESTRATION SCHEDULE (HABITABLE SPACE)									
WINDOW	LIGHT AREA (SF)	VENT AREA (SF)	OFFICE	KITCHEN /FAMILY ROOM	DINING ROOM	MASTER BED	BED 1	BED 2	BED 3
WDH2456	9.56	4.38	4	4	4				
G536	11.3	6.6		1					
50611APLR	17.38	28.34		2					
WDH2442	7.01	4.02				4	3	3	2

FENESTRATION SCHEDULE INCLUDES ONLY EXTERIOR WINDOW & DOORS USED TO CALCULATE LIGHT & AIR CALCULATION REQUIREMENTS BELOW. SEE PLANS FOR ALL OTHERS. ALL WINDOWS & DOORS TO BE ANDERSEN 400 SERIES OR OTHER APPROVED CODE-COMPLIANT ALTERNATE. ALL PLAN TAGS REFER TO ANDERSEN "WDH" SERIES UNLESS NOTED.

## DRAWING SHEET LIST

NOTES & SITE PLAN CELLAR & FIRST FLOOR PLAN A-101 SECOND FLOOR PLAN A-102

LIGHT & AIR CALCULATIONS - 1ST FLOOR								
ROOM NAME	I NAME  [A] ROOM AREA  [LA] LIGHT AREA  REQUIRED  (A x 8%)  LIGHT AREA  PROVIDED  VENTILATION  AREA REQUIRED  (LA x 45%)  VENTILATION  AREA PROVIDED							
OFFICE	139 SF	12.3 SF	38.2 SF	5.5 SF	17.5 SF			
KITCHEN/FAMILY ROOM	604 SF	48.3 SF	84.3 SF	21.7 SF	80.8 SF			
DINING ROOM	158 SF	12.6 SF	38.2 SF	5.7 SF	17.5 SF			

LIGHT & AIR REQUIREMENTS BASED ON SECTION 402 LIGHT/SECTION 403 VENTILATION. ALL CALCULATIONS AND AREAS SHOWN AS PER MANUFACTURER'S TECHNICAL SPECIFICATIONS FOR GLAZED AND VENTED AREAS.

	LIGHT & AIR CALCULATIONS - 2ND FLOOR									
ROOM NAME	ROOM NAME  [A] ROOM AREA  [LA] LIGHT AREA REQUIRED (A x 8%)  LIGHT AREA PROVIDED  VENTILATION AREA REQUIRED (LA x 45%)  VENTILATION AREA PROVIDED									
MASTER BEDROOM	215 SF	17.2 SF	28.0 SF	7.7 SF	16.1 SF					
BEDROOM 1	144 SF	11.5 SF	21.0 SF	5.2 SF	12.1 SF					
BEDROOM 2	182 SF	14.6 SF	14.0 SF	6.6 SF	12.1 SF					

14.0 SF

BEDROOM 3

LIGHT & AIR REQUIREMENTS BASED ON SECTION 402/SECTION 403. ALL CALCULATIONS AND AREAS SHOWN AS PER MANUFACTURER'S TECHNICAL SPECIFICATIONS FOR GLAZED AND VENTED AREAS.

130 SF



05/27/2021 ISSUED FOR REVIEW

10/08/2021

ISSUED FOR REVIEW 08/05/2023

**ISSUED FOR PERMIT** ISSUANCE RECORD

OWNER: GRIFF CONSTRUCTION, LLC 1 ROUNDHOUSE ROAD PIERMONT, NY 10968

ARCHITECT: LUKE PETROCELLI, RA 51 STRATFORD RD, APT C3 BROOKLYN, NY 11218

PROJECT ADDRESS: 475 KINGS HIGHWAY

SPARKILL, NY 10983

DRAWING TITLE: NOTES & PLOT PLAN


SCALE:



1/16" = 1'-0"

01 OF 05

DWG. NO.

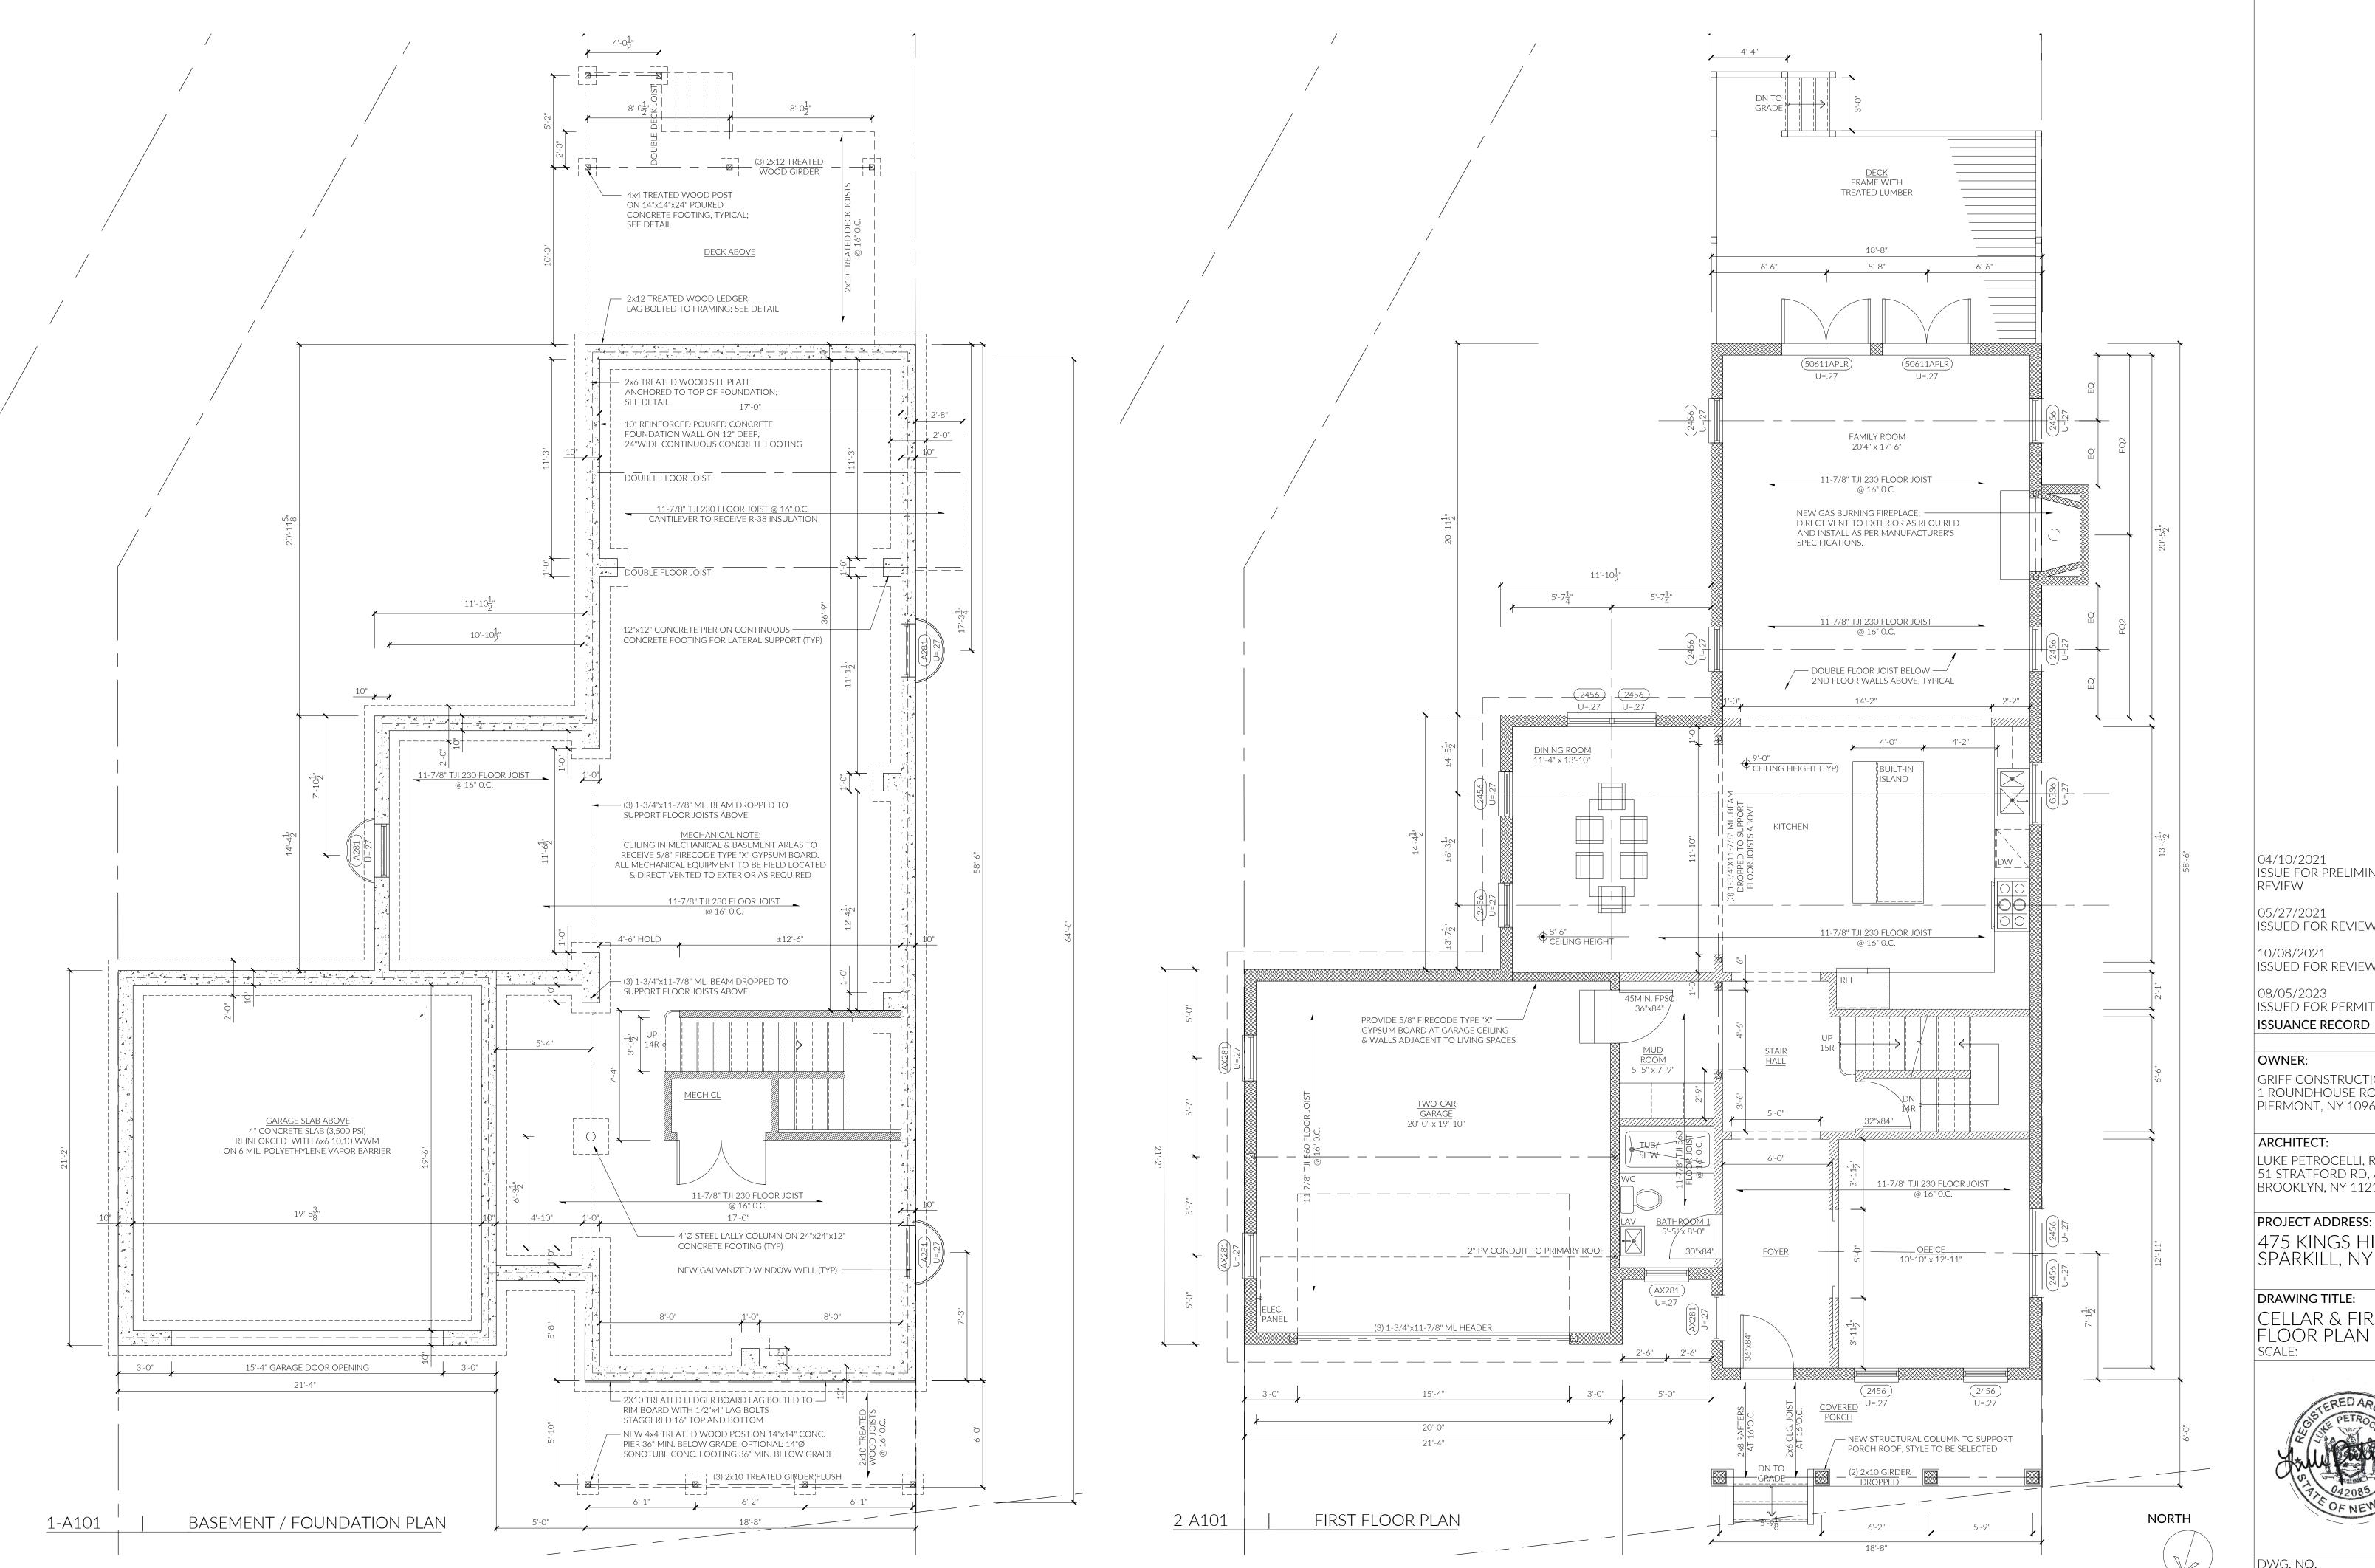

04/10/2021 ISSUE FOR PRELIMINARY REVIEW

05/27/2021 ISSUED FOR REVIEW

10/08/2021 ISSUED FOR REVIEW

08/05/2023 ISSUED FOR PERMIT

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GRIFF CONSTRUCTION, LLC 1 ROUNDHOUSE ROAD PIERMONT, NY 10968

## ARCHITECT: LUKE PETROCELLI, RA

51 STRATFORD RD, APT C3 BROOKLYN, NY 11218

PROJECT ADDRESS: 475 KINGS HIGHWAY SPARKILL, NY 10983


DRAWING TITLE:

CELLAR & FIRST FLOOR PLAN SCALE: 1/4" = 1'-0"



02 OF 05 DWG. NO.

A 101.00

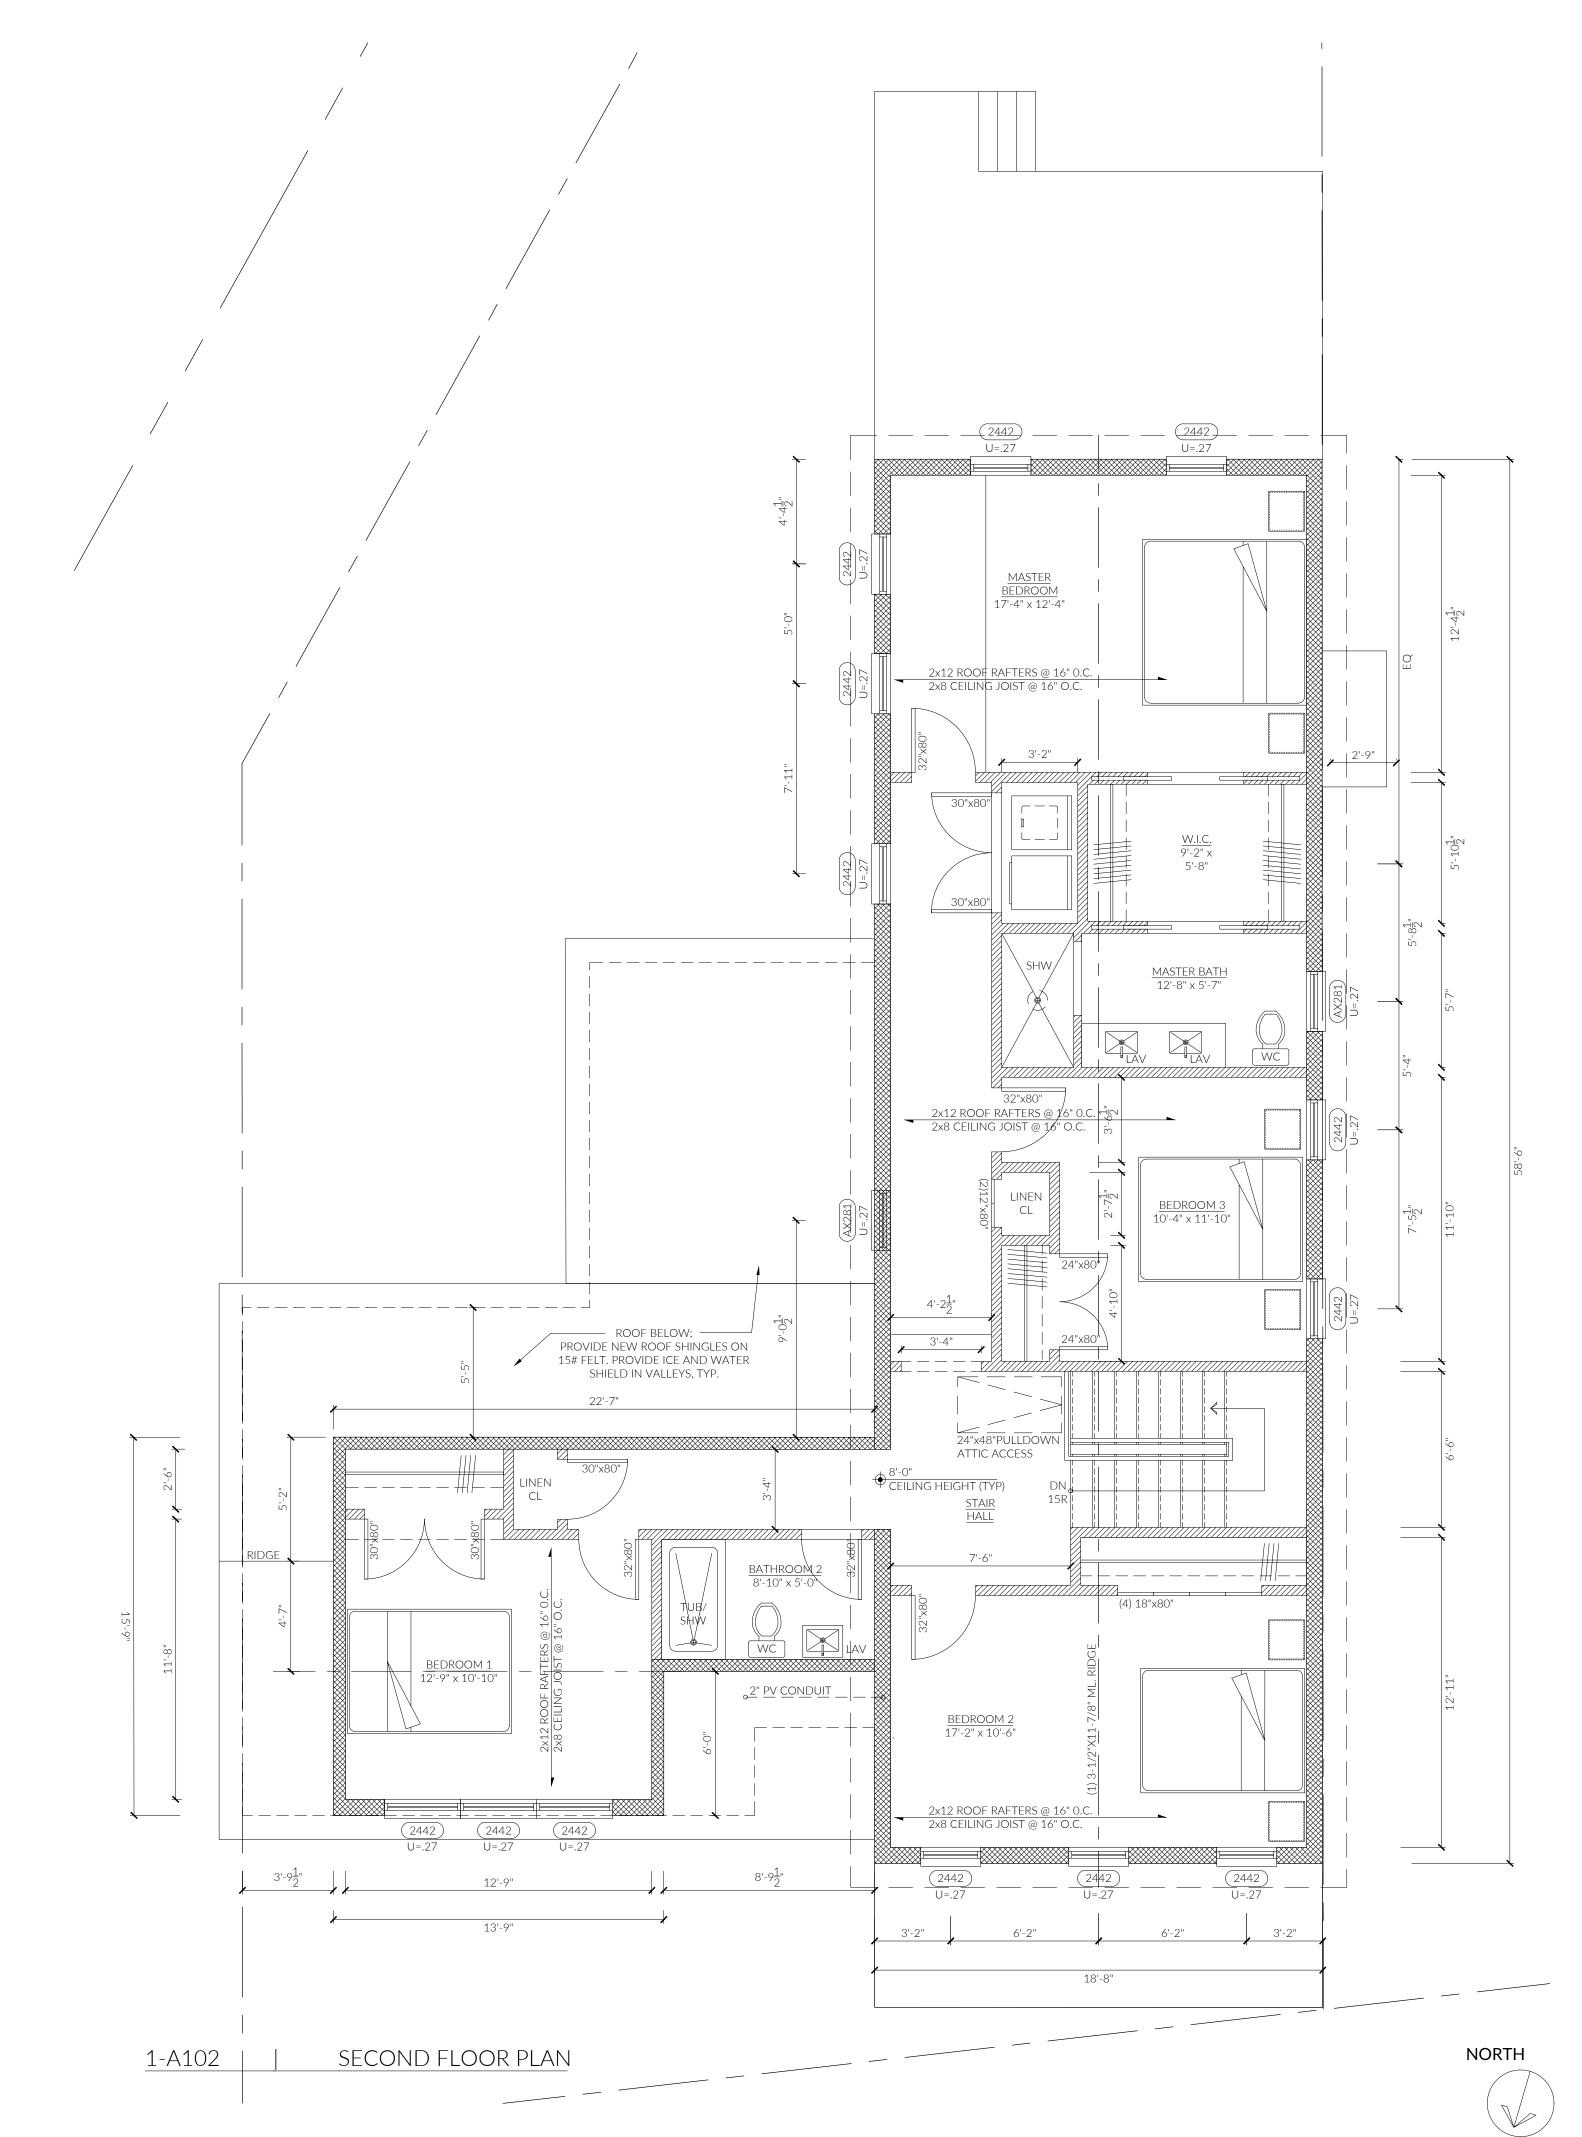

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# PROJECT ADDRESS:

475 KINGS HIGHWAY SPARKILL, NY 10983


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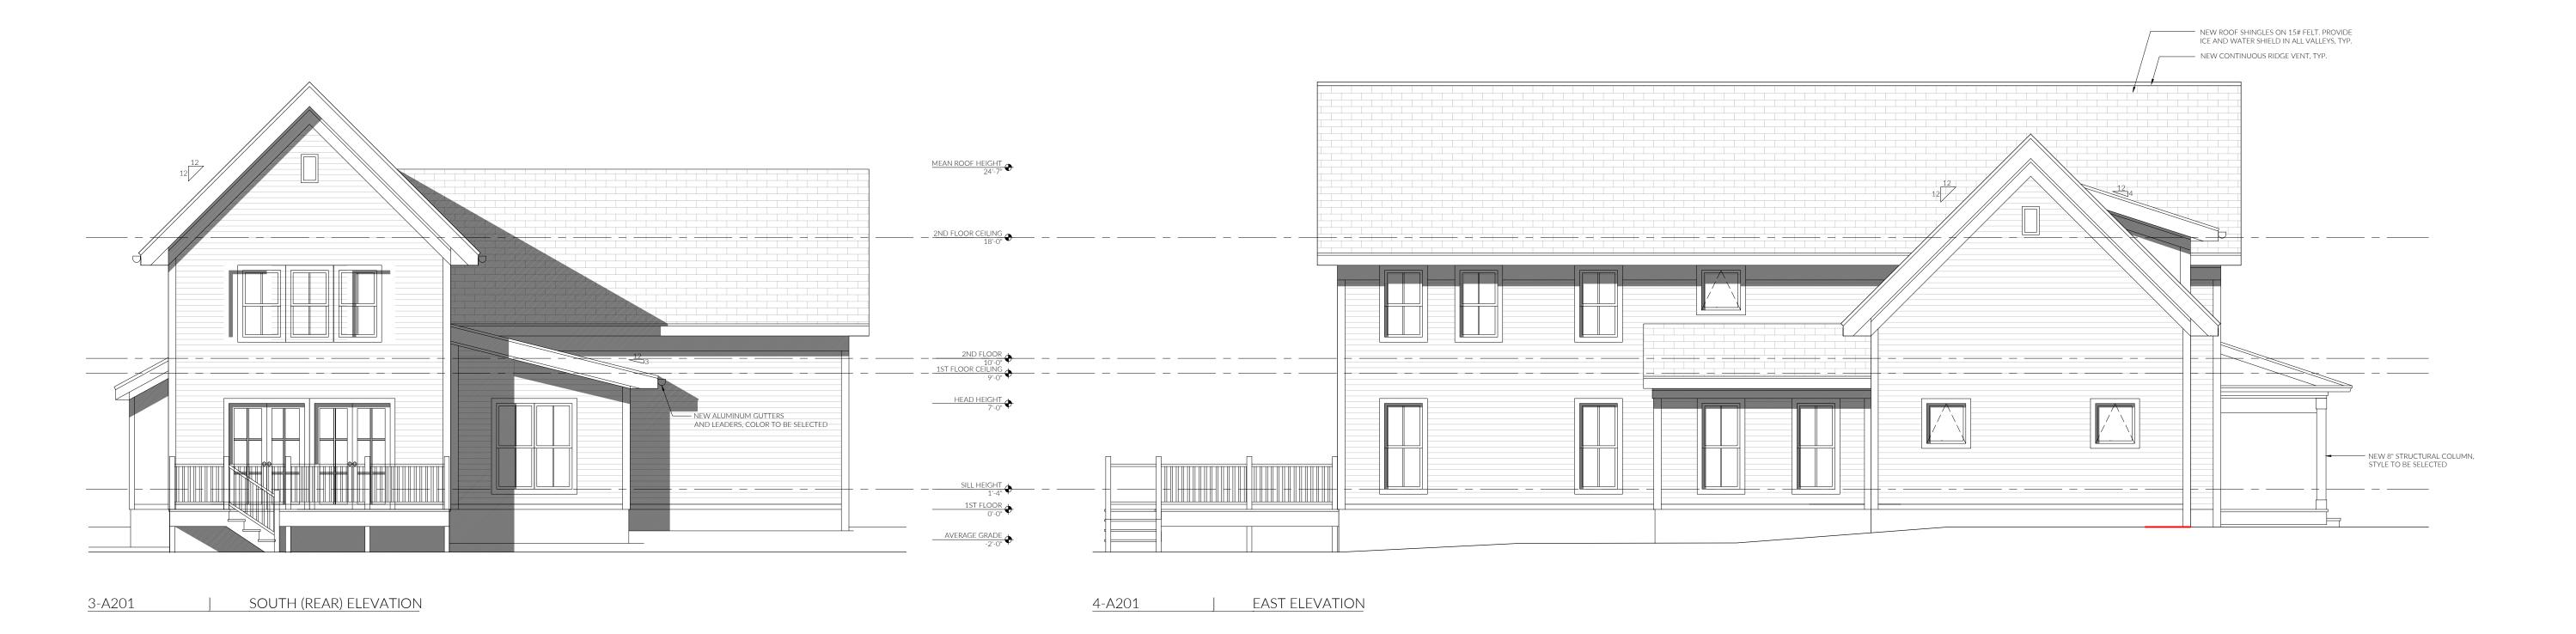
1/4" = 1'-0" SCALE:



03 OF 05 DWG. NO.

A 102.00



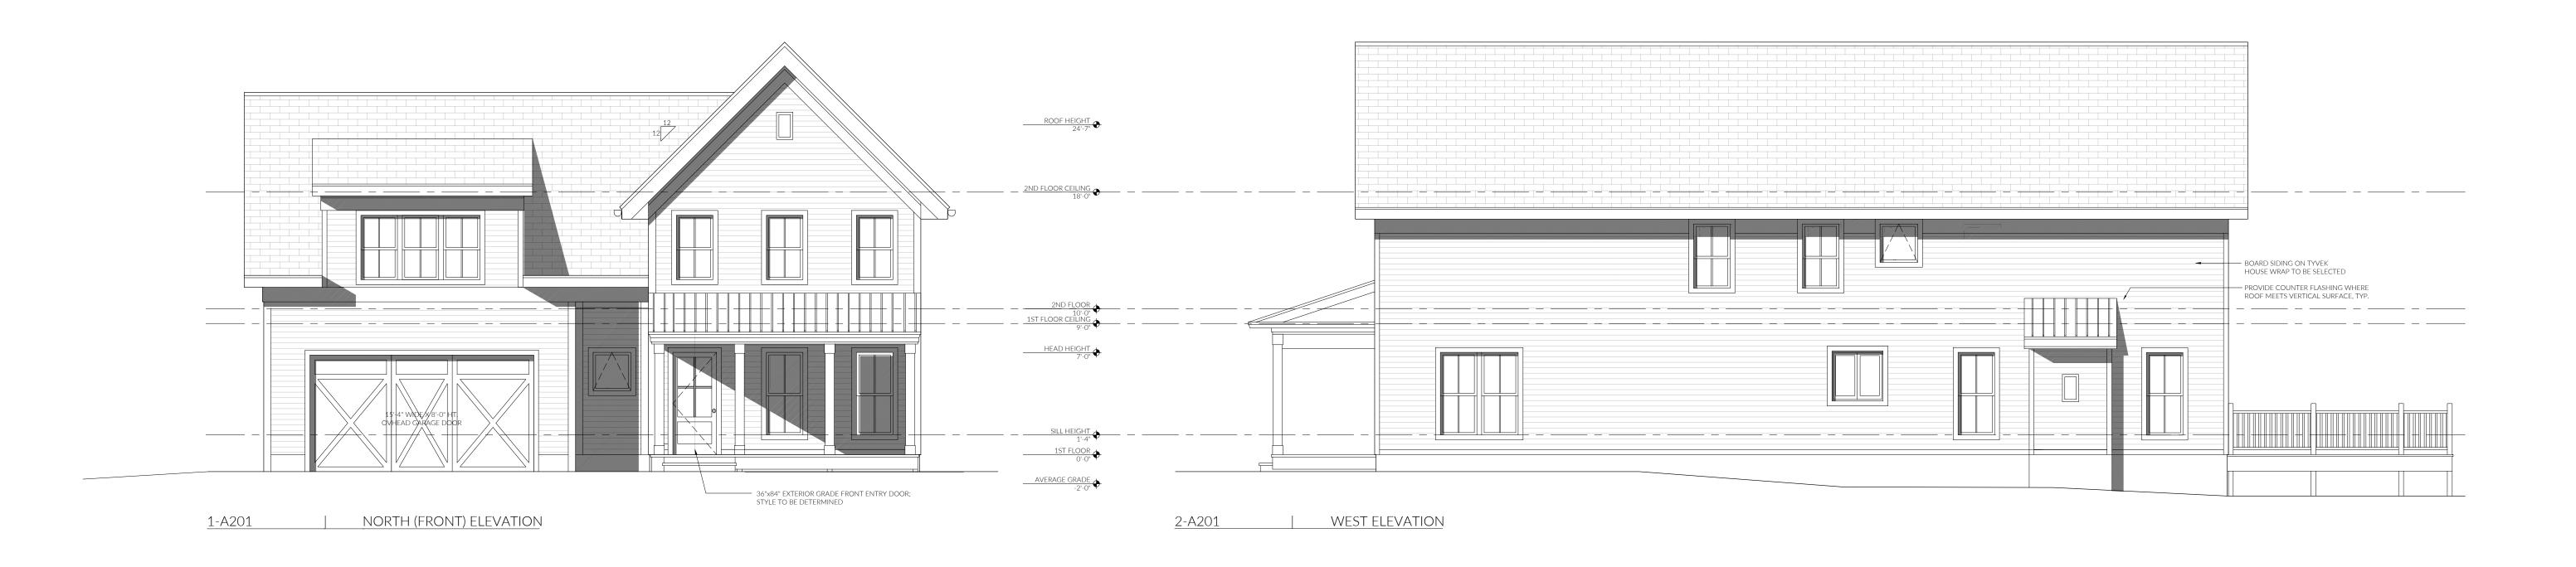

02/15/202 ISSUED FOR REVIEW

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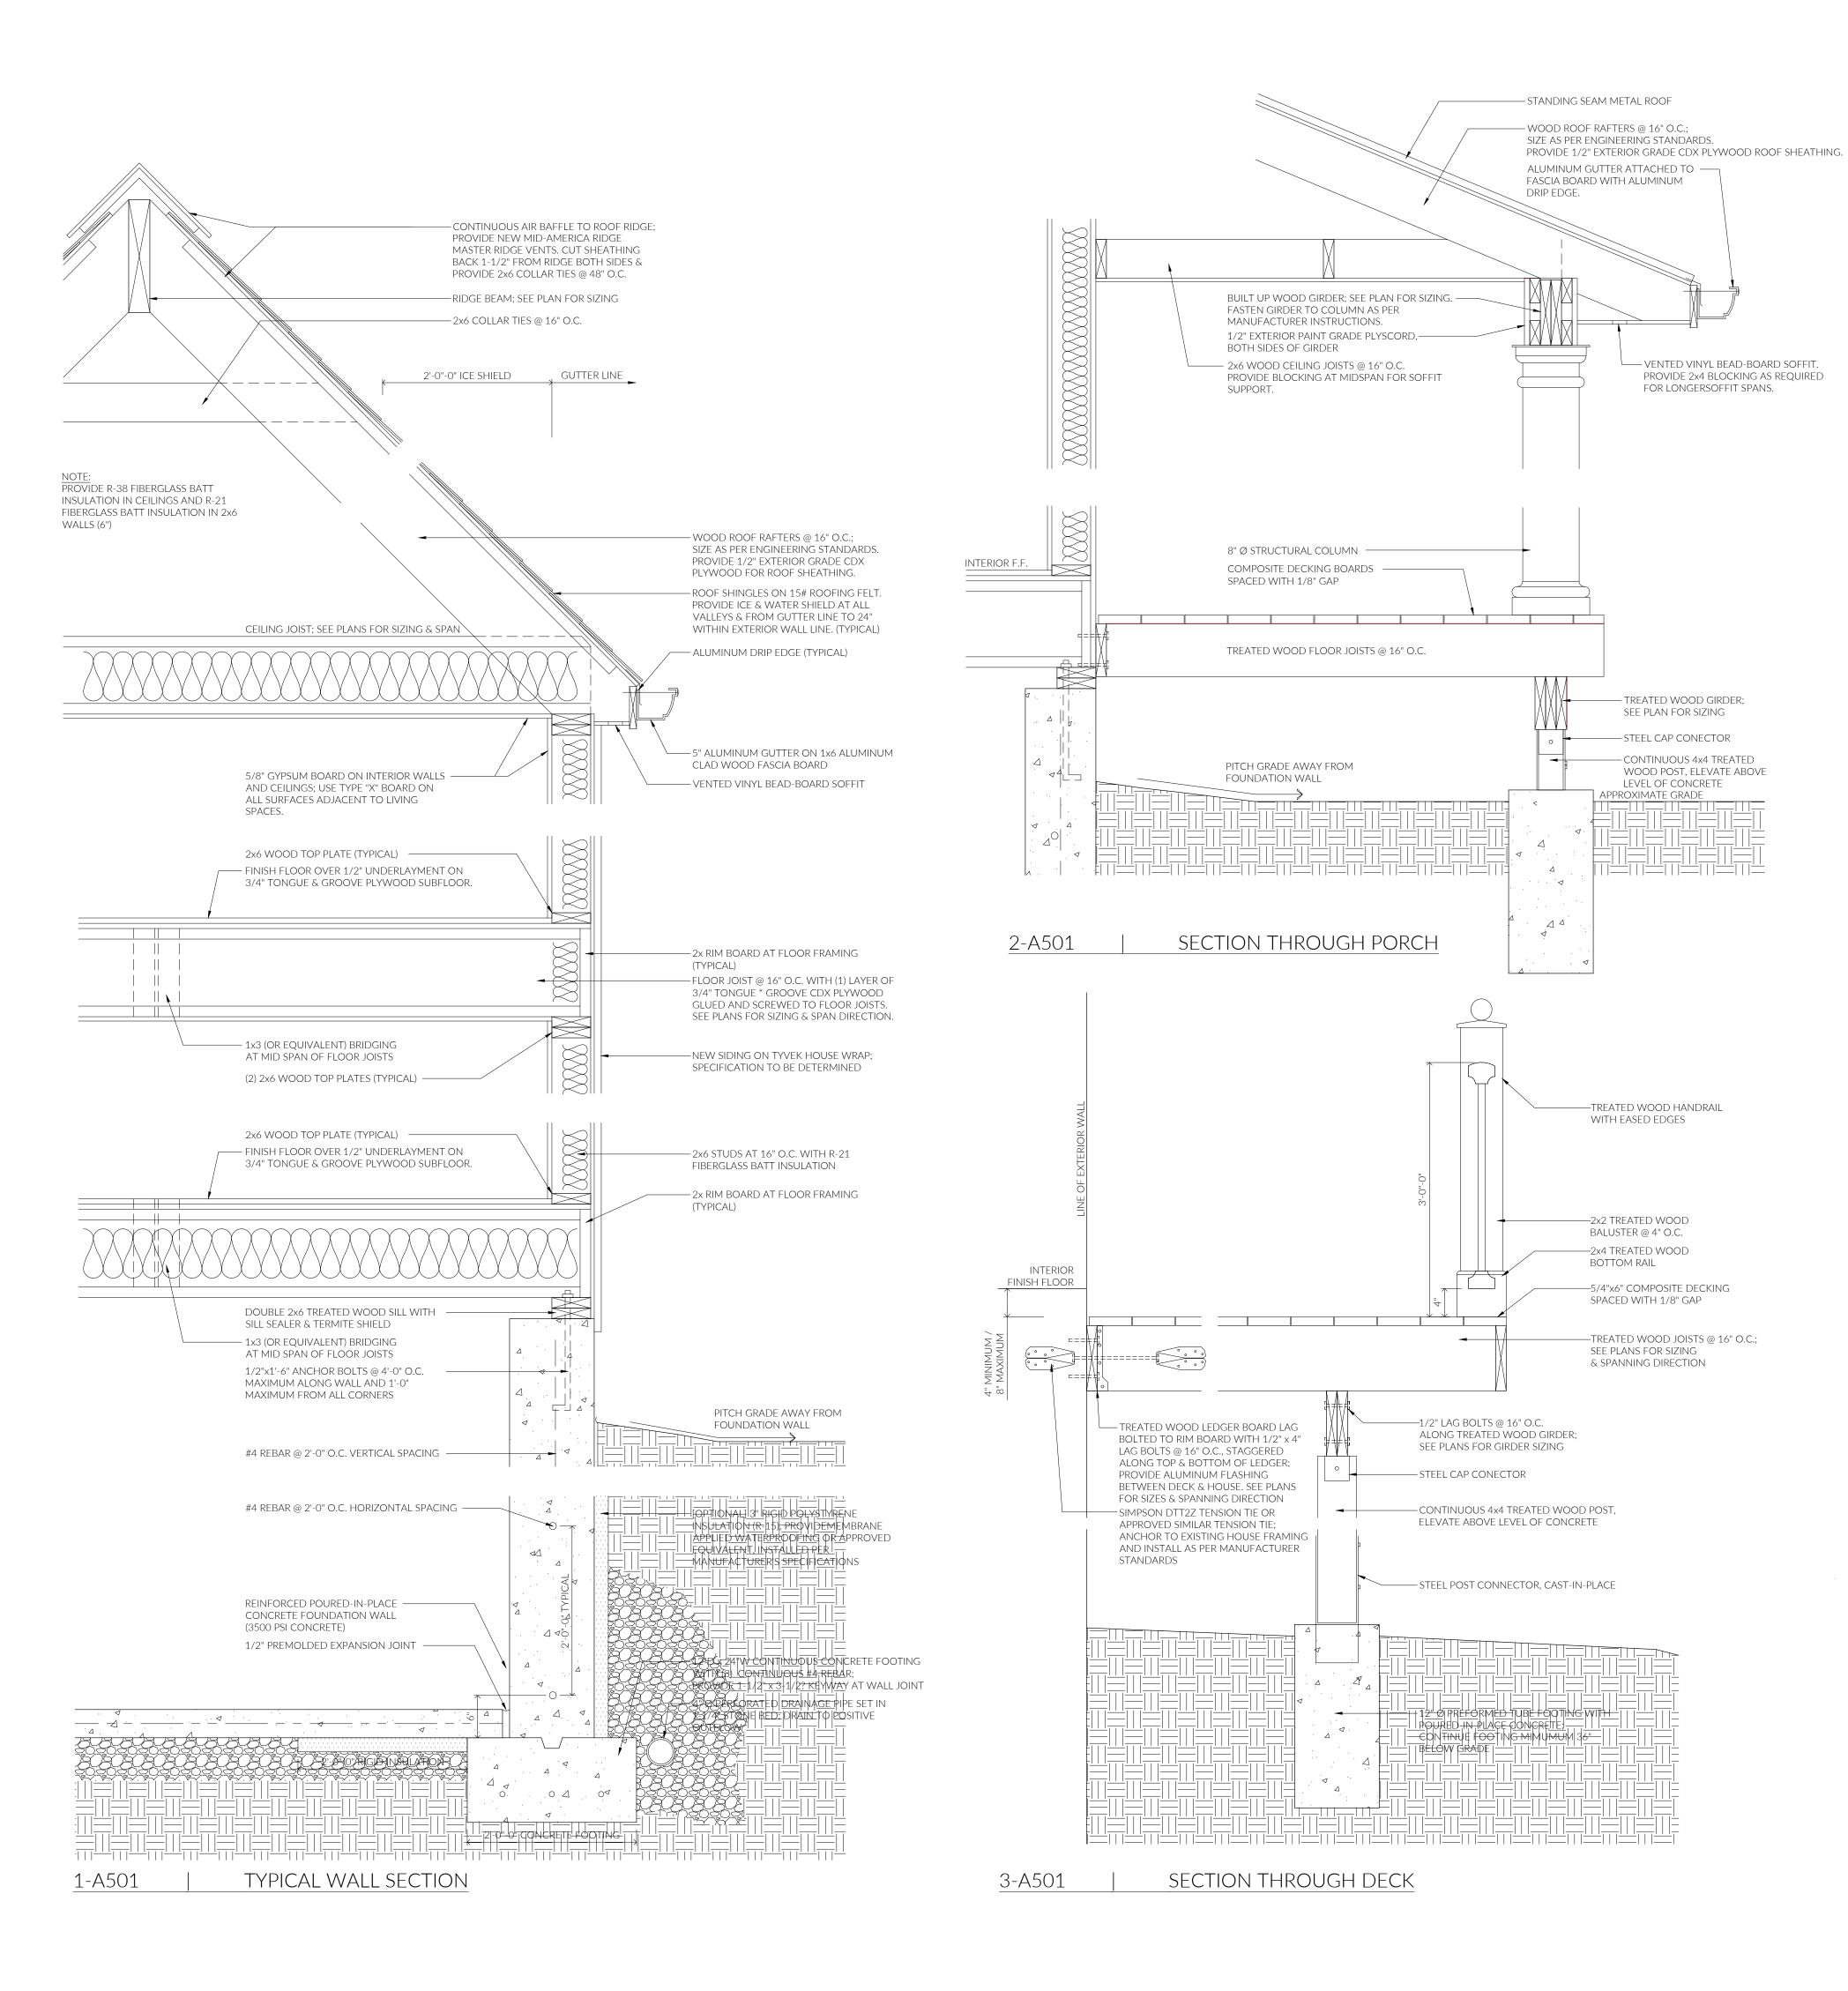
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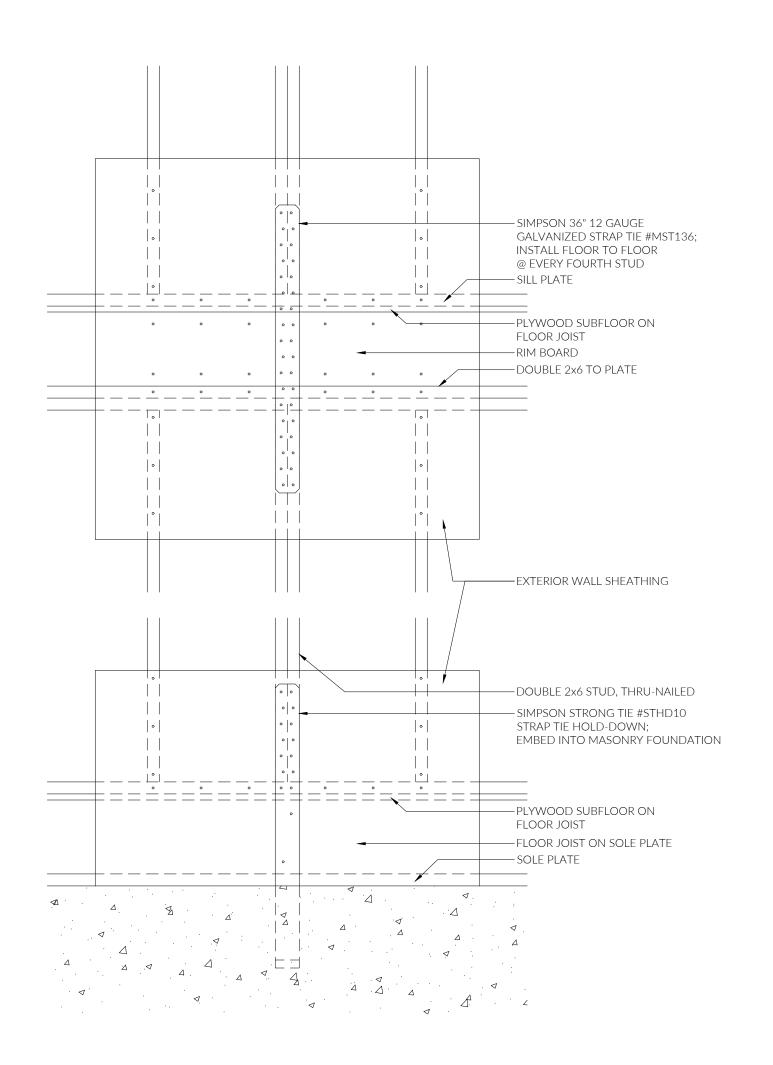


3/16" = 1'-0"

04 OF 05 DWG. NO.


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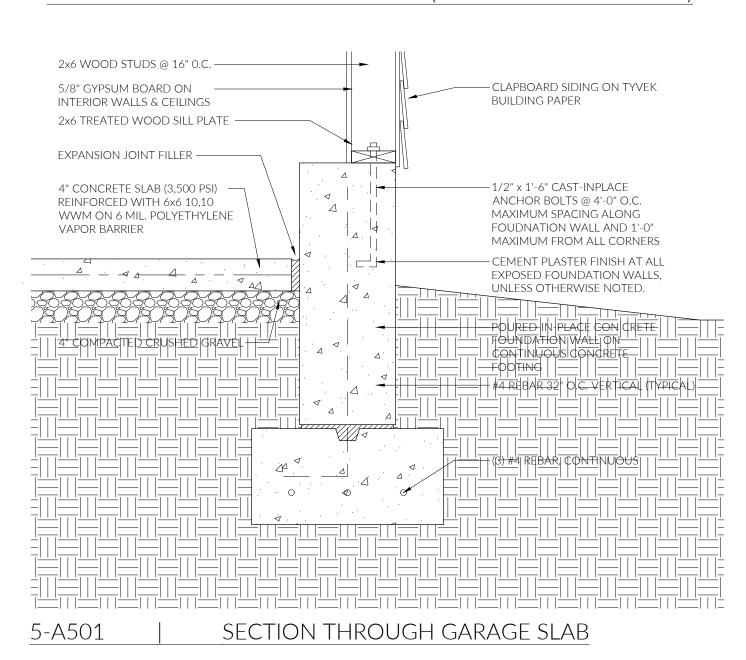


4-A501 | TIE-DOWN FRAMING DETAIL

NOTE:
INSTALL ALL STRAPS & TIES AS PER MANUFACTURER'S SPECIFICATIONS



## TYPICAL STEPPED FOOTING DETAIL (5-A501 SUPPLEMENTAL)

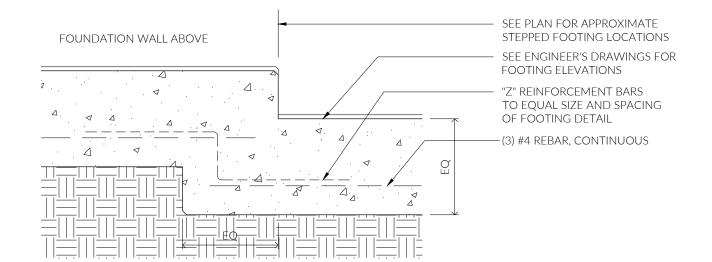

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# ARCHITECT: LUKE PETROCELLI, RA

51 STRATFORD RD, APT C3 BROOKLYN, NY 11218

PROJECT ADDRESS:
475 KINGS HIGHWAY
SPARKILL, NY 10983

DRAWING TITLE:

TYPICAL DETAILS

SCALE: 1" = 1'-0"



DWG. NO. 05 OF 05

A 501.00