Historical Areas Board of Review (HABR) Town of Orangetown Building Department

20 Greenbush Road, Orangeburg, New York 10962

PROP	ERTY ADDRESS: 200 KH65 HW	1 TAPPAN	Section/Block/Lot:	77.07/1	/35	
1.	Provide a narrative summary explaining	the project and	d including any facts	pertaining to thi	s project which	h

applicant feels would be of interest to the Board;

2. Architectural Plans;

It is preferable to the HABR if the Architect would appear at the meeting with the Applicant.
 Please bring SAMPLES of building materials to the meeting.

5. Materials checklist: (p	COLOR	MATERIAL	MANUFACTURER
Roof:		•	
Siding:			
Decorative Siding:			
Soffits & Fascia:			
Gutters & Leaders:			
Windows:			
Trim:			
Shutters:			
Front Door:			
Back Door:		·	
Garage Door(s):			
Other Door(s):			
Lighting:			
Lighting:			
Stone or Rock being used on Structure:			
Stone or Rock being used on walkway(s):	BLUE STOKE	SLABS	
BANA 22'x11-2'	ZINC/ROF	STANDING SEAM	DREXEL METALS
MMING DODL	BUE UNER	VIHYL	WEST ROCK POOLS, NANUET, NV

Name of Municipality: TOWN OF ORANGETOWN Date Submitted: 285EPT 2022

2022 LAND USE BOARD APPLICATION

	Please check all that apply: Commercial Residential				
	Planning Board Zoning Board of Appeals	Residential Historical Board Architectural Board			
	Subdivision Number of Lots Site Plan Conditional Use Special Permit Variance Performance Standards Review Use Variance Other (specify):	Consultation Pre-Preliminary/Sketch Preliminary Final Interpretation PERMIT#: ASSIGNED INSPECTOR: Referred from Planning Board: YES / NO If yes provide date of Planning Board meeting:			
_	Name: HAUSER STÆ PLAN				
Street #	Address: 200 KINGS HIGHWAY	TAPPAN, NY 10983			
		Lot(s): 35			
On the <u>\</u>	side of KINGS HIGHWAY feet NOTH of the intersection Orangetown in the hamlet/village of	on of OLD MILL LANE, in the			
S A	creage of Parcel	Zoning District R-15 Postal District TAPPAN Fire District TAPPAN Sewer District ORANGE TOWN			
Project APPA 15	1201 110 1 001 1101	ROUND SWIMMING POOL, ABANA.			
The under	signed agrees to an extension of the statutory time	limit for scheduling a public hearing.			


REVIEW

APPLICATION REVIEW FORM

FILL IN WHERE APPLICABLE. (IF THE FOLLOWING DOES NOT APPLY PLEASE MOVE ON TO THE NEXT PAGE)


If subdivis	sion:
1)	Is any variance from the subdivision regulations required?
2)	
3)	Is this a standard or average density subdivision?
If site plan	
1)	Existing square footage 4345
	Total square footage 8799
	Number of dwelling units
If special	permit, list special permit use and what the property will be used for.
Environm	ental Constraints:
Eliali Ollili	entai Constraints;
Are there slo	pes greater than 25%? If yes, please indicate the amount and show the gross
and net area	· · · · · · · · · · · · · · · · · · ·
	eams on the site? If yes, please provide the names. SPARKUL OFFK
VIE MEIG ME	tlands on the site? If yes, please provide the names and type:
Project Hi	story:
-	ect ever been reviewed before? <u>155</u>
	a narrative, including the list case number, name, date, and the board(s) you appeared
before, and the	ne status of any previous approvals
·	HABR APPROVAL ON JUNE 14, 2002, HABR #22-11
P	LANNING BOARD FINAL APPROVAL ON JULY 27, 2022 PB-21-
	= 1 1 1 1 1 1 1 1 1 1 1 1 1 1 1 1 1 1 1
l ist tax man	section, block & lot numbers for all other abutting and atting to the
this project.	section, block & lot numbers for all other abutting properties in the same ownership as
una project.	
_	


PAGE 9. OF 15

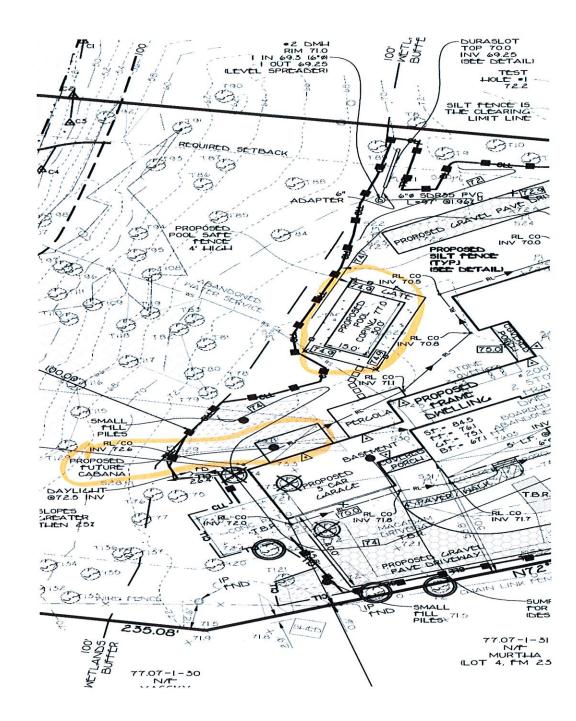

Site Plan View from Site Drawing 1 of 5.

NOTES : STANDARD EROSION CONTROL NOTES THIS IS A SITE PLAN OF LOT 55, BLOCK I, SECTION 77.07 AS SHOWN ON THE TOWN OF GRANCETOWN TAX MAP. EROSION CONTROL DATUM: DEEP HOLE AND PERC. DATA: LEGEND NAVO 1988 REFERÊNCE BENCHMARK - RMZI (CHISELED SQUARE ON HEADWALL OF ROUTE 503 BRIDGE OVER THE SPARKILL CREEK! LEGEND 500' LIMIT EX. ELEV. 72.2 PERC. FOR I TESTED AT EL/ 65.2 : 38 SEC - PASS. BOT. HOLE 582. WHERE EL/ NONE PROPERTY LINE PROPOSED USE RESIDENTIAL DWELLING STABILIZED CONSTRUCTION (1) BENCLIMARK ELEVATION 59.99 INGVD 19291 BUILDING SETBACK 5. RECORD OWNER: JOSEPH HAUSER 200 KINGS HICHMAY TAPPAN NY 10964 SANITARY SCHOOL TEST HOLE TP .2: FROM PANEL 360686 0006 C EFFECTIVE 8/2/19821 ELEVATION CONVERTED FROM NAVO 1929 TO NAVO 1988 USING CORPSCON - 59.99 (NAVO 1929) - 59.00 (NAVO 198 INLET PROTECTION EX. ELEV. 71.9 PERC. FOR 2 TESTED AT EL: 64.9:15 MIN 20 SEC - PASS BOT. FOLE: 58.9 WATER EL: NONE SAN, SEWER MANIJOLE RECORD APPLICANT: JOSEPH HAUSER ZOO KINGS HIGHMAY TAPPAN, NY 10964 SEWER SERVICE Z ALL DISTURBED AREAS EXCEPT ROADWAYS HAIGH MILL REMAIN UNFINISED FOR MORE THAN IN DAYS SHALL BE TEMPORARELY SECTED HITH IVE LS. OF PICE (AMASS OF MALLES NITH) INO LIBS OF STABLED AND SHALL BE THE STABLED AND SHALL BE APPORTED AS PRACTICAL BY INSTALLATION OF THE BASE COURSE. SILT PENCE Oco CLEAN-OUT HRE DISTRICT: TAPPAN HRE DISTRICT FLOODPLAIN NOTE: A FLOODPLAIN DEVELOPMENT PERMIT 15 REQUIRED FROM THE LOCAL FLOODPLAIN PERMIT DEVELOPMENT ADMINISTRATOR. WATER MAIN CLEARING LIMIT LINE -aL-SCHOOL DISTRICT: SOUTH ORANGETOWN CENTRAL SCHOOL DISTRICT WATER SERVICE WATER DISTRICT: VEOLIA WATER NY, INC. WATER VALVE */5175 SEWER DISTRICT: ORANGETOWN UTILITY COMPANY: ORANGE & ROCKLAND UTILITIES × CAS VALVE R.C.D.A. NOTE: NO WORK SHALL BE DONE AT THE SITE PRIOR TO OBTAINING THE REQUIRED STREAM CONTROL ACT PERMIT FROM THE RCDA. THE UNDERSIGNED, OWNER AND/OR APPLICANT, AS A CONDITION OF APPROVAL OF THIS SITE PLAN LERBELY ACRES TO COMPLETE THE WITHIN SITE DEVICEMENT FLAN AS DAMAN AND ALL IMPROVEMENTS SHOWN THEREON. THE APPLICANT/OWNER IS AWARE THAT NO CHANGES IN THIS PLAN AND FOR THE PROPERTY OF DRAIN PIPE CATCH BASIN 5. PROVIDE INLET PROTECTION TO ALL INLETS ON SITE SEE DETAIL ROOF LEADER UTILITY POLE 100 YEAR FLOOD PLAIN AND BO IO CONTOUR INTERVAL FLOOD WAY INFORMATION TAKEN FROM FEMA PANEL -502- 74 2' CONTOUR INTERVAL OMNER DATE 36087C01896 EFF. DATE 3/3/2014) 5013 +745 SPOT CRADE 5 ALL EXISTING OFF-SITE PAVEMENT, FENCES, CURBS, WALKS AND OTHER FACILITIES DISTURBED BY CONSTRUCTION SHALL BE RESTORED OR REPLACED BY THE CONTRACTOR AT NO ADDITIONAL COST. TOTAL PROPOSED SITE 4. EXISTING UTILITIES & STRUCTURES THAT ARE TO BE REMOVED AND/OR REPLACED SHALL BE REMOVED AND LEGALLY DISPOSED OF BY THE CONTRACTOR. DISTURBANCE =43,298 SF 5. PROJECT SAFETY AND TRAFFIC MAINTENANCE ARE THE SOLE RESPONSIBILITY OF THE CONTRACTOR. WETLANDS DELINEATED BY PETER ## 10% DRYWELL RIM 75.0 TOP CONC. 72.5 INV 12' CONN 62.5 BOTTOM 61.5 TORGERSEN 02/24/22 766 766 8. ALL NEW UTILITY SERVICE CONNECTIONS, INCLUDING LINES AND COUPMENT FOR PROVIDING POWER AND/OR COMMUNICATIONS, ARE TO BE INSTALLED UNDERGROUND. 9. THE EXTENT OF THE CONSTRUCTION AND DISTURBANCE AREAS SHALL BE THE MINIMUM REQUIR TO PERFORM THE CONTRACT WORK WITH AS MINIMAL EFFECT ON ADJACENT AREAS AS POSSIBLE: IO. ALL NEW STORM DRAINACE PIPING TO BE SMOOTH BORE CORRUGATED LICH DENSITY POLYETHYLENE FIGHEL UNLESS OTHERWISE SPECIFIED. TBT O II, ROOF LEADERS WHERE REQUIRED TO BE 4° DIA, SOR 35 PVC PIPE, AND WILL OUTLET TO DOWNSPOUTS ADJACENT TO THE PROPOSED BUILDINGS. IZ. ALL NEW MATER MAINS AND RELATED APPURTENANCES TO BE SPECIFIED BY ARCHITECTS MECHANICAL ENGINEER. 13. ALL SANITARY HOUSE CONNECTIONS TO BE 6" DIA CAST IRON WITH A MINIMUM GRADE OF 27 THE THRST CLEAN OUT OUTSIDE THE BUILDING, BEYOND THE TIRST CLEAN OUT, SOR 35 PVC PIPE MAY BE USED IN LIEU OF CAST IRON. 14. ANY SUBSTITUTIONS TO BE REQUESTED IN WRITING AND APPROVED BY THE DESIGN ENGINEER PRIOR TO CONSTRUCTION IS CONTRACTOR SHALL OBTAIN ALL NECESSARY PERMITS WITH RECARDS TO DEMOLITION AND LECAL DISPOSAL OF EXISTING STRUCTURES, WALKS AND DRIVEWAYS. I6. ANY EXISTING SANTARY SEVER HOUSE CONNECTION SHALL BE REMOVED IN ITS ENTIRETY FROM THE EXISTING HOUSE/STRICTURE TO THE SANITARY MAIN. THE CONNECTION SHALL BE CUT AND CAPPED AT THE MAIN. IT. WHERE FINISHED GRADE ELEVATION AT BUILDING WALL IS LESS THAN 24" BELOW THE FINISHED FLOOR CONSULT WITH ARCHITECT FOR CHANGES IN FOUNDATION AND SILL DESIGN IS CONTRACTOR TO OBTAIN AND SUBMIT SHOP DRAWINGS FOR ALL STRUCTURES TO DESIGN CHICKNEER FOR REVIEW AND APPROVAL BEFORE MANUFACTURING. 19. RETAINING WALLS SHALL BE LESS THAN 4 FEET IN LEIGHT. RETAINING WALLS MORE THAN 4 FEET IN HEIGHT ARE REQUIRED TO BE DESIGNED BY A CERTIFIED STRUCTURAL ENGINEER 20. THE CONSTINUM PELL IS TO BE DECORPORISHMED. IN ACCORDANCE WITH ARTICLE II OF THE ROCKLAND COUNTY SANTARY CODE LINESS A REVISED LETTER TO THE CONTRADY FROM THE ROCKLAND COUNTY SCHARMENT OF LEALTH IS RECEIVED PRIOR TO ISSUANCE OF A CERTIFICATE OF OCCUPANCY. 21. THIS PLAN IS BASED ON ARCHITECTURAL PLANS BY TROAM ARCHITECTURE RECEIVED ON 02/02/22. 22. AN INTERIOR CLECK VALVE SHALL BE PROVIDED ON THE SOIL LINE IF CAST IRON INVERT IS BELOW THE UPSTREAM MANLICLE RIM ELEVATION. 77.07-1-54 CALOMINO 77.07-1-33 26. ADDITIONAL CERTIFICATION BY AN APPROPRIATE LICENSED OR CERTIFIED DESIGN PROFESSION SHALL BE REQUIRED FOR ALL MATTERS BEFORE THE PLANNING BOARD INDICATING THAT THE DRAINING BOARD INDICATING THAT THE PROJUCT OF THE PROPERTY OF THE PROJUCT OF THE PROJUCT OF THE PROPERTY OF REGAN LOT 2, FM 2554) 9134 9135 Q102 10 AIRE FEE 77.07-1-32 27. LOT DRAINACE SHOWN SHALL CONSTITUTE EASEMENTS RUNNING WITH THE LAND AND ARE NOT TO BE DISTURBED. 28. THIS PLAN DOES NOT CONFLICT WITH THE COUNTY OFFICIAL MAP AND HAS BEEN APPROVED IN THE MAYNER SPECIFIED BY SECTION 239 LBM OF THE CENERAL MANCIPAL LAW OF THE STATE OF NEW YORK 77.07-1-29 N/F 77.07-1-31 N/T MURTHA (LOT 4, PM 2554) EROSION CONTROL INFORMATION: BRAUNTELD EROSION AND SEDIMENT CONTROL PLAN - CONSTRUCTION SEGUENCE I. ALL EROSION AND SEDIMENT CONTROL MEASURES SHALL BE IN PLACE PRIOR TO ANY CRADING OPERATIONS AND INSTALLATION OF PROPOSED STRUCTURES AND OR UTILITIES. 77.07-1-30 N/T ROWS 2. ALL EROSION AND SCHIMENT CONTROL MEASURES SHALL REMAIN IN PLACE AND BE MAINTAINED UNTIL CONSTRUCTION IS COMPLETED AND/OR STABILIZED. OLD 4. INSTALL SILT FENCE DOWN SLOPE OF ALL AREAS TO BE DISTURBED AND DOWN SLOPE OF ALL AREAS DESIGNATED FOR TOPSOIL STOCKPILING. IMPERVIOUS SURFACE EXISTING 9,126 S.F. PROPOSED 18,190 S.F. 200 KINGS HIGHWAY 5. CONSTRUCT BERMS, TEMPORARY SMALES AND PIPES AS NECESSARY TO DIRECT RUNOFF TO TEMPORARY SEDIMENTATION ENTRAPMENT AREAS. LOCATED IN NCREASE 9.064 TOWN OF ORANGETOWN 6. CLEAR EXISTING. TREES, VECETATION AND EXISTING STRUCTURES FROM AREAS TO BE FILLED OR EXCAVATED. STRIP AND STOCKPILE TOPSOIL FROM AREAS TO BE DISTURBED. SEED STOCKPILED TOPSOIL WITH TEMPORARY RYE CRASS COVER. (4,582 S.F. IS PERMEABLE) ROCKLAND COUNTY, NEW YORK NET LOT AREA CALCULATION: 507 DEDUCTION FOR 100 YEAR FLOOD PLAIN 15164 SF. / 507 = 7.582 SF. CHUB/2022 7. PERFORM EXCAVATION AND FILL TO BRING LAND TO DESIRED CRADE: ANY DISTURBED AREAS TO REMAIN BARE SHOULD BE SEEDED WITH TEMPORARY RYE CRASS. AREA OF DISTURBANCE 43,230 S.F. GRAPHIC SCALE 8. INSTALL UNDERGROUND UTILITIES MANIFOLES AND CATCH BASINS. CRATES OF CURB AND FIELD INLETS SHOULD BE LEFT AT ELEVATIONS WHICH PERMIT PROPER COLLECTION OF SURFACE RUNOFF. 507 DEBUCTION FOR FOR SLOPE AREAS OVER 257 9,502 St. / 507 = 4,751 St. BULK TABLE IO CONSTRUCT CURBS AND INSTALL BASE AND BINDER COURSES OF PAVED AREAS RAISE CRATES OF THE CURB AND HELD INLETS ACCORDINGLY. GROSS LOT AREA - TOTAL DEDUCTION - NET LOT AREA 132.837 SF: - 12.555 SF: - 120.504 SF: (IN FEET) 1 inch = 30 f SPARACO & YOUNGBLOOD, PLLO YB-6621 ALL UTILITIES ARE SHOWN IN AN APPROXIMATE MAY FROM AVAILABLE INFORMATION THE CONTROL OF SUBLIMALITY THE AVAILABLE INFORMATION THE CONTROL OF SUBLIMALITY OF A LAWE ALL UNGER/RAVIO UTILITIES MARKES IN THE PRIOR TO ANY CLEARING, OR ANY CONSTRUCTION THE CONTRACTOR SHALL ALSO VERRY THE LOCATION SIZE AND INVERTY OF ALL UTILITIES PRIOR TO ANY CONSTRUCTION AND SUBJECT OF THE LANDS MAY NOT BE SHOWN ON THE SHOWN OF THE LANDS MAY NOT BE SHOWN ON THIS DRAWN IZ. INSTALL SURFACE COURSE OF PAVEMENT, RAISE CRATES OF CURBS AND FIELD INLETS TO FINAL ELEVATION FLOOR AREA RATIO CALCULATIONS: GROSS FLOOR AREA / LOT AREA - FAR IS NYTH PART 755 SECURES & HORREL DAYS NOTICE PRICE TO START OF ANY UNDERLANDED HORS OUIRED 50 CIVIL ENGINEERING * LAND SURVEYING EXISTING 120,504 155.9 295 50 158 279 155.57 0.04 23 DIG 5AFELY 18 NORTH MAIN STREET P.O. BOX 818 HARRIMAN, N.Y. 10926 TEL: (845) 782-8545 FAX: (845) 782-5901 AUG. 5, 202 £XISTING: 4,345 Sf. / 120,504 Sf. = 0.0361 (0.04) 120,504 155.9 287 45 107 14. FOR INDIVIDUAL HOUSE & SEPTIC CONSTRUCTION FOLLOW STEPS #1 TO #15 WHERE APPLICABLE OPOSED 233 155.57 0.09 23 IS, BARE SOIL SHOULD BE SEEDED WITHIN IA DAYS OF EXPOSURE WHENEVER CONSTRUCTION IS SUSPENDED OR COMPLETED, AREAS SHOULD BE SEEDED DOWN OR MULCHED IMMEDIATELY. UPON COMPLETION A PERENNIAL MIX NEEDS TO BE VISED TO UNIVERSE CONTINUAL STABILIZATION. PROPOSED: 9.962 SF: / 120.504 SF: = 0.0827 (0.09) 1" - 50"

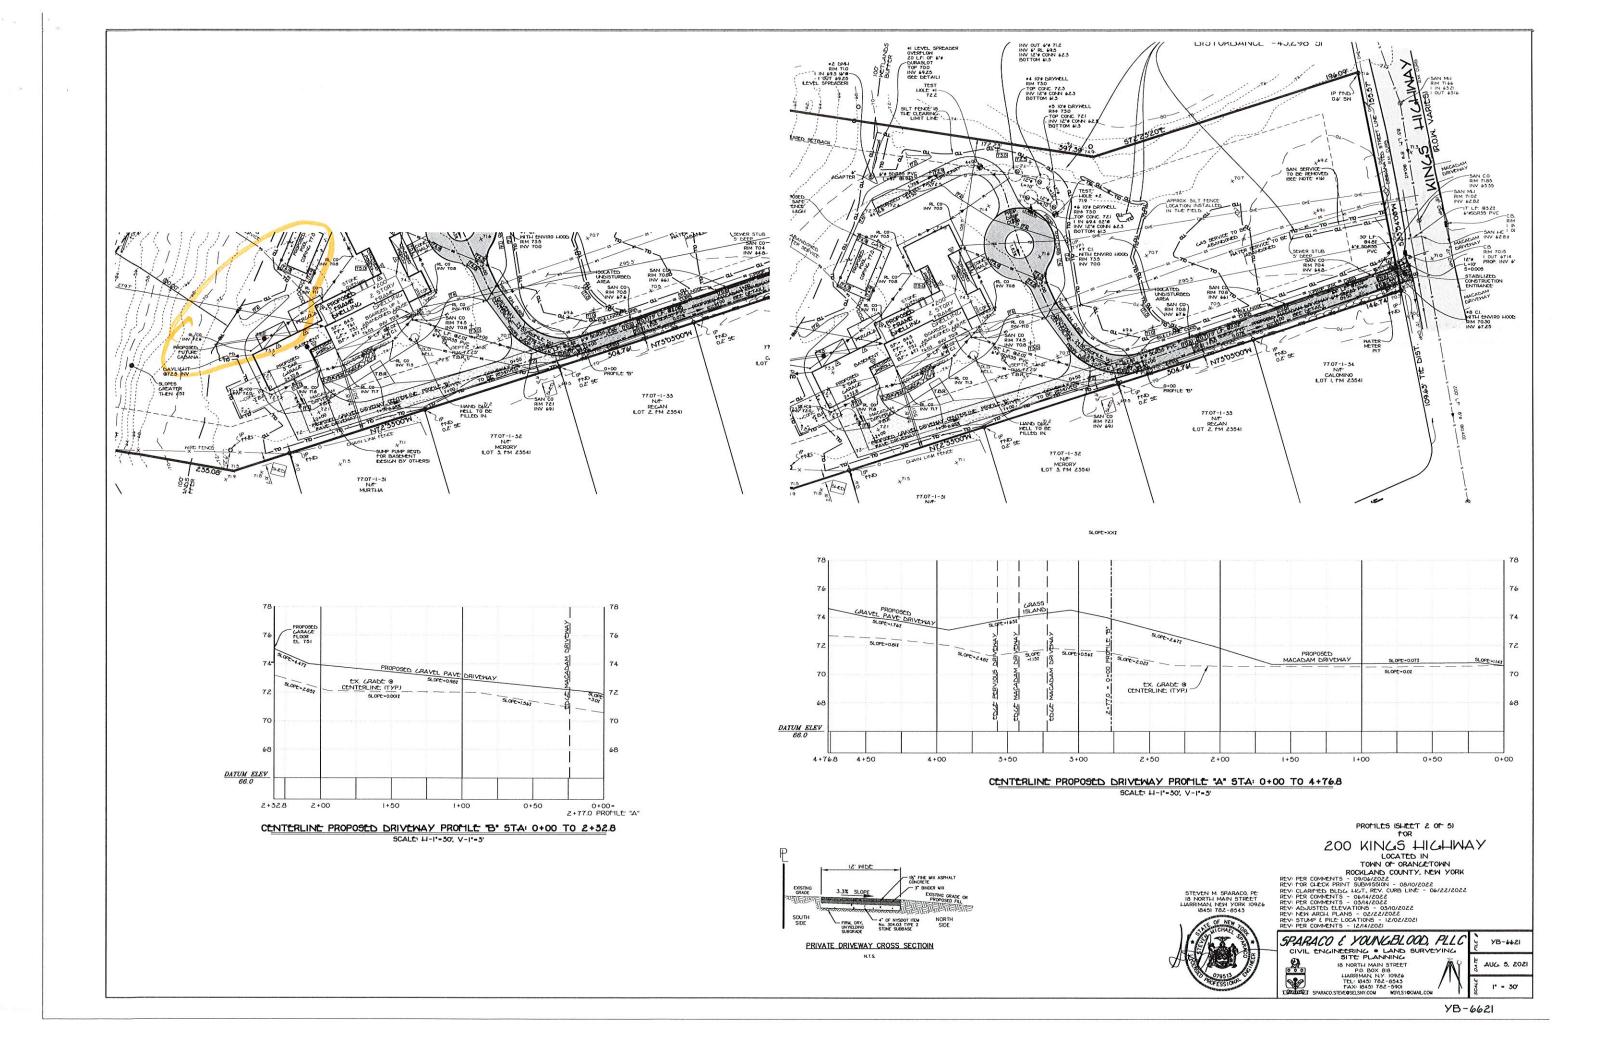

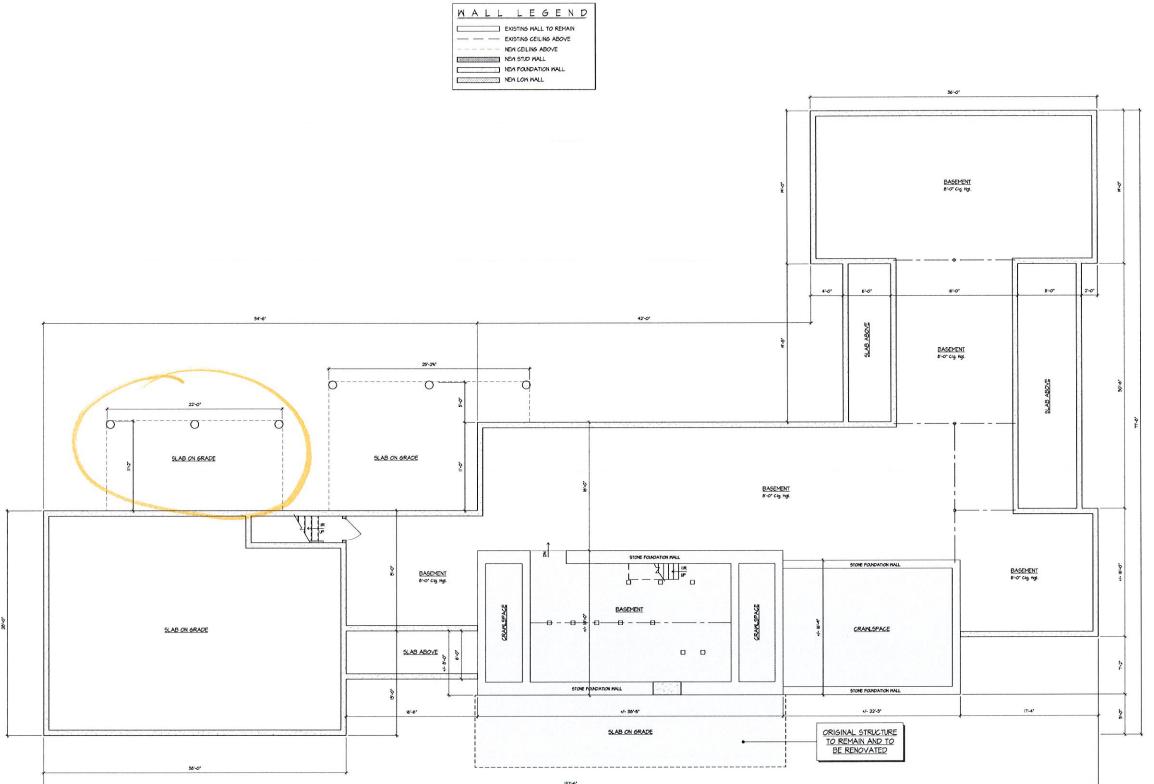

House Renovation And Additions For:

HAUSER RESIDENCE
200 KINGS HIGHWAY
TAPPAN, NEW YORK 10983

ARCHITECTURE
181 OLD TAPPAN, DV 10983
1, 845.287.8479 www.roamarch.com


FOUNDATION PLAN
DESIGN SCHEME #9



DATE: 02-02-2022 DRAWN BY: RP SCALE: AS NOTED JOB NO.: 2021.06


2K 0 U

PROPOSED FOUNDATION PLAN
SCALE: 3/6'- 1'-0'

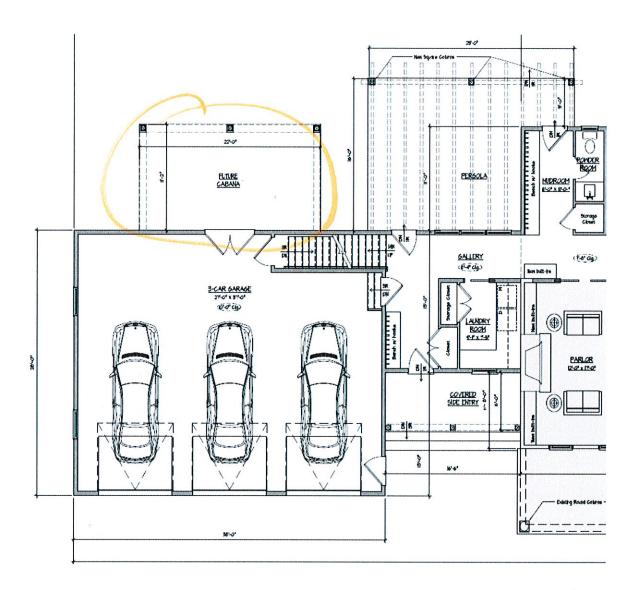

Cabana Plan View from Drawing SK-9.1



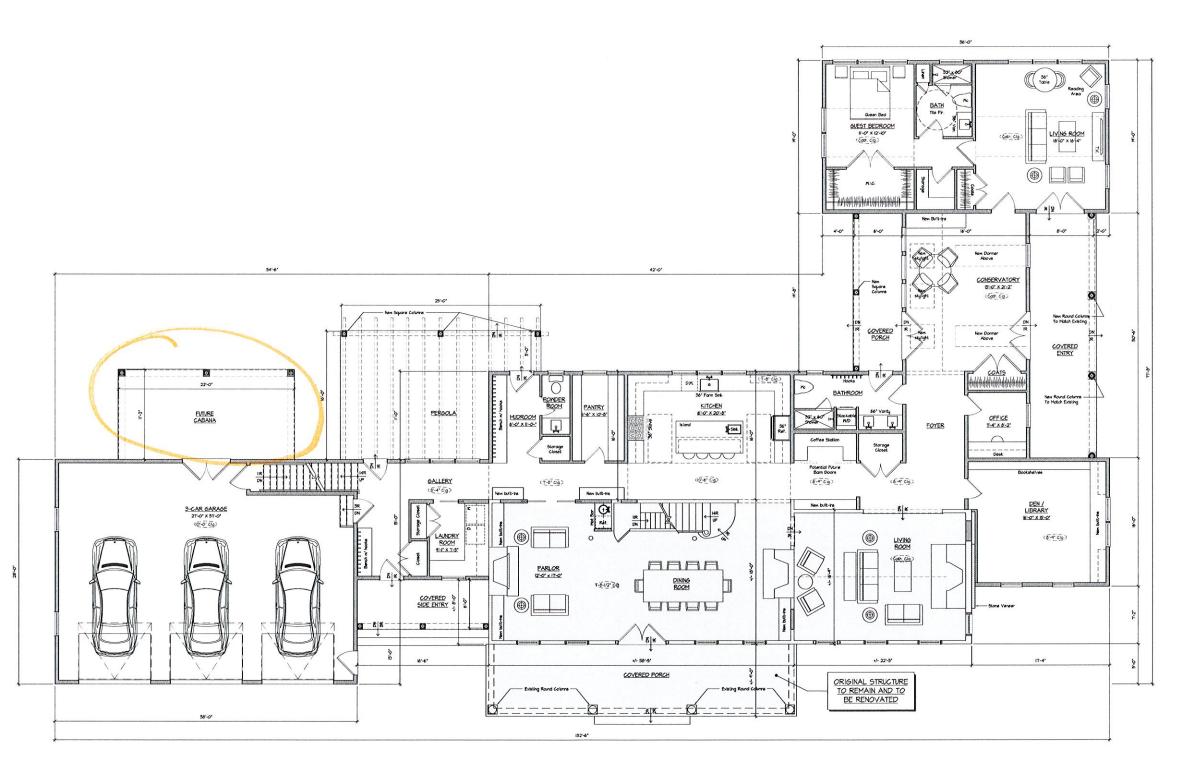

ARCHITECTURE
181 OLD TAPPAN, NY 10983
t. 845.287,8479 www.roamarch.com

RECORD OF ISSUES
UE DATE DESCRIPTION

House Renovation And Additions For:
HAUSER RESIDENCE
200 KINGS HIGHWAY
TAPPAN, NEW YORK 10983


FIRST FLOOR PLAN DESIGN SCHEME #9




DATE: DRAWN BY: SCALE: JOB NO.:

02-02-2022 f: RP AS NOTED

SK-9.1

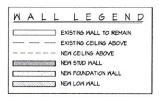

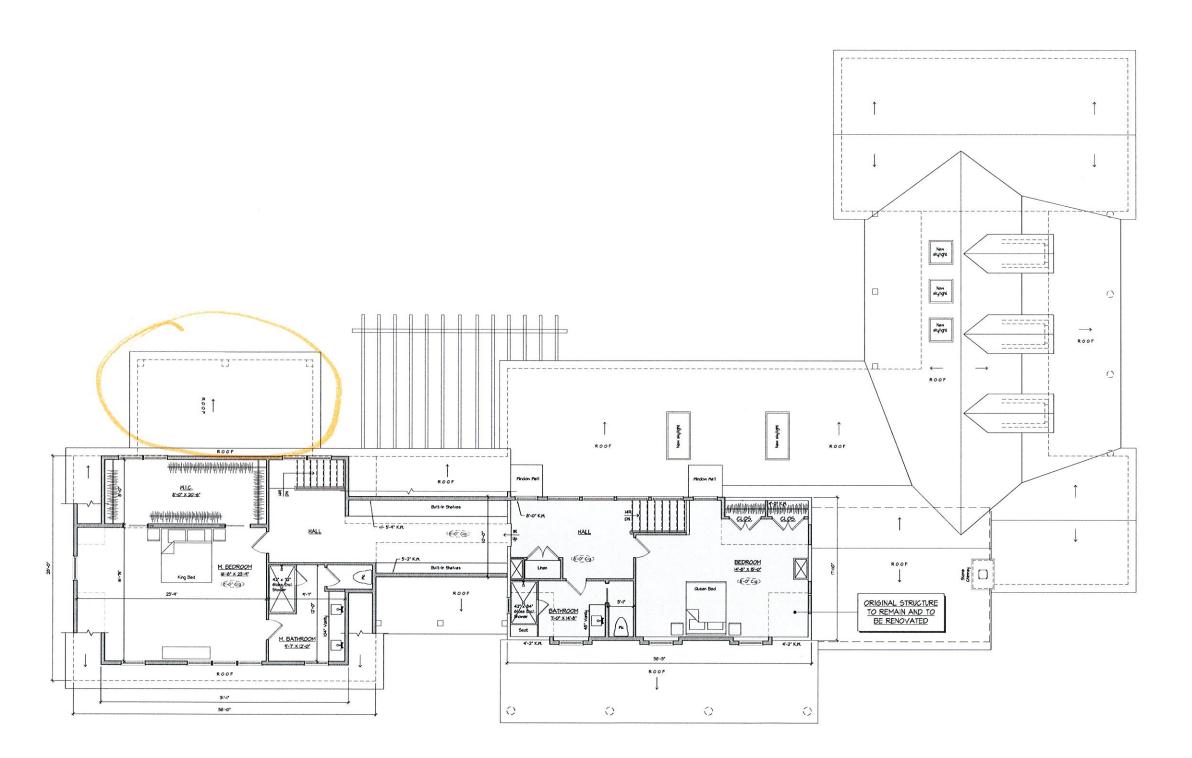

ARCHITECTURE
181 OLD TAPPAN, DY 10983
1, 845.287.8479 www.roamarch.com

NOTE:
Within femention on this drawing
Within femention on this drawing
SCALE dimensions directly off or
SCALE dimensions directly off or
SCALE dimensions directly off or
SCALE dimensions of the
SCALE dimensions of the
Office and SCALA ACCUTECTURE
PLIC and the ordered of any
conditions from the dimensions and
conditions above no this drawing, RECORD OF ISSUES STATE DESCRIPTION STATE DESCRIP

House Renovation And Additions For:
HAUSER RESIDENCE
200 KINGS HIGHWAY
TAPPAN, NEW YORK 10983


SECOND FLOOR PLAN DESIGN SCHEME #9



DATE: 02-02-2022 DRAWN BY: RP SCALE: AS NOTED JOB NO.: 2021.06

SK-9.2

PROPOSED SECOND FLOOR SCALE: 3/6': 1'-0'

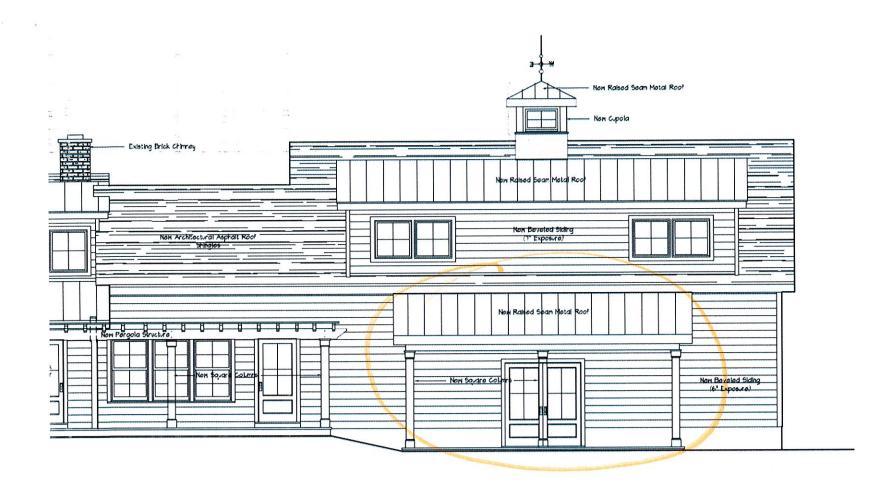

Cabana Elevation from Drawing SK-9.3



ARCHITECTURE
181 OLD TAPPAN D. TAPPAN, NY 10983
t. 845,287,8479 www.roamarch.com

NOTE:
Without characteristics on this drawing shall have precedented, DO NOT SOLL Effectiveness developed of the characteristics of the c

RECORD OF ISSUES

House Renovation And Additions For:
HAUSER RESIDENCE
200 KINGS HIGHWAY
TAPPAN, NEW YORK 10983

EXTERIOR ELEVATIONS DESIGN SCHEME #9



DATE: 02-02-2022 DRAWN BY: RP SCALE: AS NOTED JOB NO.: 2021.06

SK-9.3





