arthur Coletun 110#50633

0 10 20 30

ANTHONY R. CELENTANO P.L.S.
31 ROSMAN ROAD
THIELLS.N.Y. 10984
845 429 5290 FAX 429 5974

SURVEY FOR DALTON

Town Of Orangetown SEP 1 2022 ARCHITECTURES COMMUNITY
APPEARANCE BRD OF REVIEW

PLACE PROSPECT

£Q(

MACADAM DRIVE

ROOM

SAINT JOHN STREET

NINNT EENCE

M "00,17°01 S

139.70°

VINNL FENCE

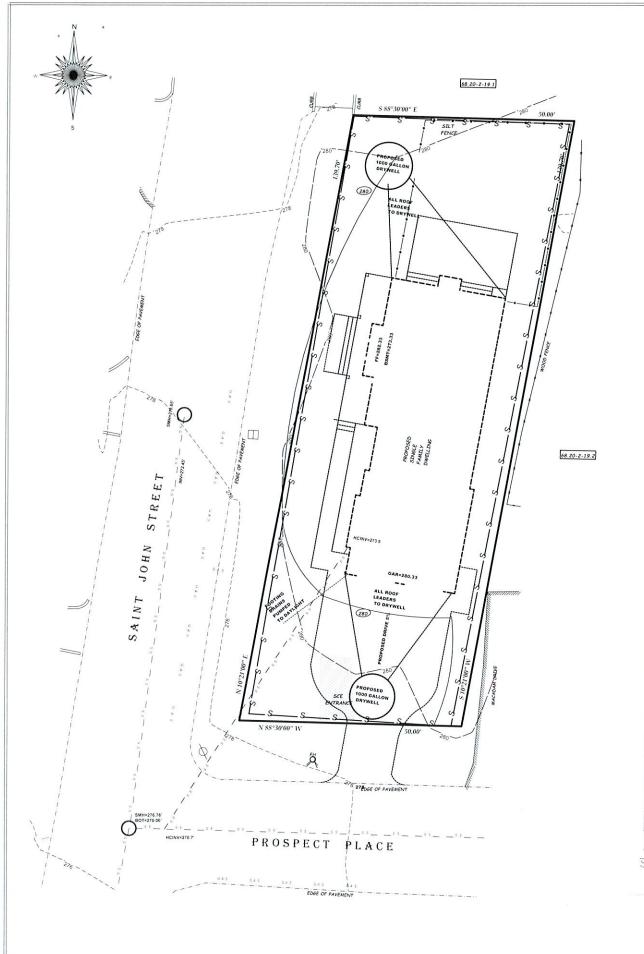


Figure 2.1 Stabilized Construction Access


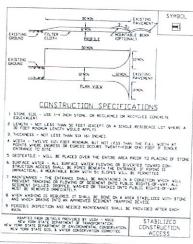


Figure 5.30 Reinforced Silt Fence

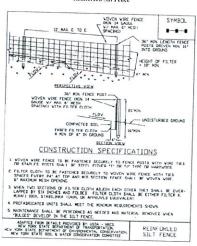

LOT AREA = 6,901.84 SQUARE FEET TAX:MAP DESIGNATION: 68,20-2-37

PCS - 1197 PRECAST CONCRETE SALES CO OR APPROVED EQUAL

DRYWELL GRATE DETAIL

PROPOSED DRAINAGE PLAN FOR

GRATE (SEE DETAIL)

DRYWELL DETAIL
(WOODARD'S PRODUCTS INC DW-6 OR APPROVED EQUAL
CAPACITY 1,000 GALLONS (4500 PSI CONCRETE)

DALTON



TOWN OF ORANGETOWN. ROCKLAND COUNTY

FILTER FABRIC

PEARL RIVER. NEW YORK

MAY 16. 2022

0 10 20 30

ANTHONY R. CELENTANO P.E. 31 ROSMAN ROAD THIELLS. N.Y. 10984 845 429 5290 FAX 429 5974

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SCALE . 1' = 10


LIST OF DRAWINGS

ARCHITECTURAL DRAWINGS

SHEET DESCRIPTION

- A-O SITE LOCATION PLAN, NOTES, LIST OF DRAWINGS A-I FIRST FLOOR / SITE PLAN, SECOND FLOOR PLAN A-2 ELEVATIONS A-3 ELEVATIONS

SITE LOCATION PLAN AND BULK TABLE

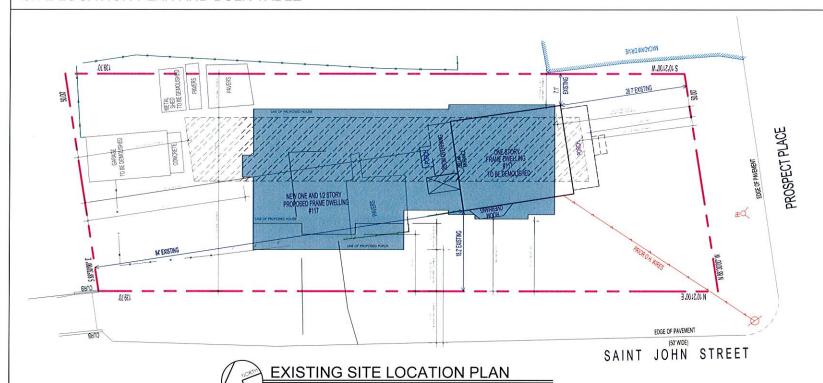

SITE DATA ZONING BULK TABLE 1 17 PROSPECT PLACE - PEARL RIVER NY 10965 TAX MAP - SECTION 68.20, BLOCK 2,LOT 37- RG ZONE - Group Q EXISTING NON CONFORMING CORNER LOT - (5.112) AND 5.21 (d) and (e)

SITE PLAN IS BASED ON A SURVEY PROVIDED BY OWNER

LOT REQUIRED 10,000 S.F.	EXISTING LOT AREA = 6,970 +/- SQ. FT. (.16 acres)	EXISTING LOT AREA = 6,970 +/- SQ. FT. (.16 acres)	ENC
FAR30 (30 %)	EXISTING FAR - 1,419 / 6,970 = .2035 (20.35 %)	PROPOSED FAR - 3,303 / 6,970 = .4739 (47.39 %)	VARIANCE
FRONT YARD SET BACK: 25'-0"	22.83' PROSPECT / I G.33' JOHN STREET	9'-5" (Variance John Street) and 30'-0" Prospect	VARIANCE JOHN 51
SIDE YARD SET BACK: 10'-0"	7.1'	7.0' (Variance 3' - (5.2 d - 10')	VARIANCE
COMBNED SIDE YARD SETBACK - 30'-0" REQUIRED	N/A - CORNER LOT (5.112)	N/A - CORNER LOT (5.112)	N/A - CORNER LOT (5.112)
REAR YARD SET BACK: 25'-O"	76.33'	35'-10"	
LOT WIDTH: 75'-0"	50'-0"	50'-0"	ENC
STREET FRONTAGE: 50'-0"	50'-0"	50'-0"	EXISTING
HEIGHT I'-O" PER I'-4"	MAX 20'-0" 5.21 (e)	23'-1" (Variance 3'-1")	VARIANCE

EXISTING F.A.R. DATA

EXISTING FIRST FLOOR	7185.F.
EXISTING SECOND FLOOR	514 S.F.
EXISTING GARAGE	187 S.F.
EXISTING TOTAL S.F.	14195F

EXISTING FAR - 1,419/6,970 = .2035(20.35%)

PROPOSED F.A.R. DATA

FIRST FLOOR SECOND FLOOR	1,156 S.F. 1,363 S.F.	
PROPOSED HOUSE S.F.	2,519 S.F.	
GARAGE PORCH	592 S.F. 192 S.F.	
PROPOSED TOTAL S.F.	3,303 S.F.	

PROPOSED FAR - 3,303 / 6,970 = .4739 (47.39 %)

IF A CONFORMING LOT

PROPOSED FAR - 3,303 / 10,000 = .33.03 (33.03 %)

WITHOUT A FRONT PORCH

PROPOSED FAR - 3, 111 / 10,000 = .3111 (31.11 %)

GENERAL NOTE: (SEE SPECIFICATIONS)

- 1. All work and materials shall conform to all local, county and New York State 2020 Residential Code and NYS Stretch Code.
- 2. Contractor to consider all dimensions approximate pending field verification, prior to construction, consult architect as required.
- 3. Contractor to furnish and provide all labor materials and equipment required to fully complete the job as shown on these documents. Except where specifically agreed on by owner, job shall be ready for occupancy in a good workmanship manner with all work done as shown or reasonable intended on documents. It shall include but not limited to:

A. Building permit

B. Certificate of Insurance

C. Demolition as required D. Excavation E. Masonry

F. Carpentry G. Roofing and Flashing

H. Siding 1. Caulking/Sealant

J. Gutters and leaders K. Insulation

L. Gypsum board and taping

M. Painting and Finishing N. Trim work

O. Heating P. Electrical

Q. Plumbing

4. Contractor shall furnish and install interior paint and exterior paint as specified.

- 5. All framing lumber to be #2 Douglas Fir or better. All new work and materials unless otherwise specified shall match existing construction.
- 6. All materials shall be installed in strict accordance with manufacturers specifications.
- 7. All windows are to be "ANDERSEN Windows" as shown on the drawings. Pricing to include grilles and screens. Contractor to also include interior extension jambs for 4/6" stud walls additional extensions required shall be field installed and casing to match existing house trim. Contractor to also include hand lift hardware. Contractor to consult owner for window finish.
- 8. Heating contractor shall provide a complete system that meets energy star requirments and NYS State Codes.
- Electrical contractor shall provide a complete system as per plans that meets energy star requirments and NYS State Codes.
 See spec and electrical allowance plans.
- 10. Plumbing contractor shall provide a complete system and connect to existing system.
- 11. See specifications for additional notes \$ information
- 12. Energy Code Compliane shall be by REScheck submission.

I Herby state to the best of my professional knowledge and abilities that the proposed building design represented in these documents is consistent with the building plans, specifications, and other calculations significated with the permit approach building has been designed to meet the requirements of the Current New York State Energy. Consensation Construction Code and adopted stretch code. The signature and seal on such documents attests to the above statement.

KARL ACKERMANN, AIA

NYS ENERGY CODE AND STETCH ADOPTED CODE COMPLIANCE - SEE RES CHECK FOR COMPLIANCE REPORT - climate zone 5

EXTERIOR WALL ROOF/CEILING FOUNDATION WALL R-15/19 SLAB EDGE INSULATION R-10/41-0" down GLAZING SKYLIGHTS EXTERIOR DOORS J-.27 Energy Star Compliant U-.27 Energy Star Compliant

HVAC EQUIPMENT: SHALL BE DESIGNED AND SPECIFIED BY H.V.A.C. CONTRACTOR AND MEET NYS BUILDING CODES AND STRETCH CODE

i Herby state to the best of my professional knowledge and abilities that the proposed building design represented in these documents is consistent with the building plans, specifications, and other calculations submitted with the permit application. The proposed building has been designed to meet the requirements of the Current New York State Energy Conservation Construction Code and adopted stretch code. The signature and seal on such documents attests to the

KARL ACKERMANN, AIA

Architect PLLC Architect

AA


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Residence For Mr. Dalton Bluehill Construction, Inc.

ssue Date: 2/15/22 Permit - 2/15/22 Permit - 3/3/22 Revised FAR


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Sheet No.

A-3

6' FENCE FACING EAST & NORTH (8) Thuja plicata 'Green Giant' 7-8' (9) Hydrangea paniculata `Limelight` 5 Gal (2) Picea abies 8-10 4' FENCE ON STREET SIDE LAWN 6' FENCE FACING EAST & NORTH (21) Buxus microphylla 'Winter Gem' 24-30" (1) Buxus sempervirens 30-36" GRAVEL APPROX LOCATION OF HVAC (5) Hydrangea paniculata 'Little Lime' 5 Gal (10) Buxus microphylla 'Winter Gem' 24-30' GATE (10) Prunus laurocerasus 'Schipkaensis' 5-6' LAWN (1) Quercus alba

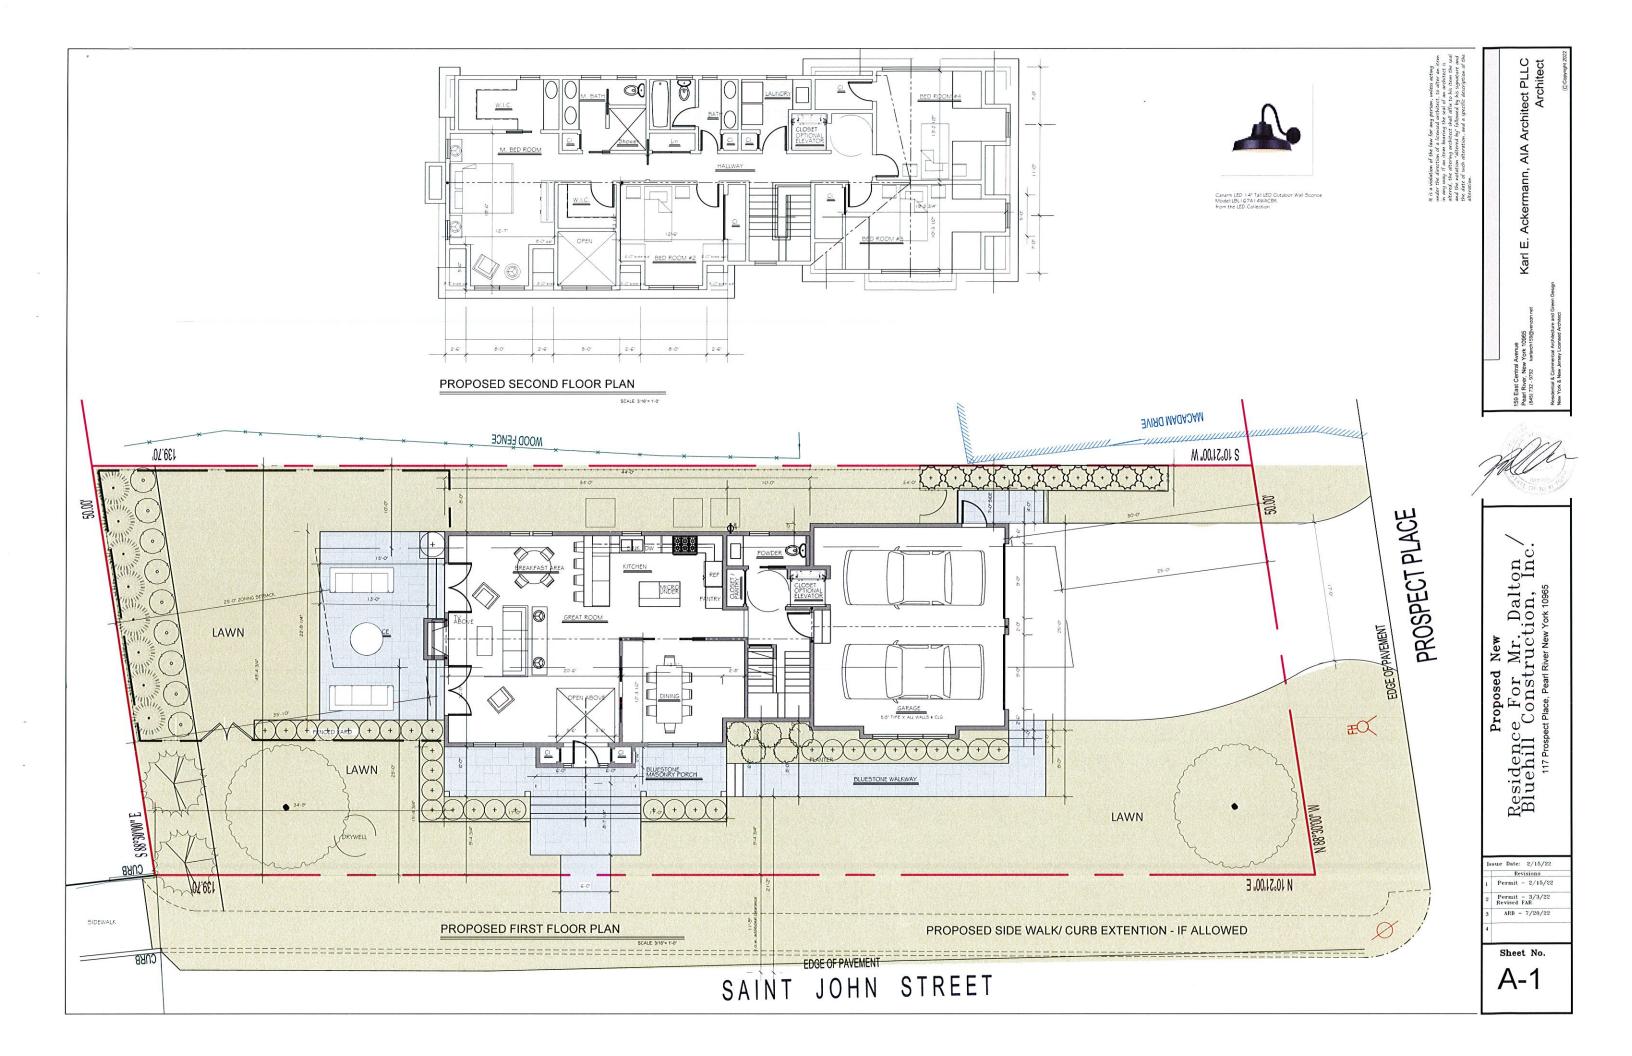□ PLANT SCHEDULE

	TREES	QTY	BOTANICAL NAME	COMMON NAME	SIZE
_		2	Picea abies	Norway Spruce	8-10
$(\cdot$)"	2	Quercus alba	White Oak	4" Cal.
_	William .	8	Thuja plicata 'Green Giant'	Western Red Cedar	7-8
	SHRUBS	QTY	BOTANICAL NAME	COMMON NAME	SIZE
	\odot	31	Buxus microphylla 'Winter Gem'	Globe Winter Gem Boxwood	24-30"
	\odot	1	Buxus sempervirens	American Boxwood	30-36"
	\odot	9	Hydrangea paniculata 'Limelight'	Limelight Hydrangea	5 Gal
	\odot	5	Hydrangea paniculata 'Little Lime'	Little Lime Hydrangea	5 Gal
	\odot	10	Prunus laurocerasus 'Schipkaensis'	Schipka English Laurel	5-6`

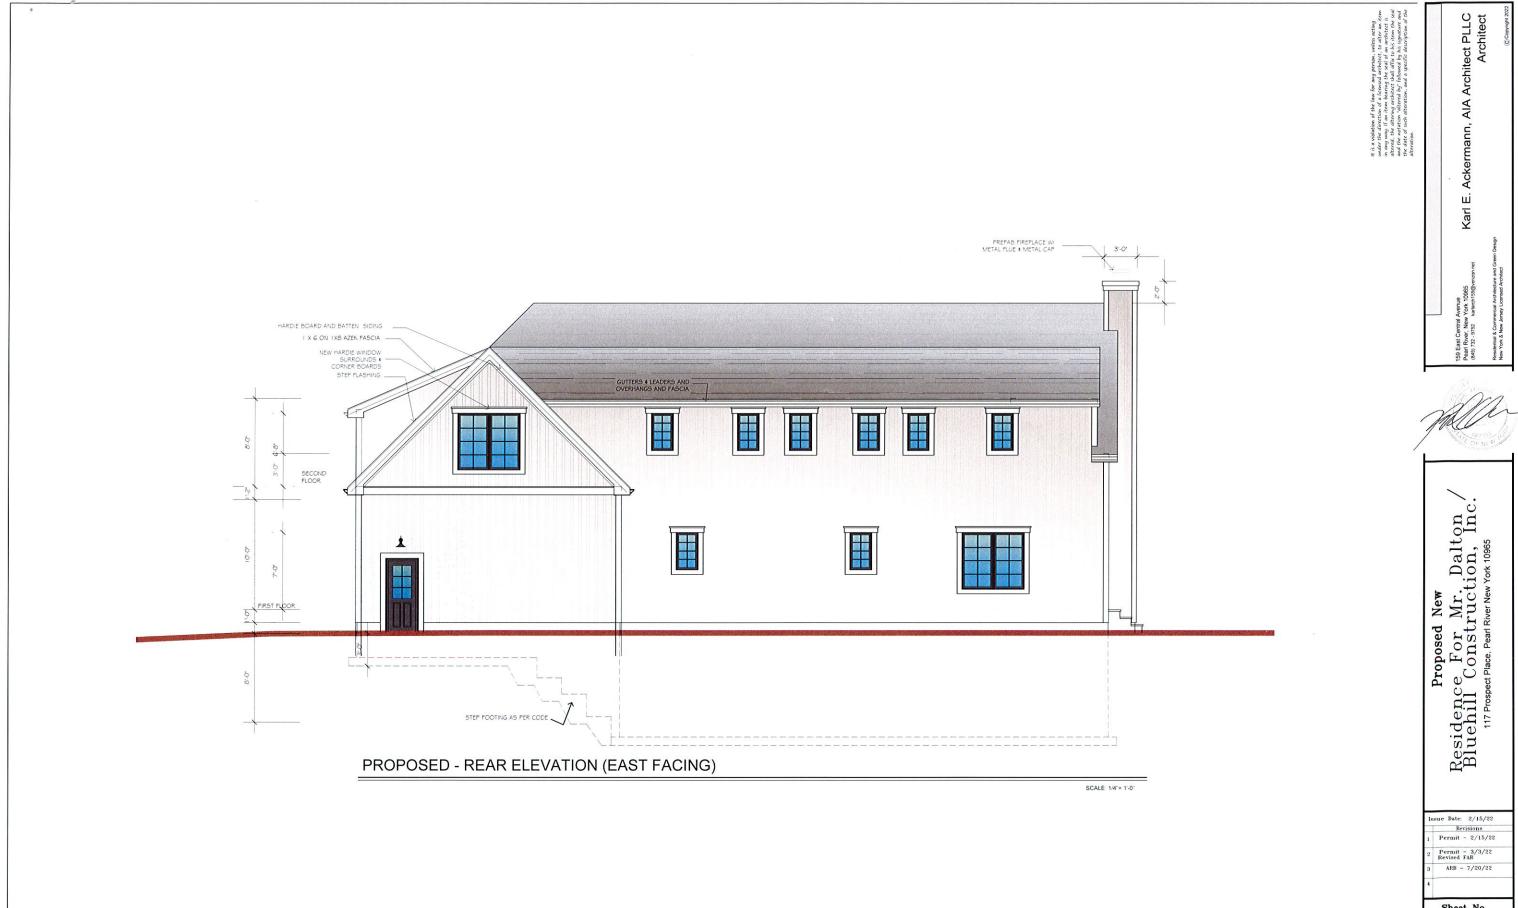PLANTING IMAGES















PLANTING NOTES

1. PLANT MATERIAL SHALL BE FURNISHED AND INSTALLED AS INDICATED; INCLUDING ALL LABOR, MATERIALS, PLANTS, EQUIPMENT, INCIDENTALS, AND CLEAN-UP.

Picea abies

- 2. THE CONTRACTOR SHALL BE RESPONSIBLE FOR PLANTING AT CORRECT GRADES AND ALIGNMENT. LAYOUT TO BE APPROVED BY LA PRIOR TO INSTALLATION.
- 3. PLANTS SHALL BE TYPICAL OF THEIR SPECIES AND VARIETY; HAVE NORMAL GROWTH HABITS; WELL DEVELOPED BRANCHES, DENSELY FOLIATED, VIGOROUS ROOT SYSTEMS AND BE FREE FROM DEFECTS AND INJURIES.
- 4. CONTRACTOR SHALL REPORT ANY SOIL OR DRAINAGE CONDITIONS CONSIDERED DETRIMENTAL TO THE GROWTH OF PLANT MATERIAL
- 5. ALL PLANT MATERIAL SHALL BE GUARANTEED BY THE CONTRACTOR TO BE IN VIGOROUS GROWING CONDITION. PROVISIONS SHALL BE MADE FOR A GROWTH GUARANTEE OF AT LEAST ONE YEAR FROM THE DATE OF ACCEPTANCE FOR TREES AND SHRUBS. REPLACEMENTS SHALL BE MADE AT THE BEGINNING OF THE FIRST SUCCEEDING PLANTING SEASON. ALL REPLACEMENTS SHALL HAVE. A GUARANTEE ACQUAL TO THAT STATED ABOVE.
- 6. INSOFAR AS IT IS PRACTICABLE, PLANT MATERIAL SHALL BE PLANTED ON THE DAY OF DELIVERY. IN THE EVENT THIS IS NOT POSSIBLE, THE CONTRACTOR SHALL PROTECT, IRRIGATE & CARE FOR STOCK NOT PLANTED.
- 7. QUALITY AND SIZE OF PLANTS, SPREAD OF ROOTS, AND SIZE OF BALLS SHALL BE IN ACCORDANCE WITH ANSI 260 (REV. 1980) "AMERICAN STANDARD FOR NURSERY STOCK" AS PUBLISHED BY THE AMERICAN ASSOCIATION OF NURSERYMEN, INC.
- 8. ALL PLANTS SHALL BE PLANTED IN AMENDED TOP SOIL THAT IS THOROUGHLY WATERED AND TAMPED AS BACK FILLING PROGRESSES. PLANTING MIX TO BE AS SHOWN ON PLANTING DETAILS. LARGE PLANTING AREAS TO INCORPORATE FERTILIZER AND SOIL CONDITIONERS AS STATED IN PLANTING SPECIFICATIONS.
- 9. PLANTS SHALL NOT BE BOUND WITH WIRE OR ROPE AT ANY TIME SO AS TO DAMAGE THE BARK OR BREAK BRANCHES. PLANTS SHALL BE HANDLED FROM THE BOTTOM OF THE BALL ONLY.
- 10. PLANTING OPERATIONS SHALL BE PERFORMED DURING PERIODS WITHIN THE PLANTING SEASON WHEN WEATHER AND SOIL CONDITIONS ARE SUITABLE AND IN ACCORDANCE WITH ACCEPTED LOCAL PRACTICE: PLANTS SHALL NOT BE INSTALLED IN TOPSOIL THAT IS IN A MUDDY OR FROZEN CONDITION.
- 11. NO PLANT, EXCEPT GROUND COVERS, SHALL BE PLANTED LESS THAN TWO FEET FROM EXISTING STRUCTURES AND SIDEWALKS.
- 12. SET ALL PLANTS PLUMB AND STRAIGHT. SET AT SUCH LEVEL THAT A NORMAL OR NATURAL RELATIONSHIP TO THE CROWN OF THE PLANT WITH THE GROUND SURFACE WILL BE ESTABLISHED. LOCATE PLANT IN THE CENTER OF THE PIT.
- 13. ALL INJURED ROOTS SHALL BE PRUNED UTILIZING CLEAN, SHARP TOOLS TO MAKE CLEAN ENDS BEFORE PLANTING.
- 14. EACH TREE AND SHRUB SHALL BE PRUNED IN ACCORDANCE WITH STANDARD HORTICULTURAL PRACTICE TO PRESERVE NATURAL CHARACTER OF PLANT. PRUNING SHALL BE DONE WITH CLEAN, SHARP TOOLS.
- 16. ALL PLANTING BEDS SHALL BE MULCHED WITH 2" LAYER OF DOUBLE SHREDDED HARDWOOD BARK MULCH
- 17. ALL DISTURBED AREAS TO BE TREATED WITH 3" TOP SOIL & SEEDED IN ACCORDANCE WITH PERMANENT STABILIZATION METHODS.

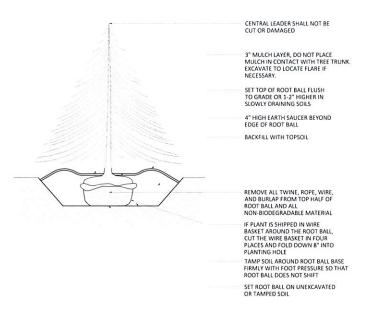

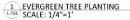



SHRUB, AS SPECIFIED


2" DEEP ORGANIC MULCH RING SET PLANT PLUMB IN **EXCAVATED HOLE**

1. FOR B & B PLANT MATERIAL, REMOVE ALL TWINE AND ROLL BACK BURLAP FROM TOP 1/2 OF BALL. IF ANY MATERIALS USED TO BIND THE ROOTBALL ARE NON-BIODEGRADEABLE, REMOVE COMPLETELY INCLUDING WIRE BASKET. 2. FOR CONTAINER GROWN PLANT MATERIAL, REMOVE CONTAINER. TO HELP PREVENT LOOSENING OF SOIL AND SCARIFY BALL TO HELP PREVENT GIRDLING ROOTS.

3. SATURATE SOIL WITHIN SIX (6) HOURS OF PLANTING, AND WATER AS NECESSARY UNTIL IRRIGATION INSTALLED.

NO MULCH OR SOIL SHOULD BE PLACED AGAINST THE PLANT'S TRUNK.

2 SHRUB PLANTING L-701 SCALE: 1/2"=1'

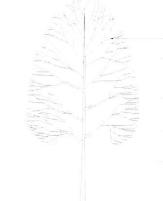


TREE AS SPECIFIED

TRUNK FLARE SHALL BE 1-2" ABOVE GRADE. EXCAVATE TO LOCATE FLARE IF NECESSARY.

18" DIAMETER ORGANIC MULCH RING, 2" DEPTH

REMOVE TWINE FROM TRUNK AND FOLD DOWN BURLAP TO EXPOSE TOP 1/3 OF ROOTBALL

BACKFILL WITH EXCAVATED SOIL

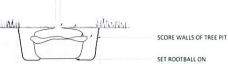

3 DECIDUOUS TREE PLANTING L-701 SCALE: 1/4"=1'

EXCAVATE 2X DIAMETER OF ROOTBALL



YOST

pearl river, ny 10965 p 845.365.4595 | f 914.361.4473 yostdesign.com

4

PROSPEC⁻

 \vdash

DATE: APRIL 22,2022

DRAWN BY: AVM JOB NO: 042222

SCALE: 1"=10'

RIVER, NY, 10965 CITY, STATE, ZIP

1. SET TREE PLUMB.

NOTES:

2. DO NOT STAKE UNLESS DIRECTED TO DO SO BY LANDSCAPE ARCHITECT

3. REMOVE COMPLETELY ANY NON-BIODEGRADABLE MATERIALS BINDING THE ROOTBALL.

4. REMOVE WIRE BASKET COMPLETELY IF ROOTBALL WILL BARE. OTHERWISE, CLIP AND PEEL BACK WIRE BASKET AT LEAST ONE THIRD OF THE WAY FROM THE TOP OF THE ROOTBALL.

5. SATURATE SOIL WITHIN SIX (6) HOURS OF PLANTING AND WATER AS NECESSARY UNTIL IRRIGATION IS INSTALLED.

6. DO NOT ADD ANY SOIL AMENDMENTS OTHER THAN COMPOST UNLESS DIRECTED TO BY LANDSCAPE ARCHITECT.

7. DO NOT ADD ANY SOIL OR MULCH AGAINST TRUNK OF TREE. IF ROOT FLARE IS NOT EXPOSED, REMOVE SOIL AND EXPOSE.

TO SCALE WHEN PLOTTED ON 24x36

PROGRESS SET NOT FOR CONSTRUCTION

PLANTING

SHEET NO.

L-701

PLAN