
# SUEZ WATER NEW YORK WEST NYACK, NEW YORK

# PFAS COMPLIANCE FOR GROUNDWATER WELLS PROJECT B

CONTRACT NO. 15806

PLANNING BOARD SUBMITTAL

MAY 2022

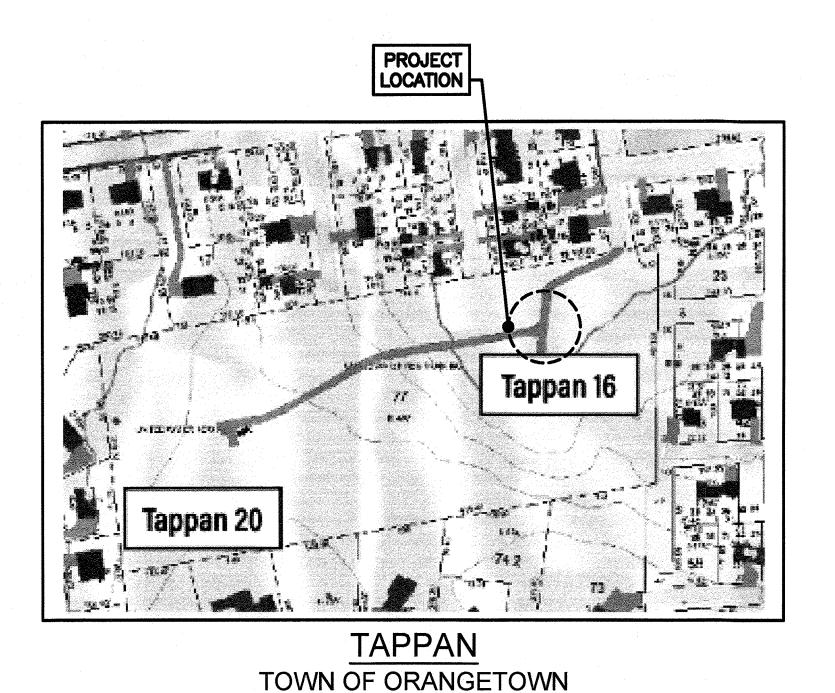

LOCATION MAPS

NOT TO SCALE







CAMP DRESSER McKEE & SMITH - LATHAM, NEW YORK

Water

Environment Tra

Transportation

Energy

IT IS A VIOLATION OF SECTION 7209, SUB-DIVISION 2

OF THE NEW YORK STATE EDUCATION LAW FOR ANY PERSON UNLESS ACTING UNDER THE DIRECTION OF A LICENSED PROFESSIONAL ENGINEER OR LAND SURVEYOF TO ALTER IN ANY WAY PLANS, SPECIFICATIONS, PLATES OR REPORTS TO WHICH THE SEAL OF A PROFESSIONAL ENGINEER OR SURVEYOR HAS BEEN ATTACHED.

Facilities

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**GENERAL COVER SHEET -**TAPPAN INDEX OF DRAWINGS G - 001 PROCESS FLOW DIAGRAM - TAPPAN I PROCESS FLOW DIAGRAM - TAPPAN II CIVIL CIVIL GENERAL NOTES, ABBREVIATIONS, LEGEND AND SYMBOLS CIVIL EXISTING CONDITIONS/BORING PLAN - TAPPAN CIVIL SITE CLEARING, DEMOLITION AND STAGING - TAPPAN C - 202 CIVIL SEDIMENTATION AND EROSION CONTROLS PLAN - TAPPAN CIVIL GRADING AND DRAINAGE PLAN - TAPPAN C - 204 CIVIL SITE IMPROVEMENT PLAN - TAPPAN CIVIL YARD PIPING PLAN - TAPPAN CIVIL PIPING PROFILES - TAPPAN CIVIL MISCELLANEOUS SITE DETAILS I CIVIL MISCELLANEOUS SITE DETAILS II CIVIL MISCELLANEOUS SITE DETAILS III CIVIL SEDIMENTATION AND EROSION DETAILS CIVIL PLANTINGS DETAILS I CIVIL PLANTINGS DETAILS II

# <u>ARCHITECTURAL</u>

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A - 001 ARCHITECTURAL GENERAL NOTES, ABBREVIATIONS AND SYMBOLS

ARCHITECTURAL CODE COMPLIANCE AND EGRESS PLAN - TAPPAN A - 201 ARCHITECTURAL GROUND AND ROOF LEVEL PLANS - TAPPAN A - 202


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W



R. GENCOREL G. STUART C. MEEHAN G. STUART MAY 2022 DATE DRWN CHKD REMARKS




SUEZ WATER NEW YORK WEST NYACK, NY PFAS COMPLIANCE FOR **GROUNDWATER WELLS PROJECT B** CONTRACT NO. 15806

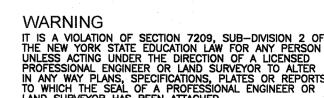INDEX OF DRAWINGS

PROJECT NO. 250917-25706 FILE NAME: GOO1INDX.DW SHEET NO.

G-1

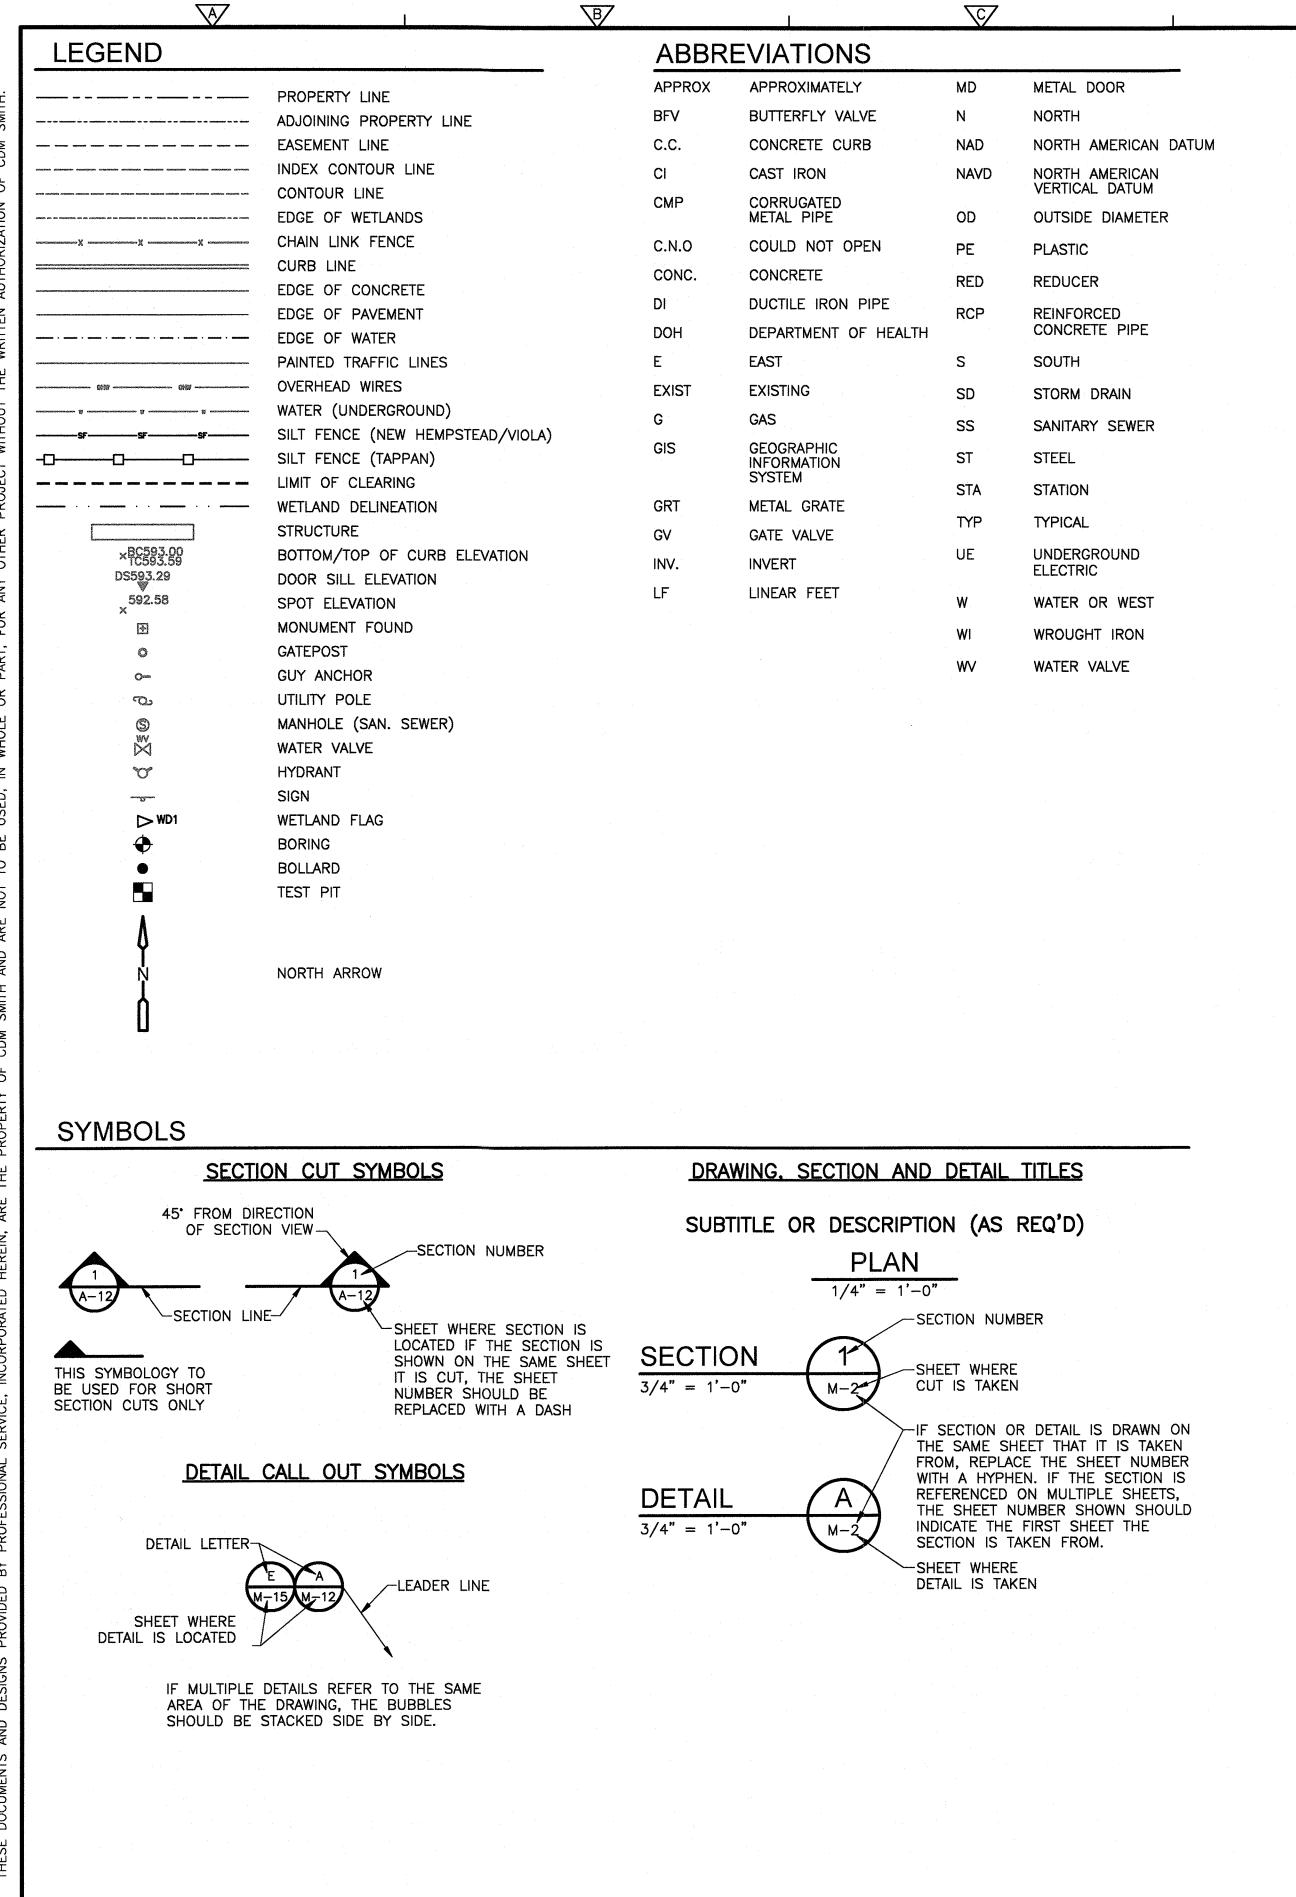

#### GENERAL NOTES

THE FIELD.

- BASE MAPPING IS BASED ON A FIELD SURVEY COMPLETED BY TECTONIC ENGINEERING CONSULTANTS, GEOLOGISTS & LAND SURVEYORS, D.P.C. COMPLETED ON 3/11/2021 AND 4/01/2021. THE HORIZONTAL DATUM IS NEW YORK STATE PLANE NAD83, NEW YORK EAST ZONE. THE VERTICAL DATUM IS NAVD88.
- 2. CONTRACTOR SHALL SUBMIT A CONSTRUCTION SCHEDULE WITH PROPOSED WORKING HOURS TO THE OWNER'S FIELD REPRESENTATIVE FOR REVIEW AND APPROVAL PRIOR TO ANY CONSTRUCTION AT THE SITE. THE FIELD REPRESENTATIVE SHALL COORDINATE SCHEDULE WITH APPLICABLE REGULATORY AGENCIES AND STAKEHOLDERS.
- 3. CONTRACTOR SHALL BE RESPONSIBLE FOR COORDINATING ALL WORK, LANE CLOSURES AND DISRUPTIONS WITH GOVERNING AGENCIES. THE CONTRACTOR IS RESPONSIBLE FOR SUBMITTING A TRAFFIC CONTROL PLAN TO THE MUNICIPALITIES PRIOR TO STARTING WORK. PROPER TRAFFIC CONTROL MUST BE MAINTAINED THROUGHOUT THE PROJECT DURATION.
- 4. THE CONTRACTOR SHALL BE RESPONSIBLE FOR OBTAINING SECURING AND REHABILITATING TEMPORARY STAGING, STORAGE AND/OR STOCKPILING AREAS, IF NEEDED, DURING CONSTRUCTION.
- 5. THE CONTRACTOR SHALL NOTIFY THE ENGINEER, SUEZ WATER, AND ALL UTILITIES PRIOR TO STARTING WORK.
- 6. REGULAR WORKING HOURS FOR THIS PROJECT ARE DEFINED AS MONDAY THROUGH FRIDAY BETWEEN THE HOURS OF 7:00 AM AND 5:00 PM UNLESS OTHERWISE STIPULATED BY THE ROAD OWNER.
- 7. FOR ALL WORK NEAR UNDERGROUND UTILITIES, THE CONTRACTOR SHALL FOLLOW PROPER NOTIFICATION PROCEDURES INCLUDING CONTACTING THE STATE "ONE CALL" SYSTEM (DIG SAFE NY) BY CALLING 1-800-962-7962.
- 8. DIG EXPLORATORY TEST PITS AS REQUIRED TO DETERMINE UNDERGROUND CONDITIONS. FIELD ENGINEER AND OWNER SHALL APPROVE OF TEST PITS PRIOR TO EXCAVATION.
- 9. THE LOCATION AND FULL EXTENT OF TRAFFIC SIGNAL LOOPS, CONDUIT, AND WIRING MAY NOT BE SHOWN. THE CONTRACTOR SHALL COORDINATE THE MARK—OUT OF SIGNAL LOOPS AND WIRING WITH THE GOVERNING AGENCY. LOOPS AND WIRING DAMAGES DURING CONSTRUCTION SHALL BE REPAIRED OR REPLACED TO THE SATISFACTION OF THE GOVERNING AGENCY AT NO ADDITIONAL COST TO SUEZ WATER.
- 10. ALL SERVICE LOCATIONS ARE INTENDED TO SHOW THE PRESENCE OF A SERVICE AND DO NOT REPRESENT THE EXACT LOCATIONS. EXACT LOCATIONS AND SIZES OF SERVICES TO BE VERIFIED IN THE FIELD.
- 11. THE CONTRACTOR SHALL SUPPORT EXISTING UTILITIES DURING CONSTRUCTION TO THE SATISFACTION OF THE ENGINEER AND THE RESPECTIVE UTILITY.
- 12. SILT FENCES SHALL BE INSTALLED PRIOR TO CLEARING AND TRENCHING WHERE SPECIFIED IN SECTION 01110 AND AS DIRECTED BY THE OWNER'S REPRESENTATIVE.
- 13. BOX ALL TREES AND HOUSE ALL SHRUBS AND HEDGES BEFORE PLACING EARTH AGAINST OR NEAR THEM.
- 14. ALL TEMPORARY CONCRETE BARRIERS SHALL CONFORM TO NYSDOT M606-21.
- 15. ALL PIPE SHALL BE CLASS 52 CEMENT/MORTAR LINED DUCTILE IRON PIPE CONFORMING TO AWWA STANDARD C151 UNLESS OTHERWISE NOTED ON THE DRAWINGS.
- 16. CONTRACTOR SHALL CONTACT THE ENGINEER'S OFFICE IMMEDIATELY ON ANY CONFLICTS ARISING DURING CONSTRUCTION OF ANY IMPROVEMENTS SHOWN ON THESE DRAWINGS.
- 17. THE CONTRACTOR SHALL NOTIFY SUEZ WATER PRIOR TO CONNECTION TO OR RELOCATION OF ANY EXISTING SUEZ WATER—OWNED AND MAINTAINED FACILITIES. ALL CONNECTIONS AND MODIFICATIONS TO EXISTING FACILITIES SHALL BE DONE AT THE CONVENIENCE OF SUEZ WATER.
- 18. THE DRAWINGS INDICATE THE PRESENCE OF BENDS AS PART OF THE NEW INSTALLATION. BENDS ARE SHOWN TO INDICATE THE FACT THAT THE INSTALLATION WILL INCLUDE BENDS, BUT NOT TO INDICATE THE EXACT PLACEMENT OF BENDS. PRECISE LOCATION OF BENDS TO BE DETERMINED IN
- 19. SANITARY SEWER MAINS AND CROSSINGS TO BE FIELD VERIFIED BY CONTRACTOR. THE CONTRACTOR IS CAUTIONED THAT ALL SANITARY LATERALS AND UTILITY SERVICES HAVE NOT BEEN LOCATED, WHEN THE CONTRACTOR ENCOUNTERS AN OBSTRUCTION AND CANNOT ADJUST THE ALIGNMENT USING ALLOWABLE JOINT DEFLECTION, THE CONTRACTOR SHALL INSTALL FITTINGS PROVIDED BY SUEZ WATER AT NO ADDITIONAL COST. THE CONTRACTOR SHALL BE RESPONSIBLE FOR THE PROMPT REPAIR OF DAMAGED UTILITIES AND SHALL MAINTAIN ON SITE AN ADEQUATE SUPPLY OF REPAIR MATERIALS.
- 20. CONTRACTOR SHALL MAINTAIN A VERTICAL MINIMUM CLEARANCE OF 18—INCHES BETWEEN THE NEW WATER MAIN AND ALL OTHER EXISTING UTILITIES WHEN POSSIBLE. NEW WATER MAINS SHALL PASS UNDER ALL EXISTING UTILITIES EXCEPT SANITARY SEWERS UNLESS OTHERWISE SHOWN OR DIRECTED BY THE ONWER'S REPRESENTATIVE.
- 21. WATER MAINS CROSSING SEWERS SHALL BE LAID TO PROVIDE A MINIMUM VERTICAL DISTANCE OF 18 INCHES BETWEEN THE OUTSIDE OF THE WATER MAIN AND THE OUTSIDE OF THE SEWER. THIS SHALL BE THE CASE WHERE THE WATER MAIN IS EITHER ABOVE OR BELOW THE SEWER, WITH PREFERENCE TO THE WATER MAIN LOCATED ABOVE THE SEWER. AT CROSSINGS, ONE FULL LENGTH OF WATER PIPE SHALL BE LOCATED SO BOTH JOINTS WILL BE AS FAR FROM THE SEWER AS POSSIBLE. SPECIAL STRUCTURAL SUPPORT FOR THE WATER AND SEWER PIPES MAY BE REQUIRED.
- 22. CONTRACTOR SHALL ENCASE NEW WATER MAIN IN K-CRETE WHEN PIPE IS WITHIN 10 FEET OF SANITARY OR STORM SEWER HORIZONTALLY OR CROSSES WITHIN 18 INCHES VERTICALLY.
- 23. THE CONTRACTOR SHALL BE AWARE THAT THE MAINS AND VALVES TO BE SHUT DOWN ARE OLD. AS SUCH, A WATERTIGHT SHUTDOWN CANNOT BE GUARANTEED. THE CONTRACTOR SHALL BE PREPARED TO UNDERTAKE MAIN ABANDONMENT OPERATIONS AND CONNECTIONS TO THE EXISTING MAINS IN WET CONDITIONS. THE CONTRACTOR SHALL HAVE NO CLAIM FOR ADDITIONAL COMPENSATION IF EXISTING VALVES LEAK. THE CONTRACTOR SHALL PROVIDE THE NECESSARY PUMPING AND DEWATERING EQUIPMENT AT NO ADDITIONAL COST TO THE OWNER.
- 24. ALL NEW WATER MAINS AND SERVICES SHALL HAVE A MINIMUM OF 4 FEET OF COVER, UNLESS OTHERWISE NOTED ON THE PLAN SHEETS OR DIRECTED BY THE OWNER'S REPRSENTATIVE.
- 25. THRUST BLOCKS SHALL BE INSTALLED ON ALL FITTINGS. PIPE JOINTS SHOWN TO BE RESTRAINED SHALL HAVE FIELD LOK GASKETS.
- 26. DURING EXCAVATIONS, THE CONTRACTOR SHALL, AS A MINIMUM, COMPLY WITH THE EXCAVATION SAFETY STANDARDS, PROVIDE SPECIAL SHORING (IF REQUIRED), AND PROVIDE COMPLIANCE WITH THE OCCUPATIONAL HEALTH AND SAFETY ADMINISTRATION (OSHA) EXCAVATION SAFETY STANDARD 29 CFR 1926/650 (SUBPART B AS AMENDED).

- 29. TRENCH EXCAVATIONS NEAR STREAMS AND DRAINAGE SWALES SHALL BE DEWATERED USING SILTATION BAGS OR APPROVED EQUAL. CONTRACTOR SHALL NOT PUMP UNFILTERED WATER INTO STREAMS OR INTO STRUCTURES WHICH DISCHARGE TO A WATER BODY.
- 30. IF ASBESTOS IS ENCOUNTERED, ONLY ASBESTOS—CERTIFIED CONTRACTORS ARE TO PERFORM SERVICE TAPS ON ASBESTOS CEMENT PIPE. CONTRACTOR TO RETAIN AC PIPE TAP COUPON FOR SUEZ WATER RECORD KEEPING PURPOSES.
- 31. CONTROL DENSITY BACKFILL SHALL BE PROVIDED WHEN EXISTING UTILITY LINES ARE UNDERMINED AND SELECTED BACKFILL CAN NOT BE PROPERLY PLACED.
- 32. NEW MAIN SHALL BE INSTALLED COMPLETE BY CONTRACTOR, THEN PRESSURE TESTED IN ACCORDANCE WITH THE LATEST EDITIONS OF AWWA STANDARD C600 AND DISINFECTED PRIOR TO TRANSFERRING SERVICE TO THE NEW MAINS BY SUEZ WATER.
- 33. THE CONTRACTOR SHALL INSTALL A 2" CORPORATION STOP, A SECTION OF 2" COPPER TO GRADE WITH A 2" CURB STOP OR 2" BALL VALVE WITH A SECTION OF 2" COPPER WITH A COUPLING NUT AND FLARED END FOR BLEEDING, FLUSHING, PRESSURE TESTING, DISINFECTING, AND DE-CHLORINATING THE WATER MAIN. THE CORPORATION STOP TESTING ASSEMBLY SHALL BE INSTALLED AT THE BEGINNING AND END OF A SEGMENT TO BE TESTED AND DISINFECTED AND SHALL NOT EXCEED A MAXIMUM LENGTH OF 1,200 FEET AND THE CONTRACTOR SHALL INSTALL ADDITIONAL CORPORATION STOPS AS ARE REQUIRED FOR PROPER TESTING, FLUSHING, AIR BLEEDING, AND DISINFECTION.
- 34. DURING FLUSHING AND PRESSURE TESTING OF THE MAIN, THE CONTRACTOR SHALL NOT OPERATE VALVES WITHOUT THE DIRECT SUPERVISION OF SUEZ WATER, INCLUDING NEW VALVES INSTALLED.
- 35. AFTER THE MAIN HAS BEEN PLACED INTO SERVICE, THE CONTRACTOR SHALL REMOVE THE TESTING ASSEMBLY AND ABANDON THE CORPORATION STOP OR THE CURB STOP. THE CORPORATION STOP OR THE CURB STOP SHALL BE IN THE CLOSED POSITION AND THE END OF THE COPPER PIPE SHALL BE CRIMPED BELOW GRADE PRIOR TO BACKFILL AND PAVE IN ACCORDANCE WITH THE APPLICABLE TRENCH DETAIL.
- 36. REGARDLESS OF THE SOURCE OF POTABLE WATER, ALL WATER USED FOR TESTING AND DISINFECTING PURPOSES SHALL BE PROPERLY DISPOSED OF (INCLUDING DE-CHLORINATION) BY THE CONTRACTOR IN ACCORDANCE WITH ALL APPLICABLE FEDERAL, STATE, LOCAL AND SUEZ WATER STANDARDS.
- 37. THE CONTRACTOR SHALL BE FULLY RESPONSIBLE FOR ANY AND ALL DAMAGES WHICH HAVE OCCURRED BY HIS FAILURE TO EXACTLY LOCATE AND PRESERVE ANY AND ALL EXISTING UTILITIES, STRUCTURES AND OTHER FEATURES AFFECTING HIS WORK. ITEMS SHALL BE REPLACED WITH THE SAME TYPE OF MATERIAL THAT WAS REMOVED OR DAMAGED DURING CONSTRUCTION OR AS DIRECTED BY THE ENGINEER.
- 38. SHRUBS AND HEDGES WHICH MUST BE REMOVED DURING CONSTRUCTION SHALL BE REPLACED IN AS GOOD A CONDITION AS THEY WERE BEFORE THEIR REMOVAL. ANY DAMAGED TREES, SHRUBS, AND/OR HEDGES SHALL BE REPLACED AT THE CONTRACTOR'S EXPENSE.
- 39. IF CONTRACTOR UNNECESSARILY DAMAGES CURBS AND SIDEWALKS DUE TO NEGLIGENCE OR UNSUITABLE CONSTRUCTION TECHNIQUES, THE CONTRACTOR SHALL RESTORE THOSE ITEMS IN KIND AT NO ADDITIONAL COST TO THE OWNER.
- 40. CONTRACTOR SHALL RESTORE LAWNS, DRIVEWAYS, WALLS, WALKS, CURBS, FENCES, ETC. TO A CONDITION AT LEAST AS GOOD AS THEY WERE BEFORE BEING DISTURBED. MAILBOXES, POSTS, ETC. SHALL BE PROTECTED OR REMOVED AND REPLACED EXACTLY AS THEY WERE BEFORE BEING DISTURBED. THE COST OF THIS WORK SHALL BE PAID FOR UNDER THE BID ITEM FOR MISCELLANEOUS WORK AND CLEANUP. ITEMS DAMAGED THROUGH CONTRACTOR NEGLIGENCE SHALL BE REPLACED AT THE CONTRACTOR'S EXPENSE.
- 41. THE CONTRACTOR SHALL BE RESPONSIBLE FOR REMOVAL AND DISPOSAL OF ALL EXCESS EXCAVATED MATERIAL TO AN APPROVED OFF—SITE LOCATION AT NO ADDITIONAL COST TO THE OWNER.
- 42. RESTORATION, INCLUDING THE REMOVAL OF EXCESS EXCAVATED MATERIAL AND PLACEMENT OF TEMPORARY PAVEMENT, SHALL BE PERFORMED AND COMPLETED ON A DAILY BASIS. ALL ROADS SHALL BE PASSABLE TO VEHICULAR TRAFFIC AT THE END OF EACH WORK DAY.
- 43. THE CONTRACTOR SHALL BE RESPONSIBLE FOR MAINTAINING RECORD DRAWINGS OF THE LOCATION AND ELEVATION OF ALL WORK INSTALLED. THESE SHALL BE PROVIDED TO SUEZ WATER.

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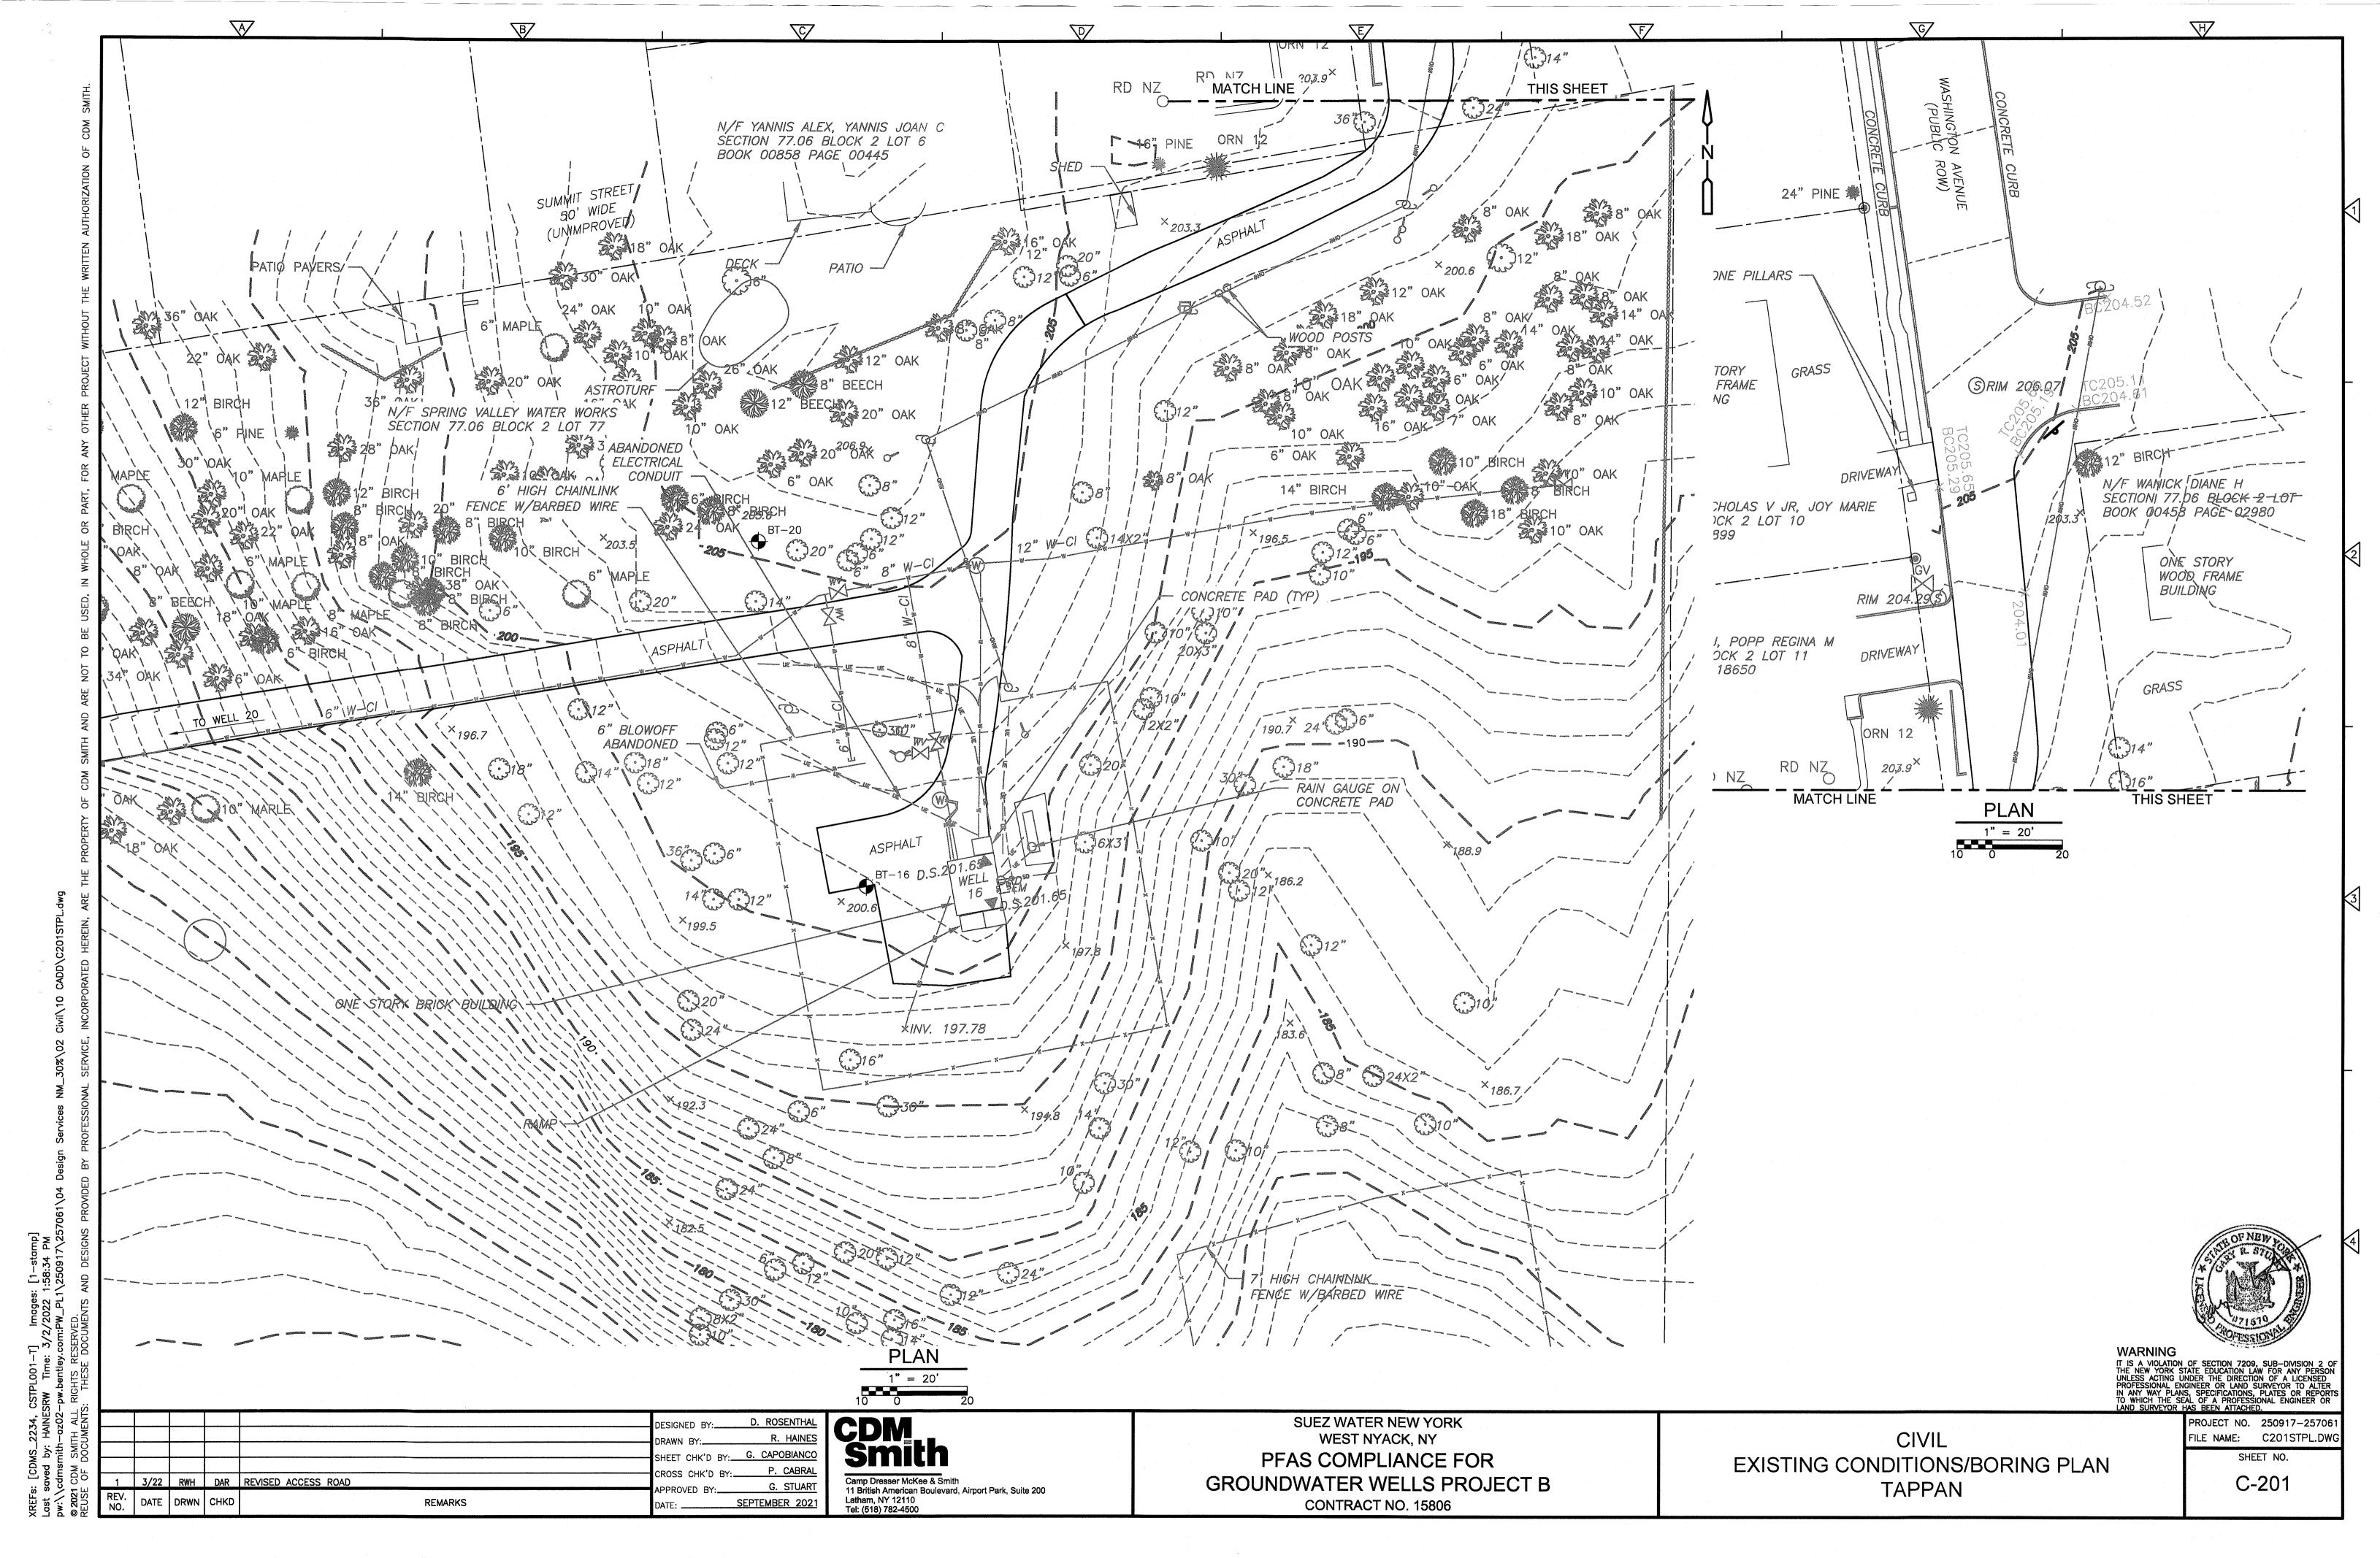
SUEZ WATER NEW YORK
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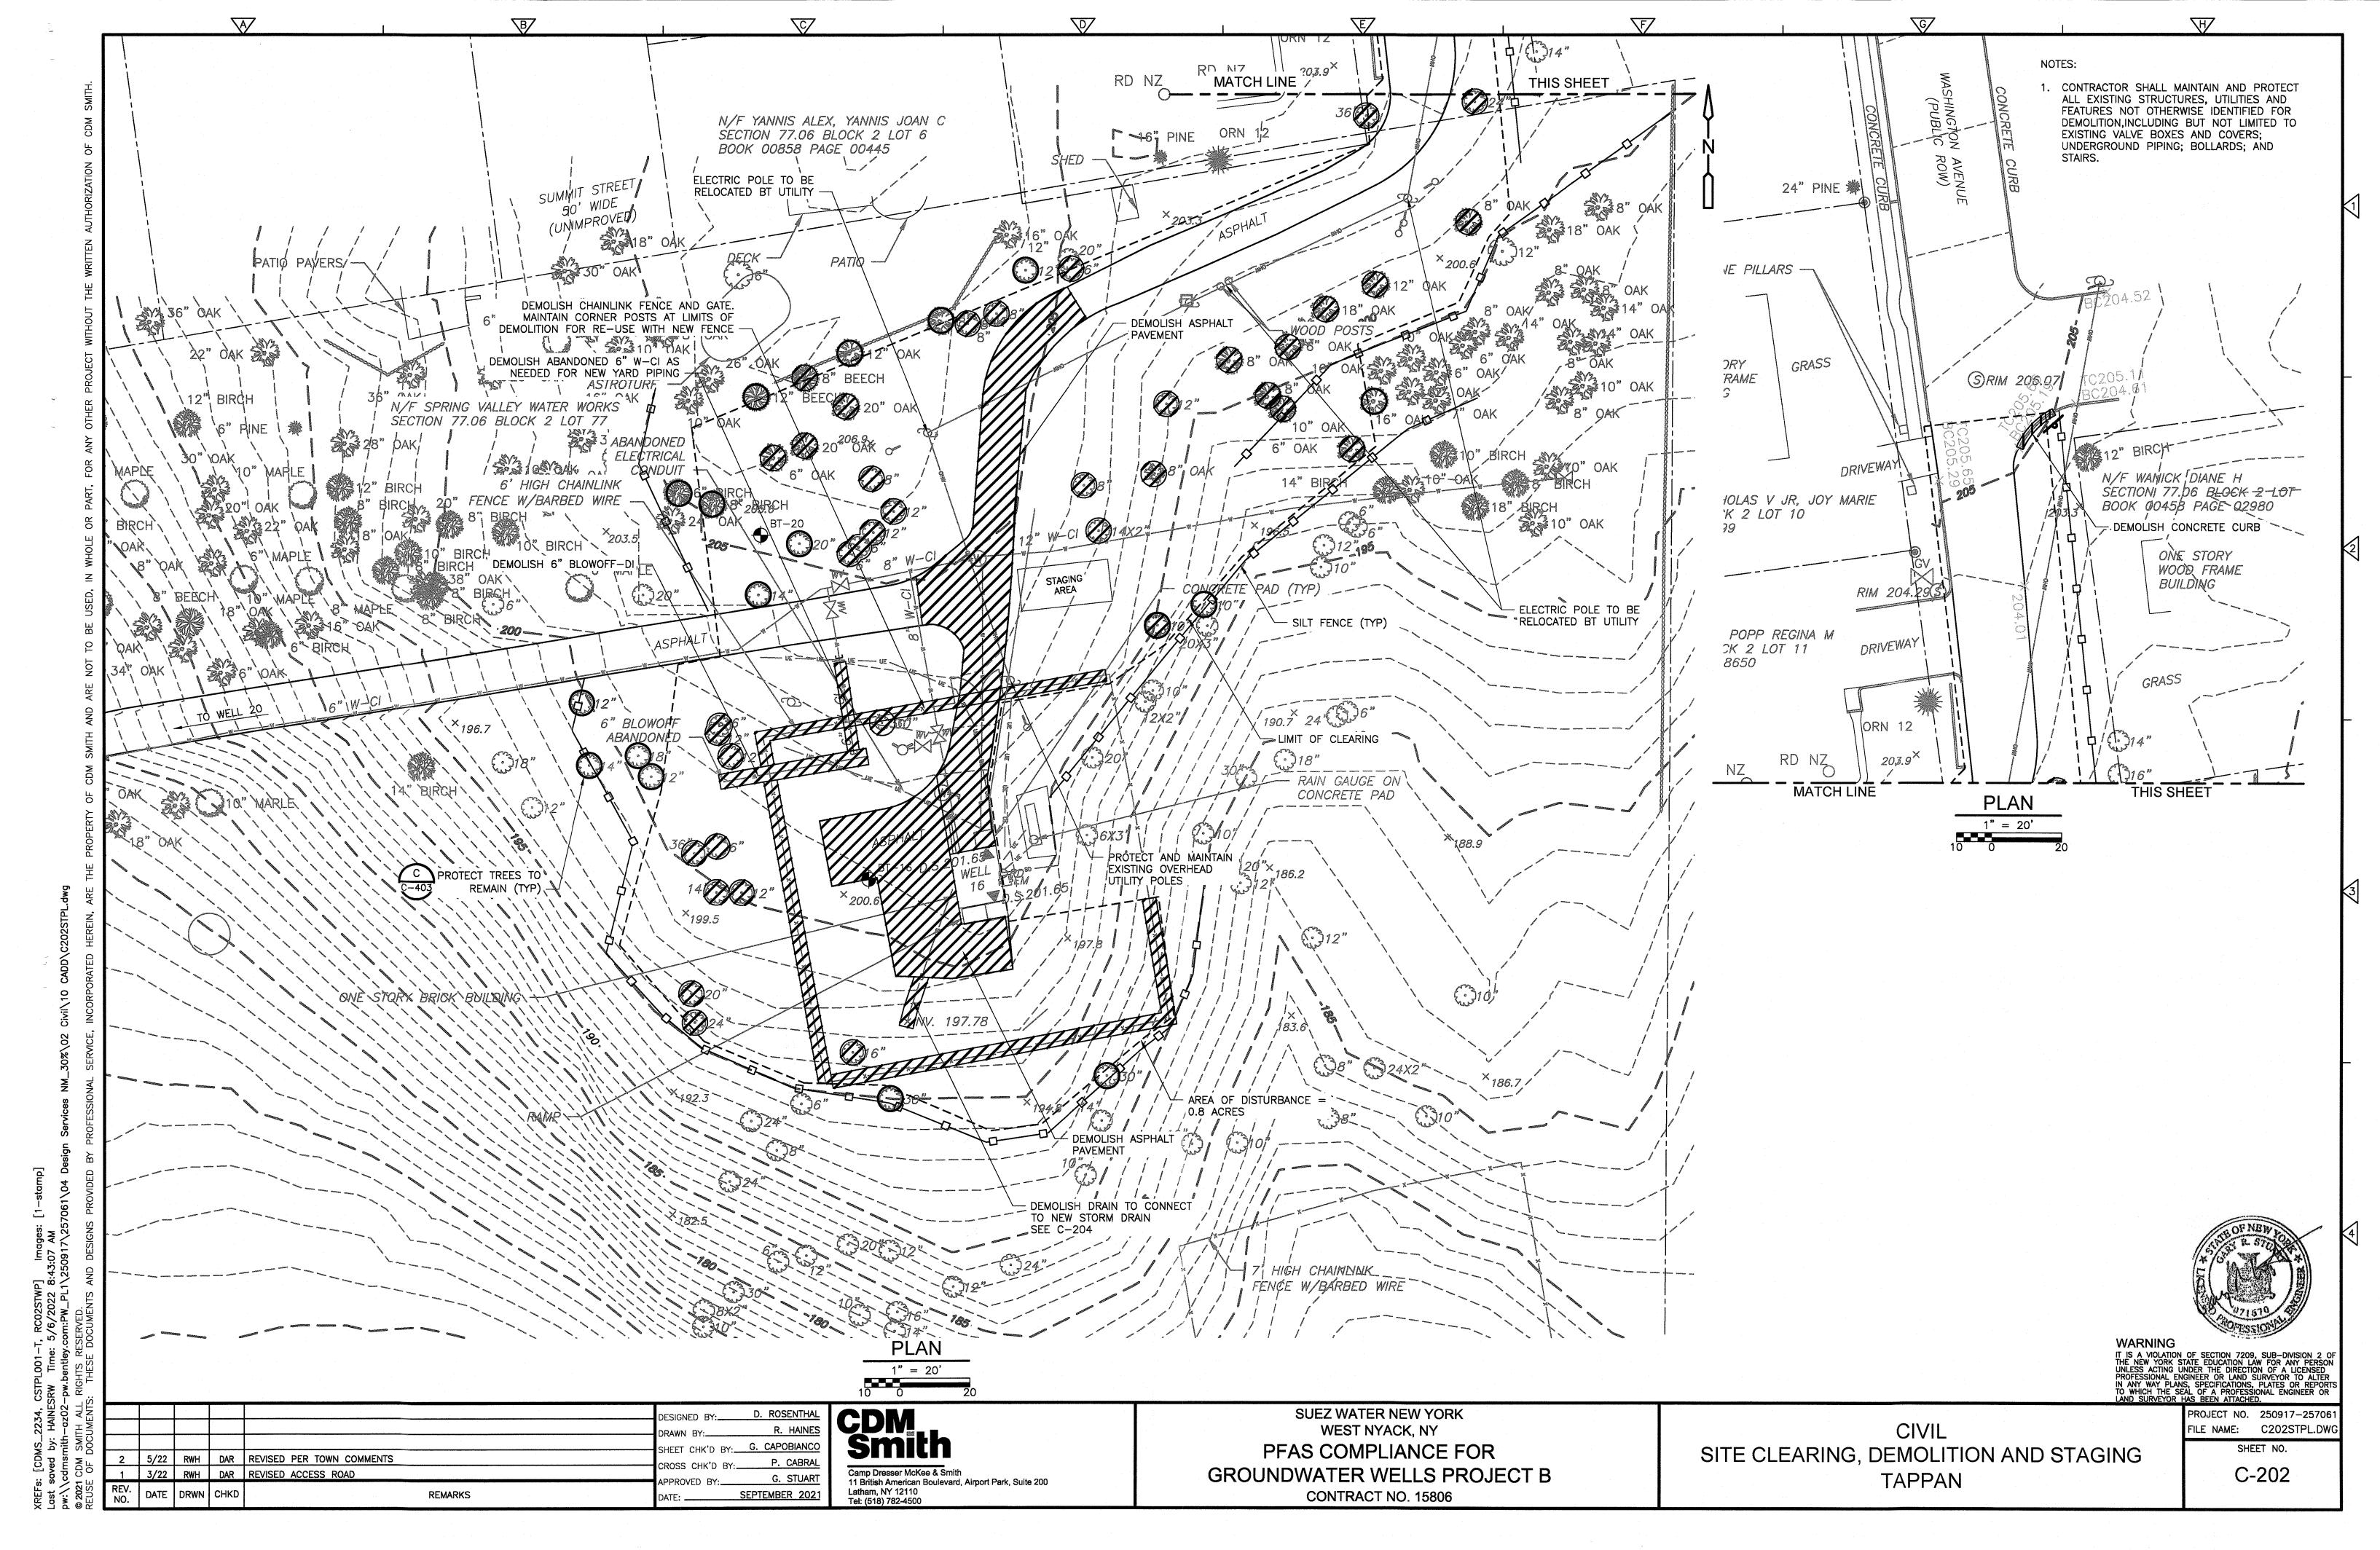
CIVIL
GENERAL NOTES, ABBREVIATIONS,
LEGEND AND SYMBOLS


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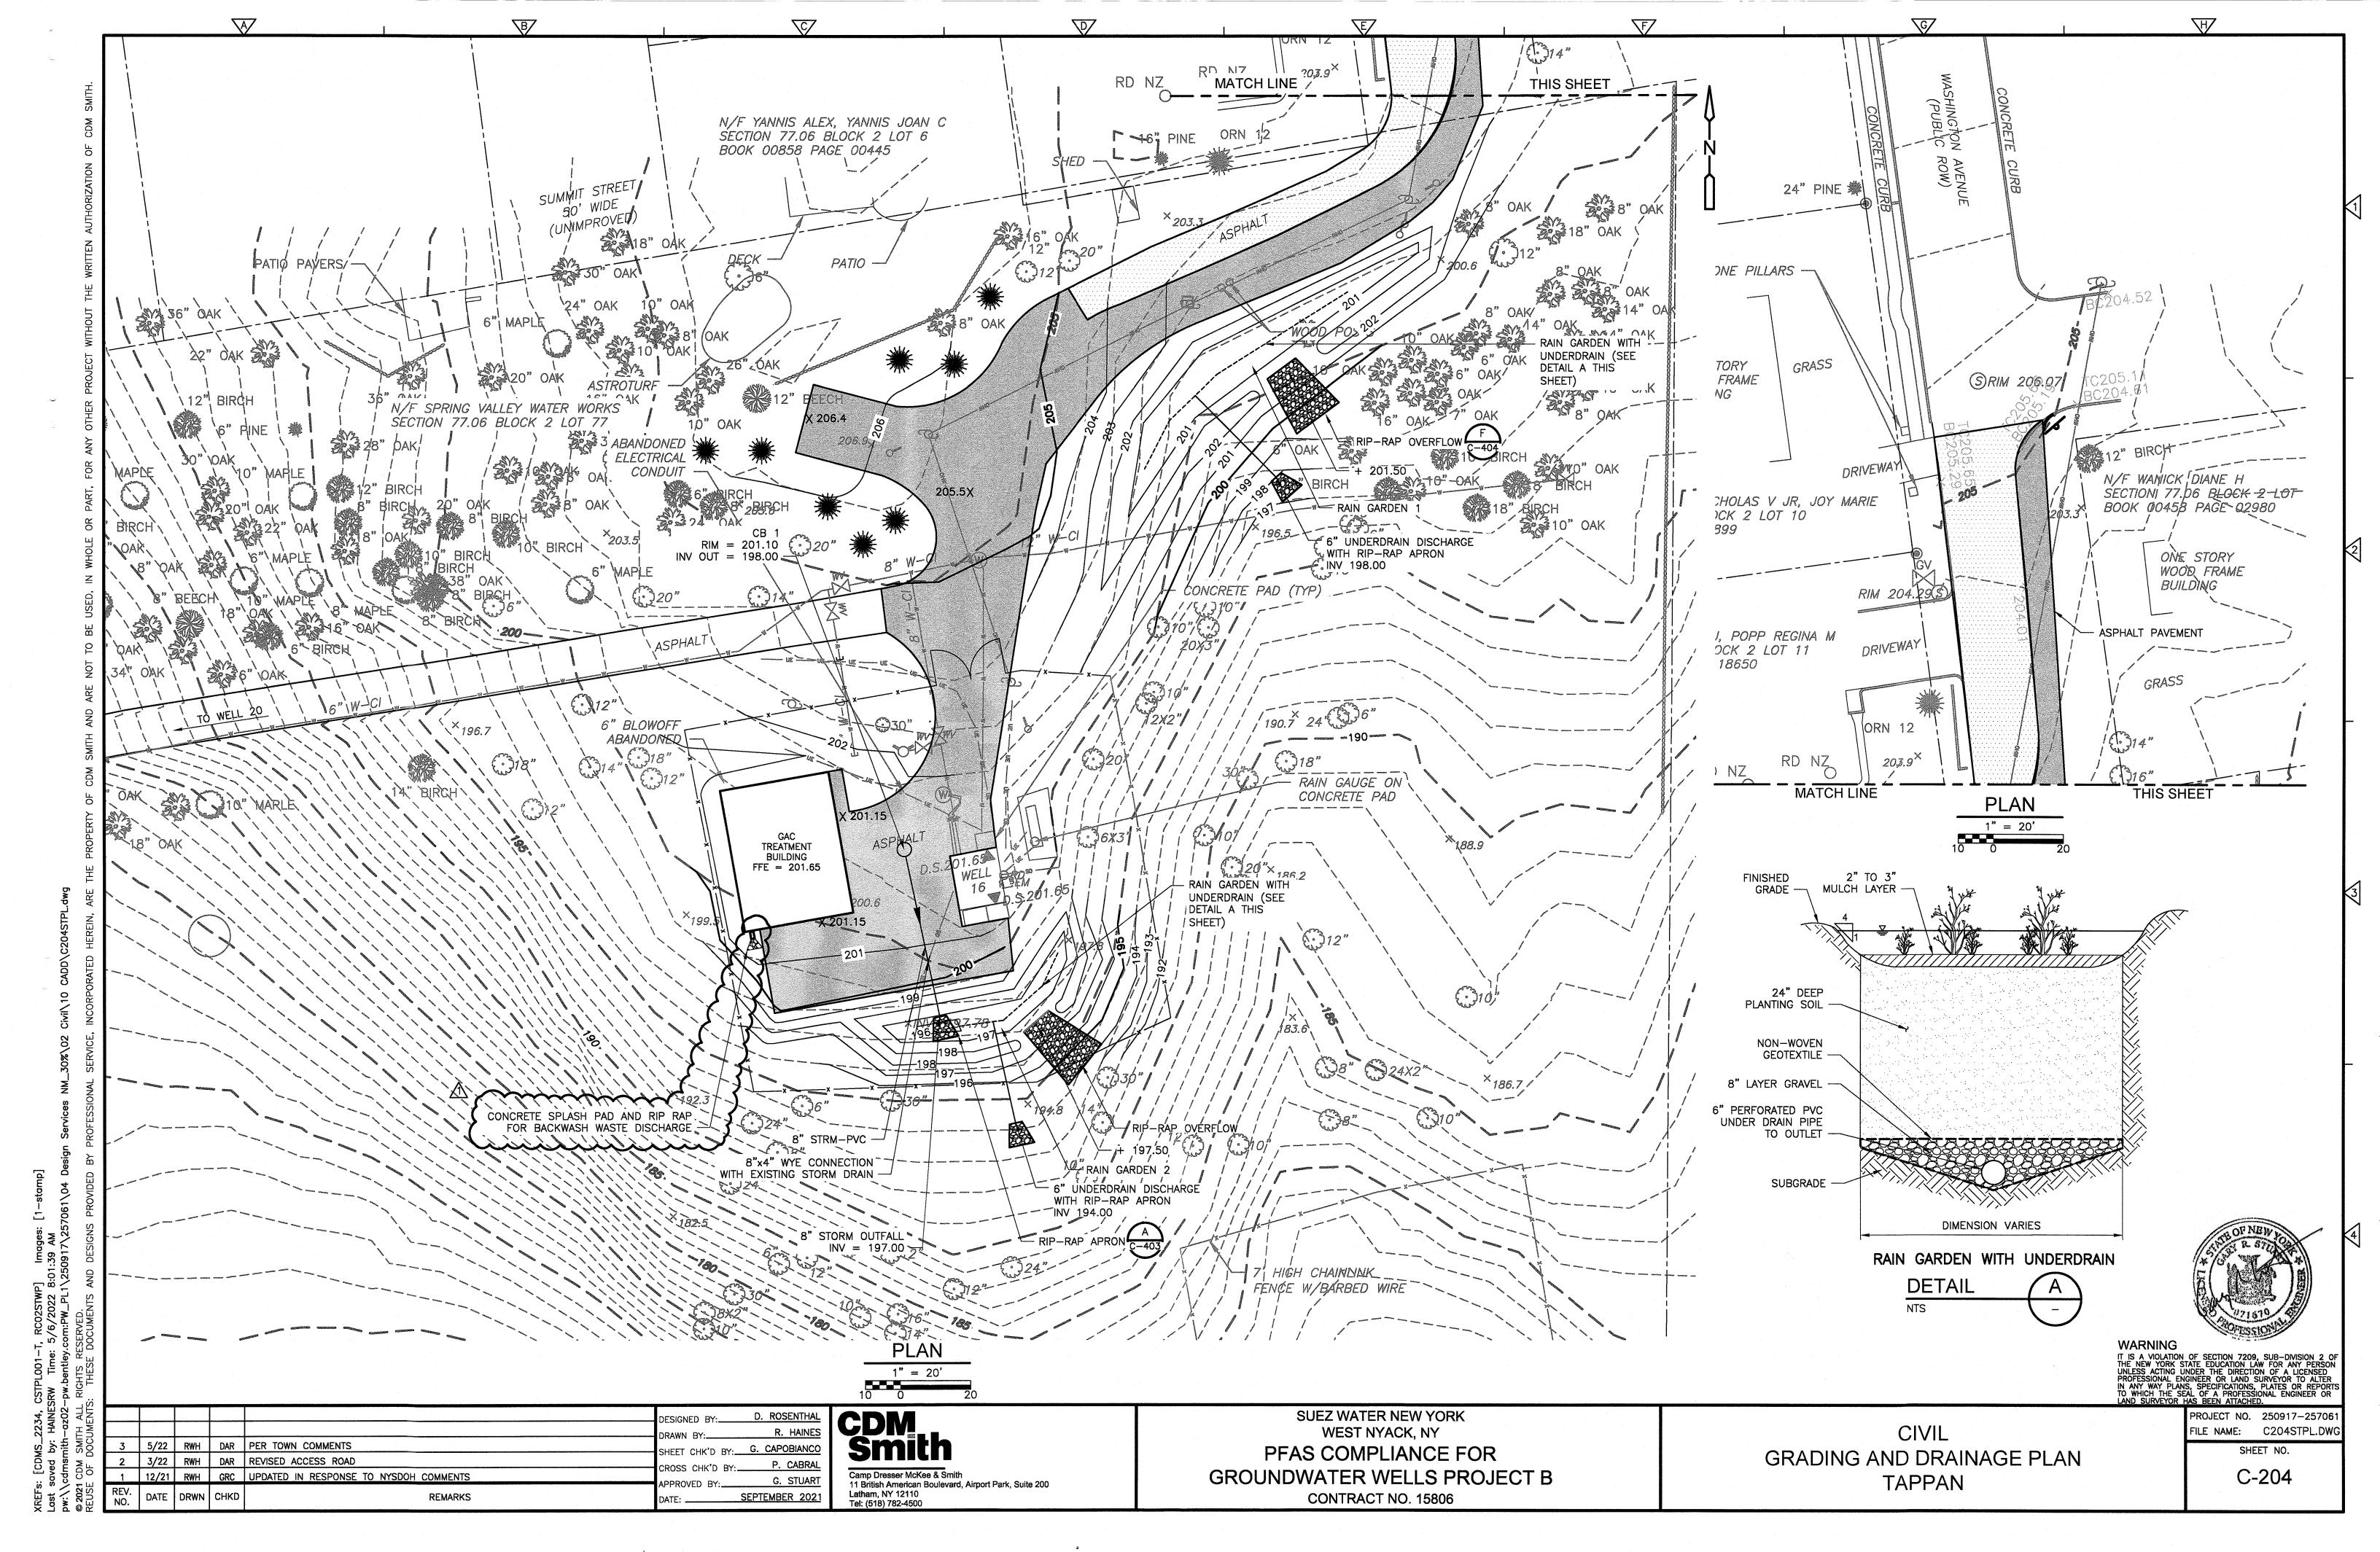
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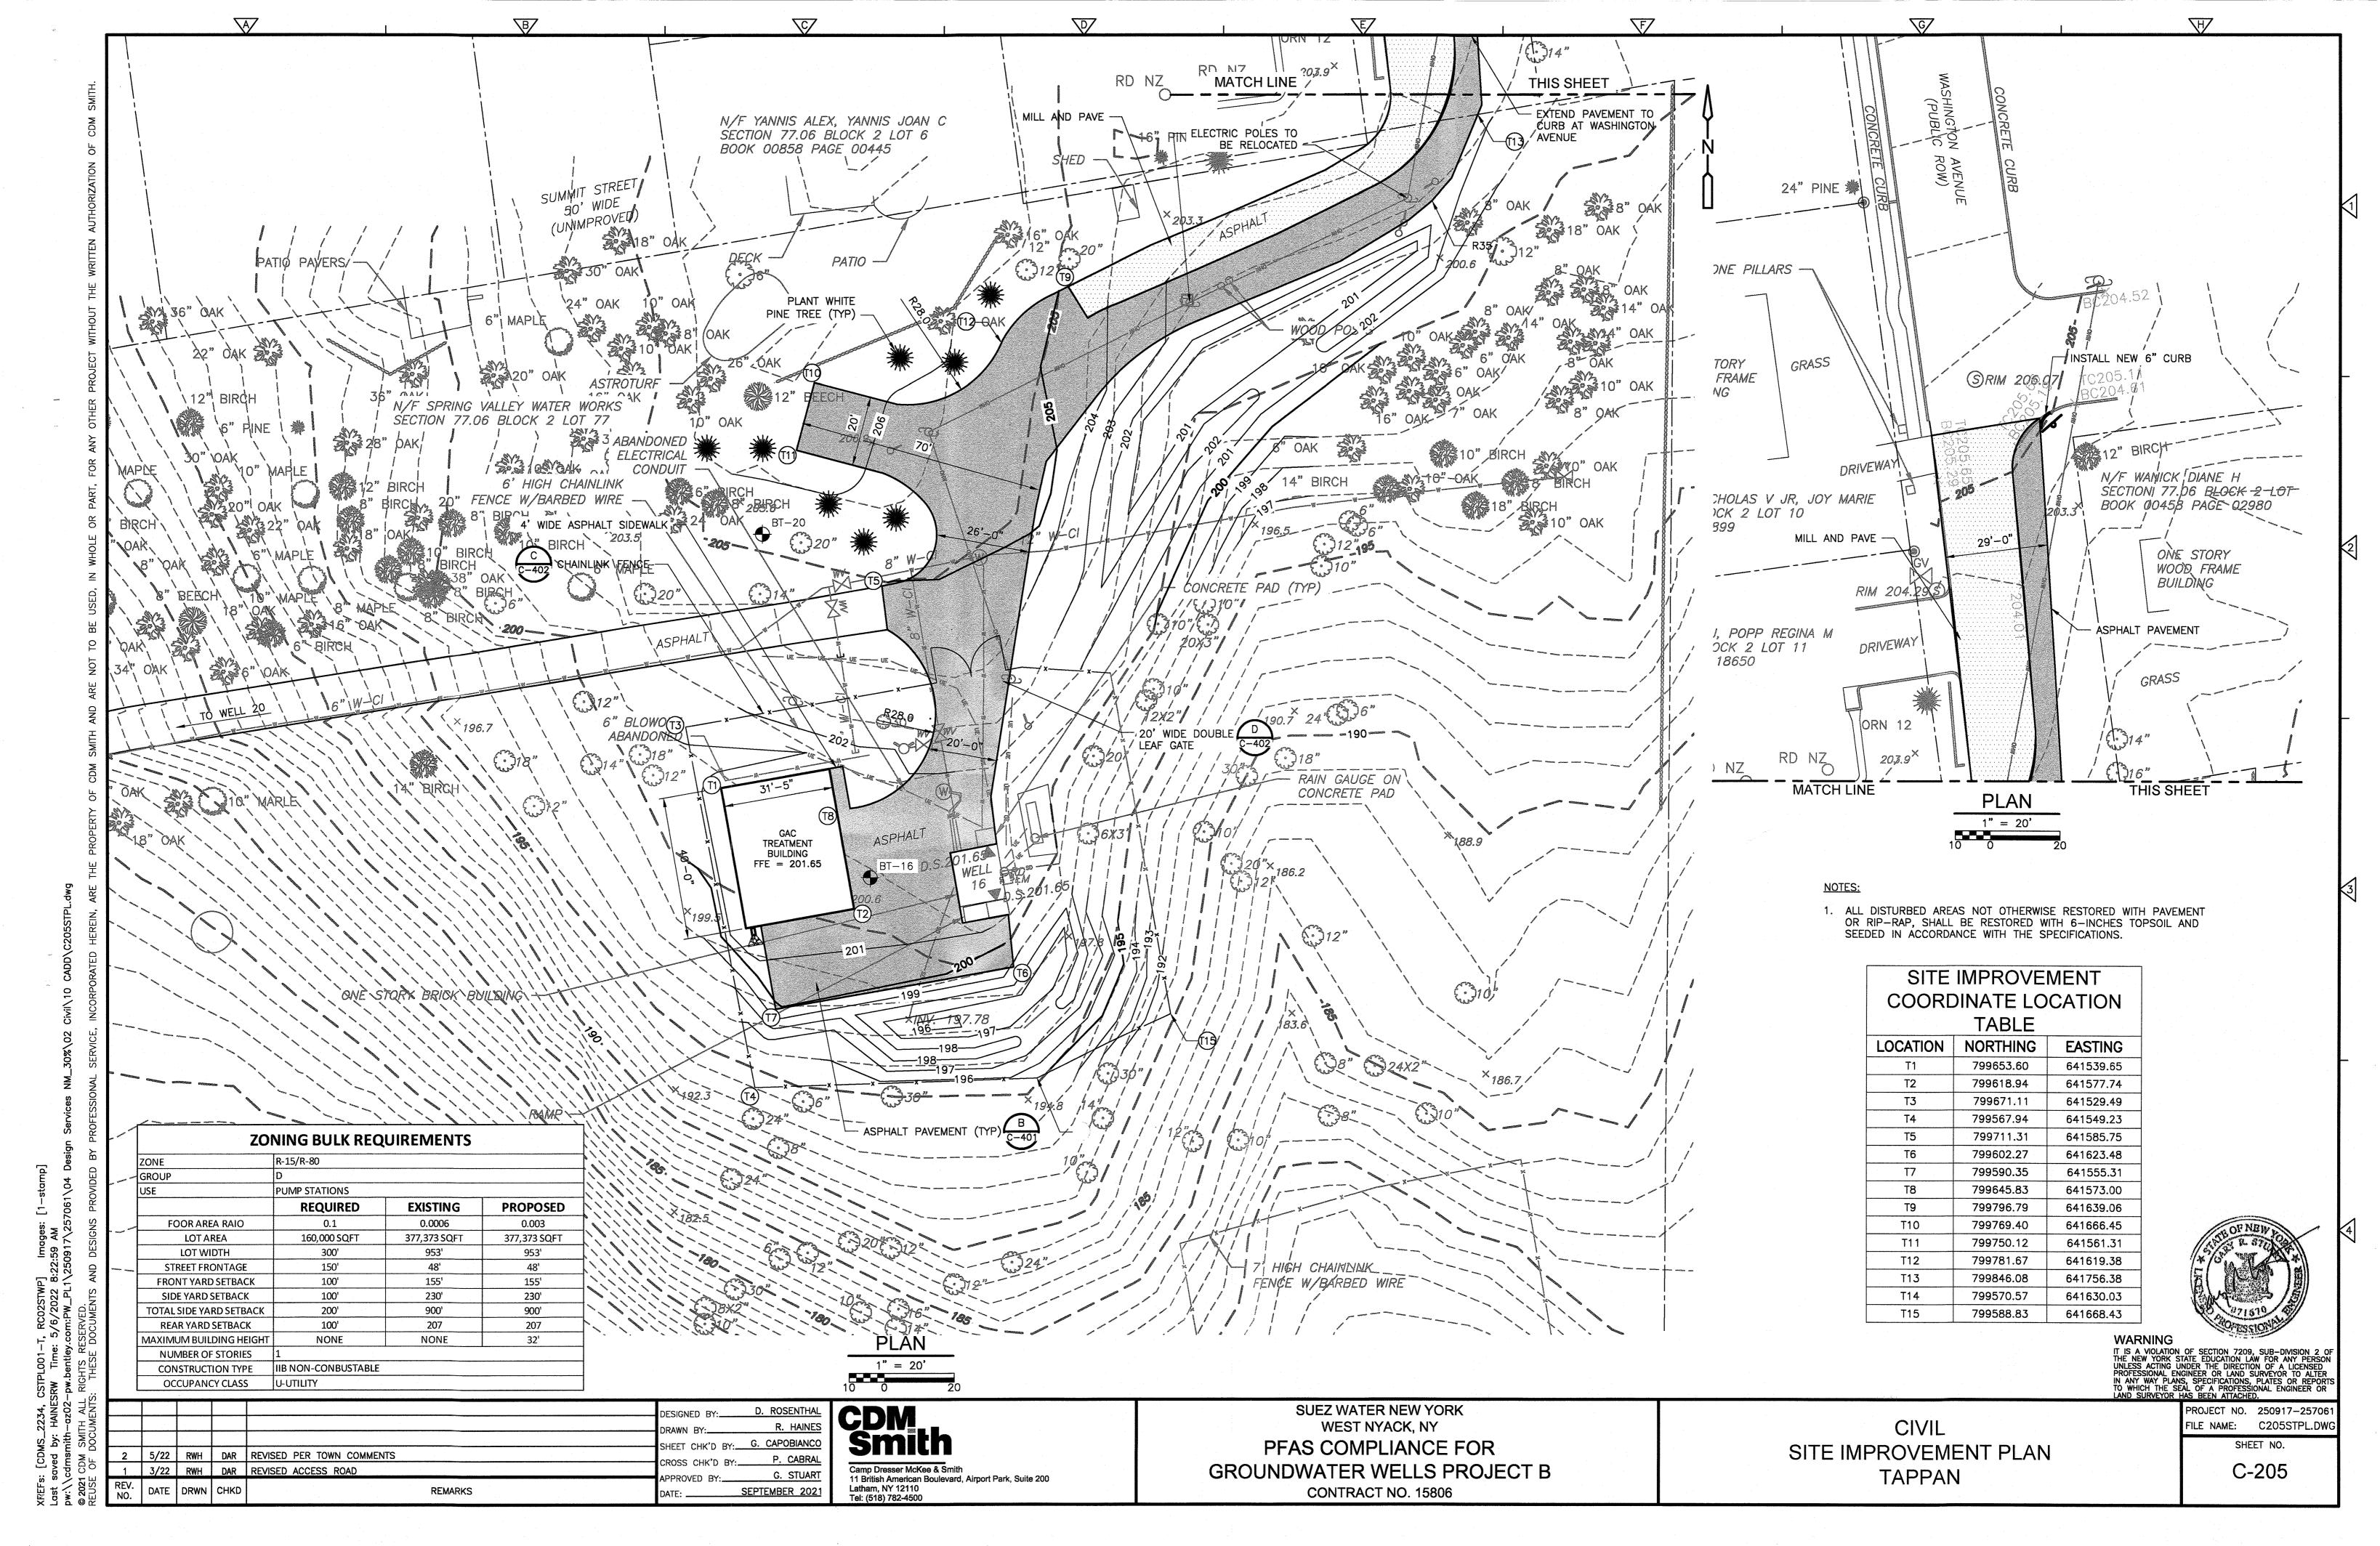
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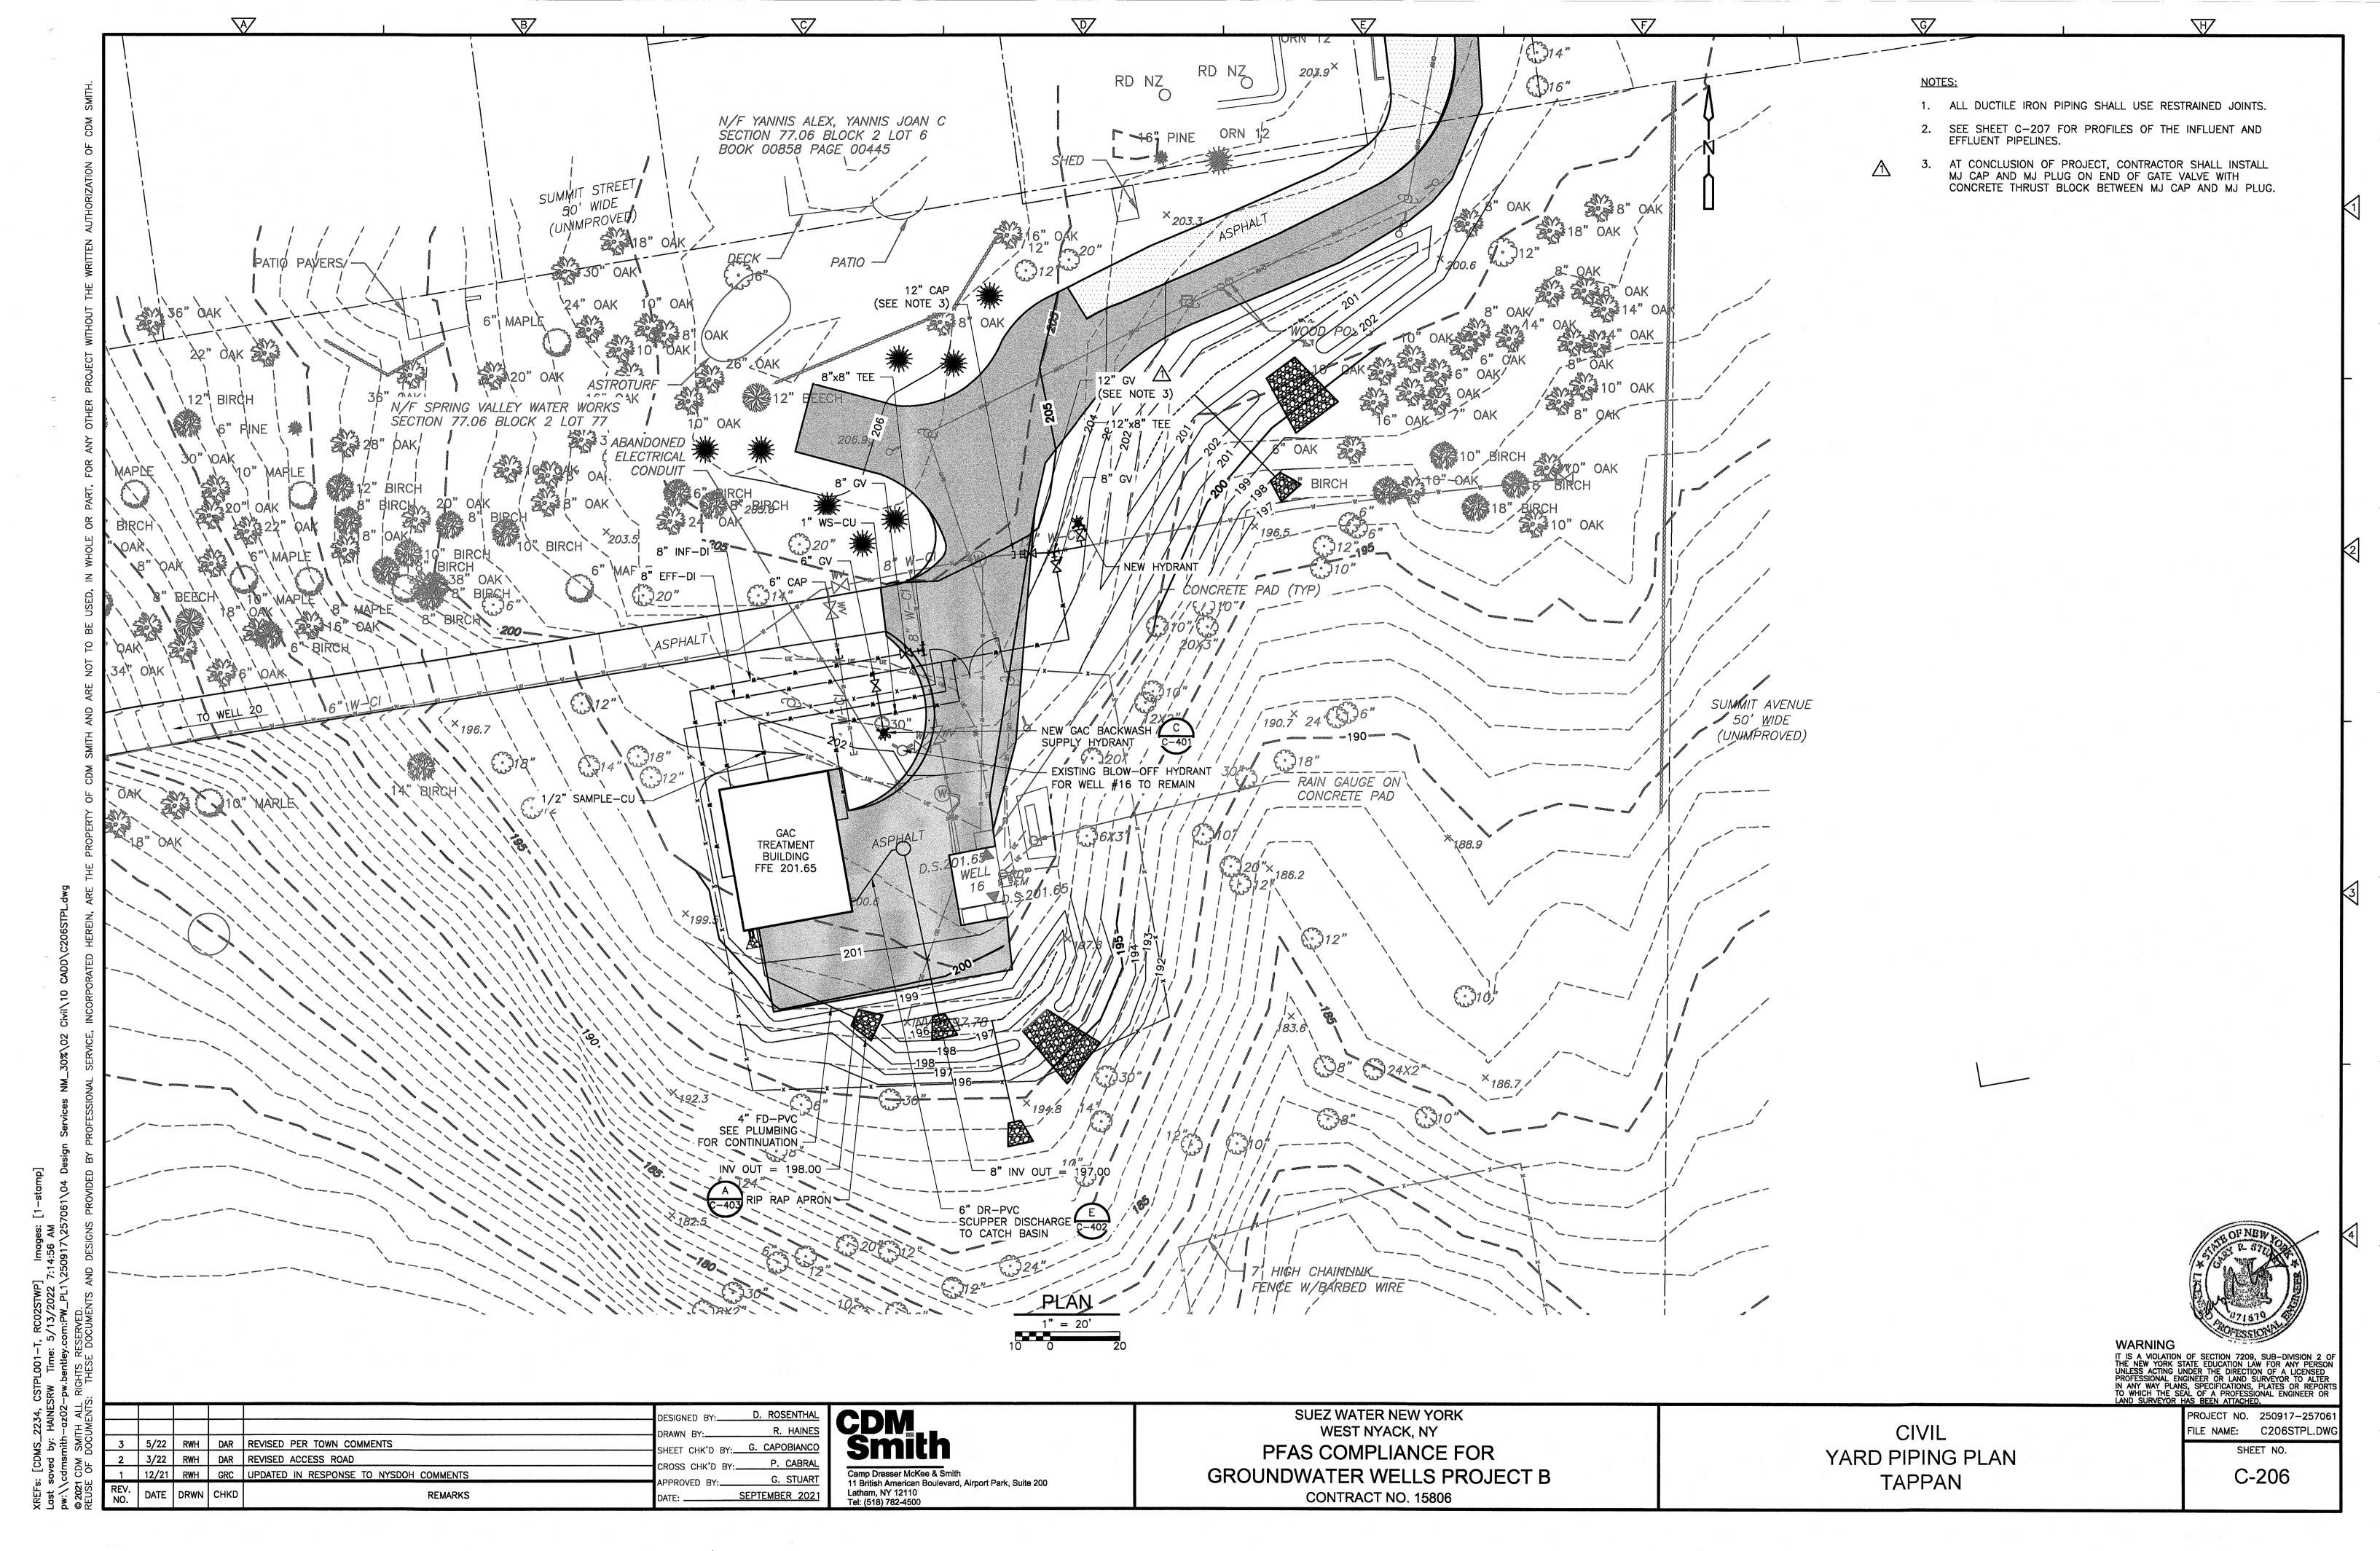










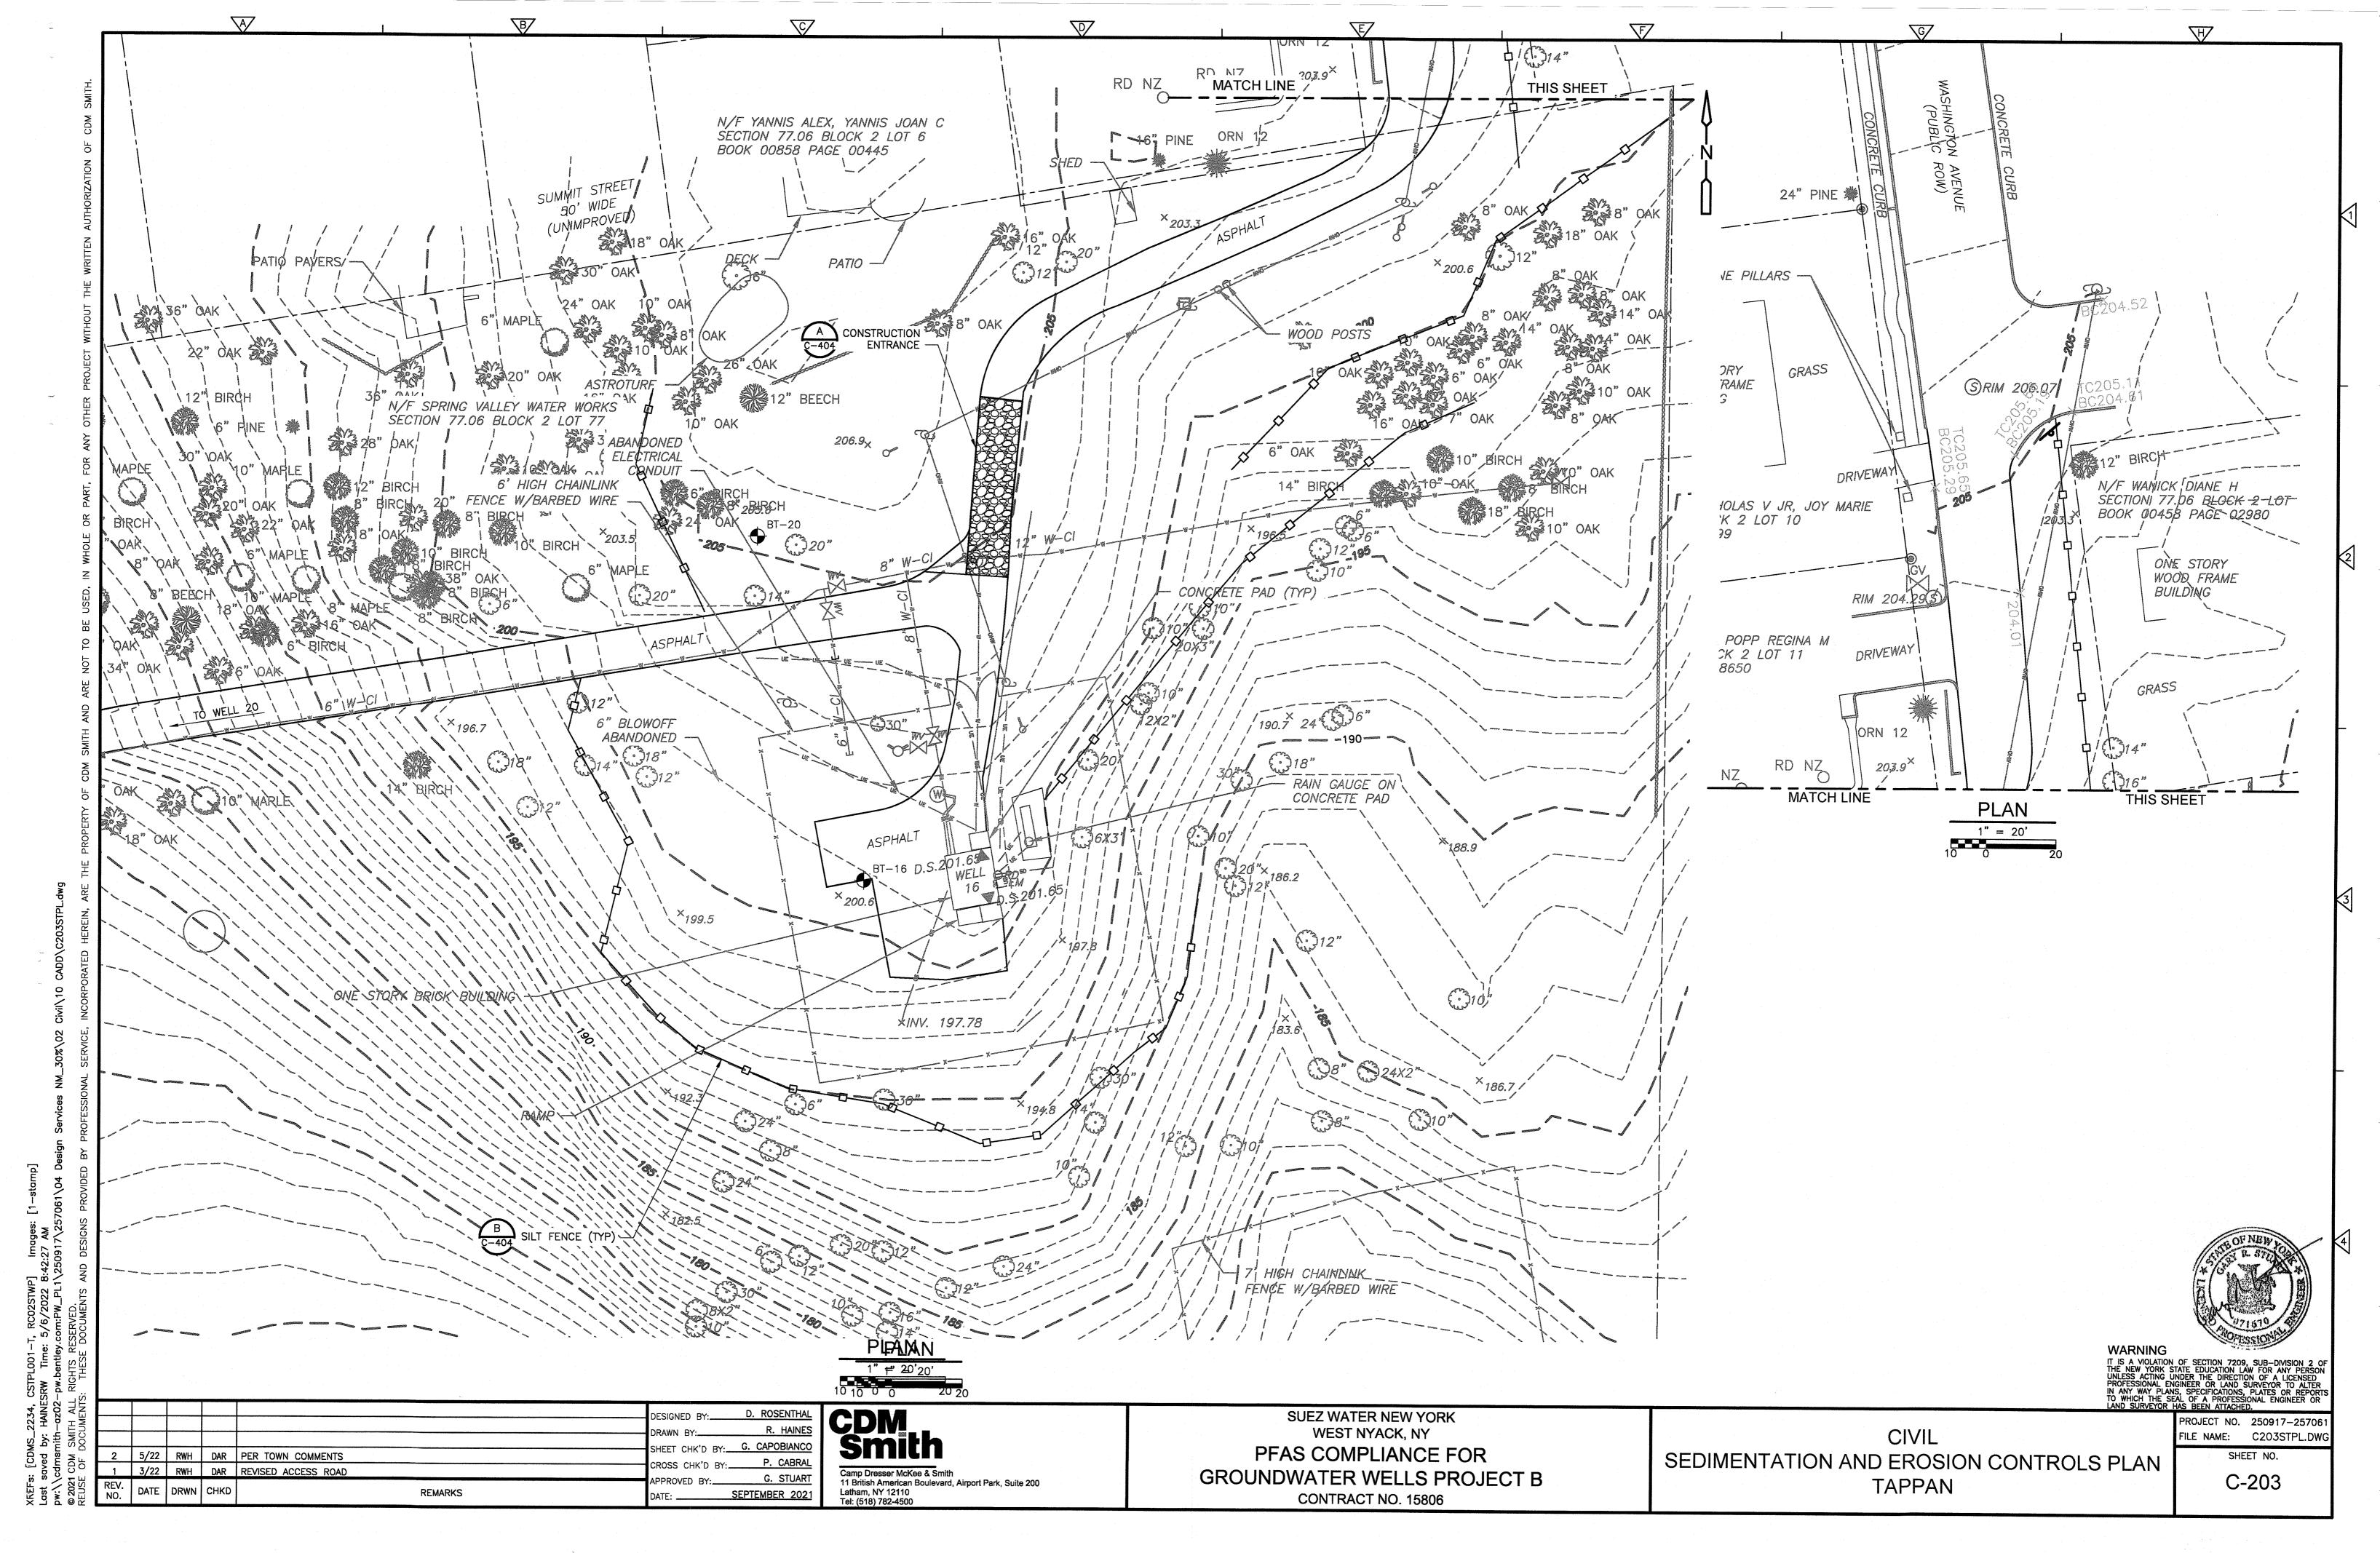

CB STA 0+00 RIM 201.10 INV IN 198.25 6" PVC \_EXIST GRADE \_EXIST GRADE GAC BUILDING GAC BUILDING-INV OUT 198.00 8" PVC PROPOSED GRADE-EXIST GRADE 210-PROPOSED GRADE-6" W-CI -8" W-CI [ (TO BE REMOVED) PROPOSED GRADE (FET) (FEET) 49 LF 8" PVC @ 2.05%— 190-190-12"x8" TEE
STA 0+00
8" GV
STA 0+04
8" 90" BEND
STA 0+25 8"x6" TEE STA 0+82 180-175 0+00 1+00 0+00 1+60 0+49 0+00 1+00 1+25 8" EFFLUENT 8" INFLUENT 8" STORM DRAIN PROFILE PROFILE PROFILE HORIZONTAL: 1" = 20' VERTICAL: 1" = 5' HORIZONTAL: 1" = 20' VERTICAL: 1" = 5' HORIZONTAL: 1" = 20' VERTICAL: 1" = 5'

D. ROSENTHA

P. CABRAL

G. STUART

JULY 2021

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Tel: (518) 782-4500

SUEZ WATER NEW YORK

WEST NYACK, NY

PFAS COMPLIANCE FOR

GROUNDWATER WELLS PROJECT B

CONTRACT NO. 15806

REV. DATE DRWN CHKD

REMARKS

90% SUBMITTAL - NOT FOR CONSTRUCTION

CIVIL

PIPING PROFILES


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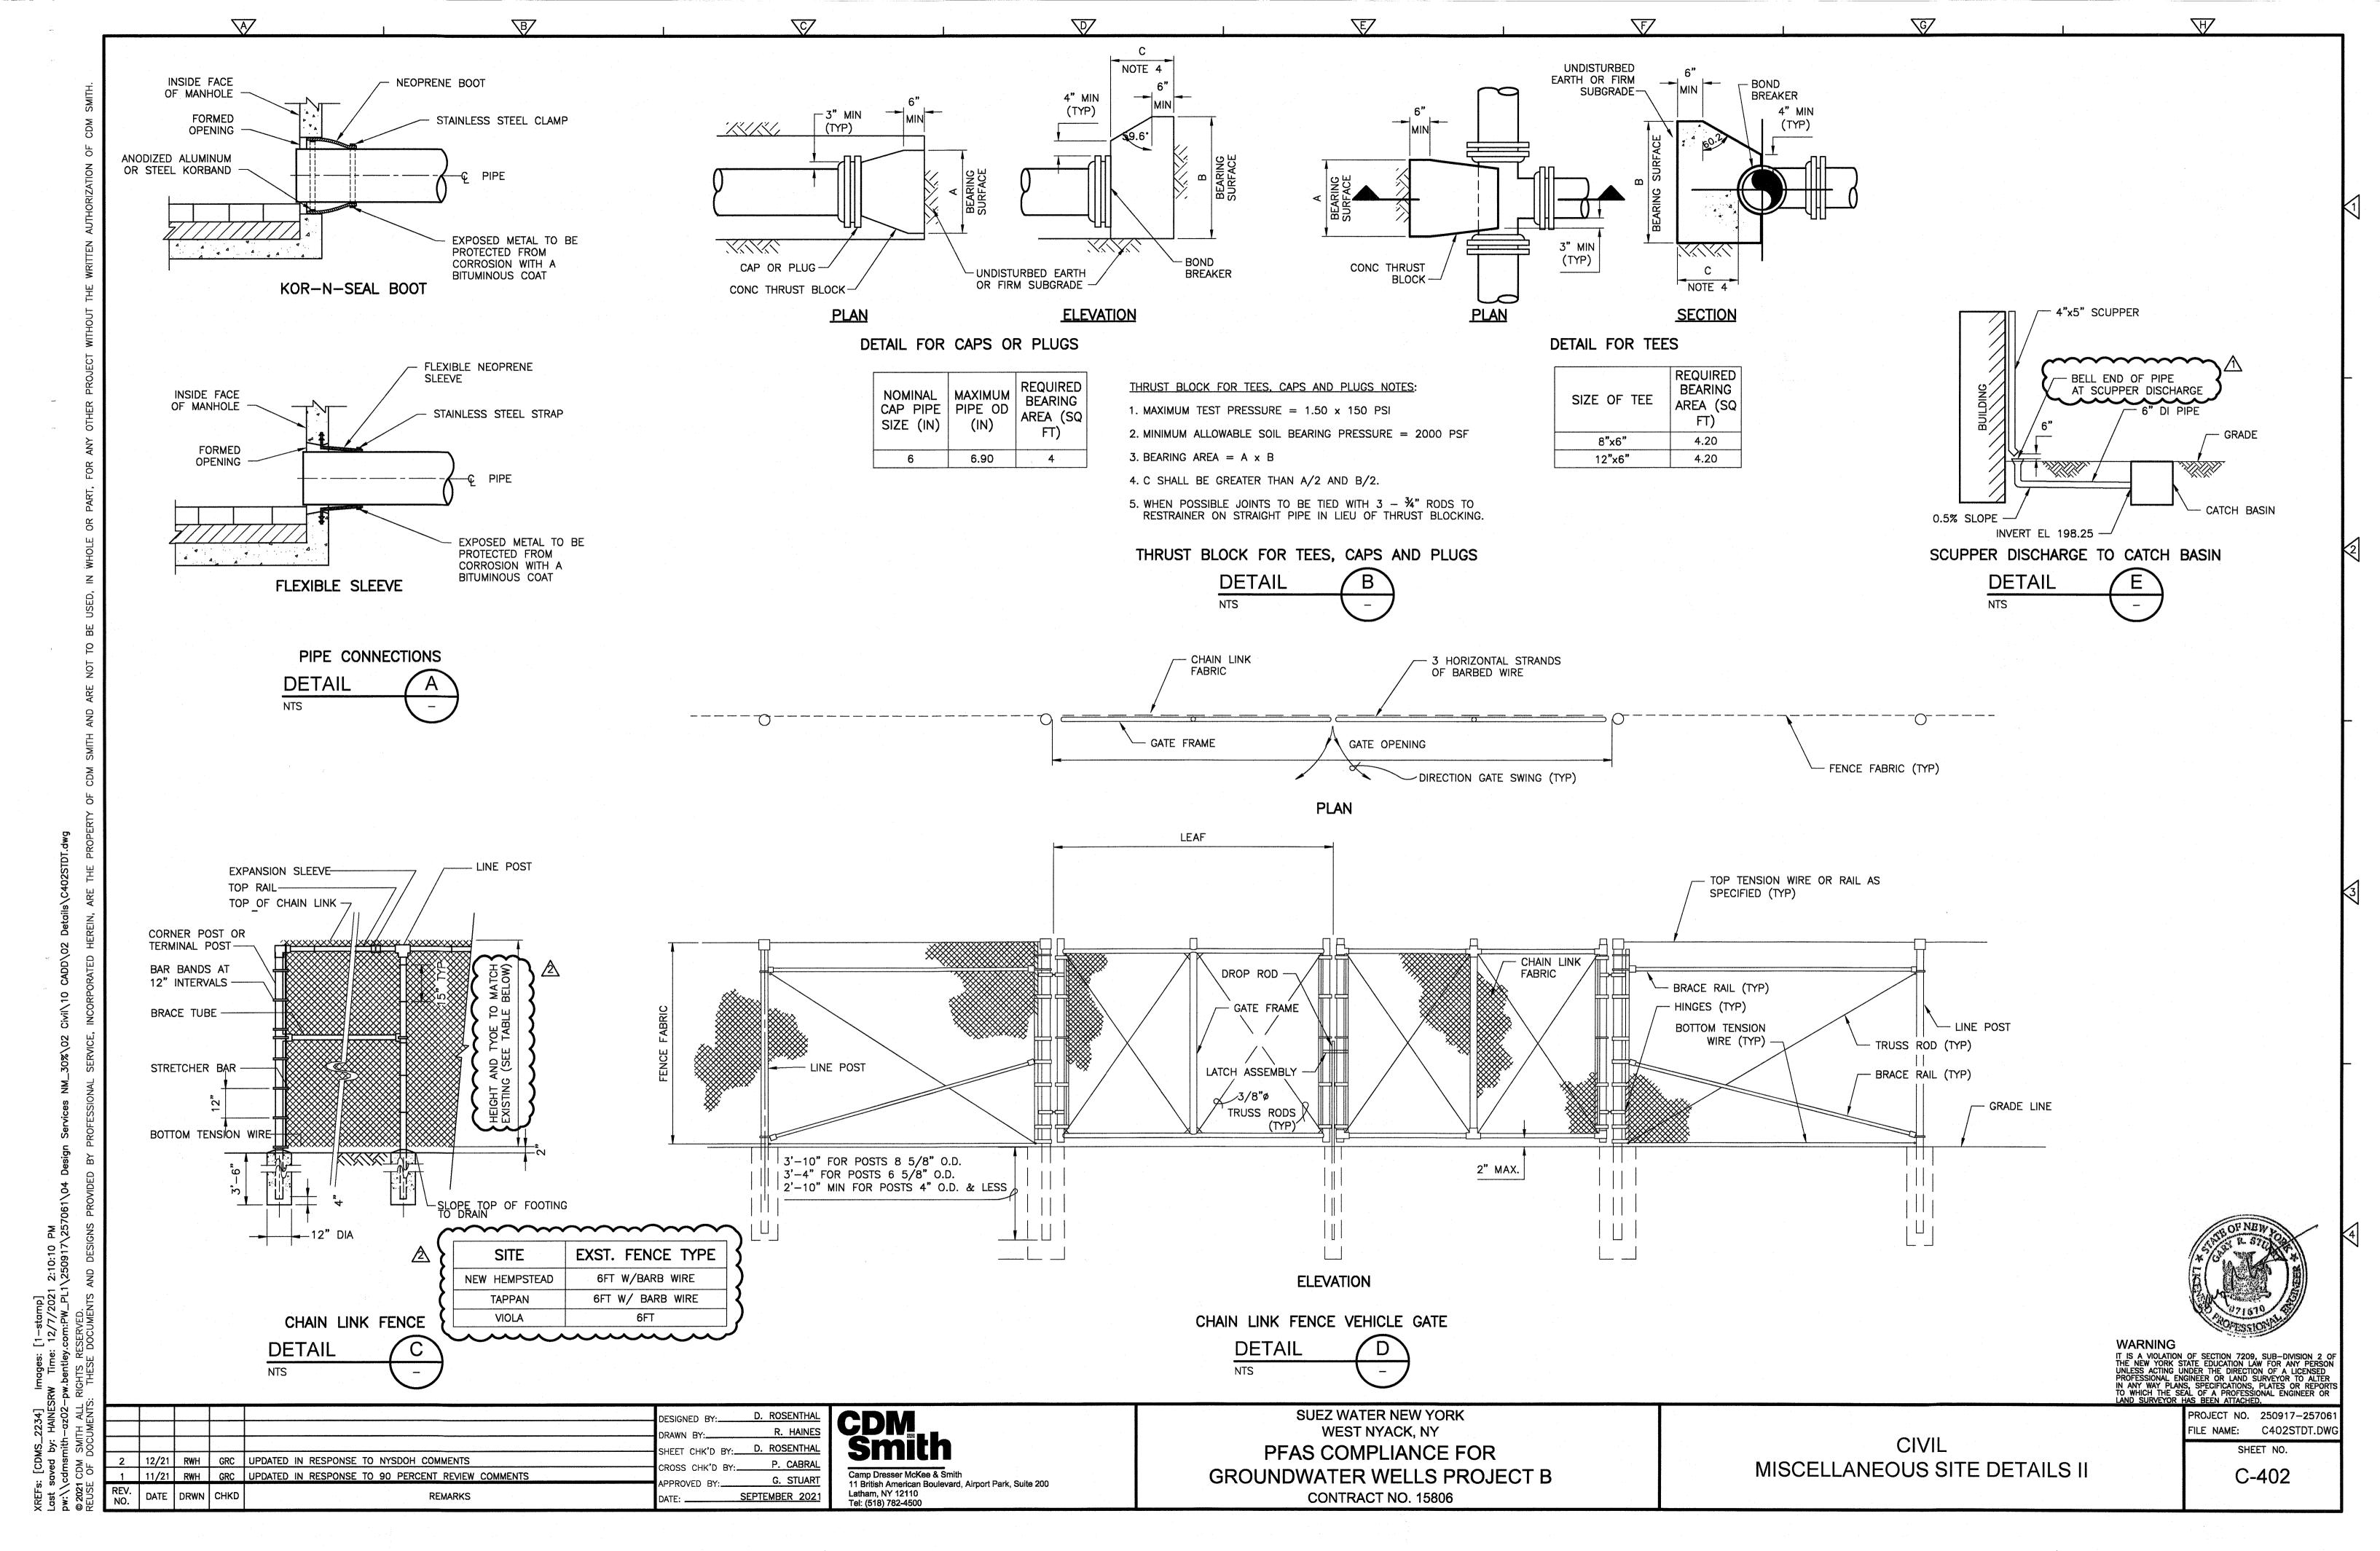
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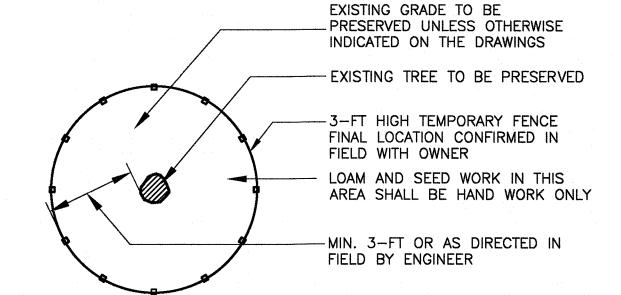
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#### NOTE: PLACE FILTER FABRIC UNDER RIPRAP

OUTFALL NO.	LENGTH L = (FT)	DEPTH (IN)	UPSTREAM WIDTH U = (FT)	DOWNSTREAM WIDTH D = (FT)	d <sub>50</sub> (IN)	dmax (IN)
NEW HEMPSTEAD	4	6	1.5	4.5	3	4
TAPPAN CATCHBASIN	6	6	1.5	6.5	3	4
VIOLA	4	6	1.5	4.5	3	4
FLOOR DRAINS (ALL SITES)	2	6	1.0	2.0	3	4
BACKWASH DISCHARGES (NEW HEMPSTEAD AND TAPPAN)	4	6	1.5	4.5	3	4
TAPPAN RG UNDERDRAINS	4	6	1.0	4.5	3	4

SURFACE BASE SUBBASE

STANDARD CURB

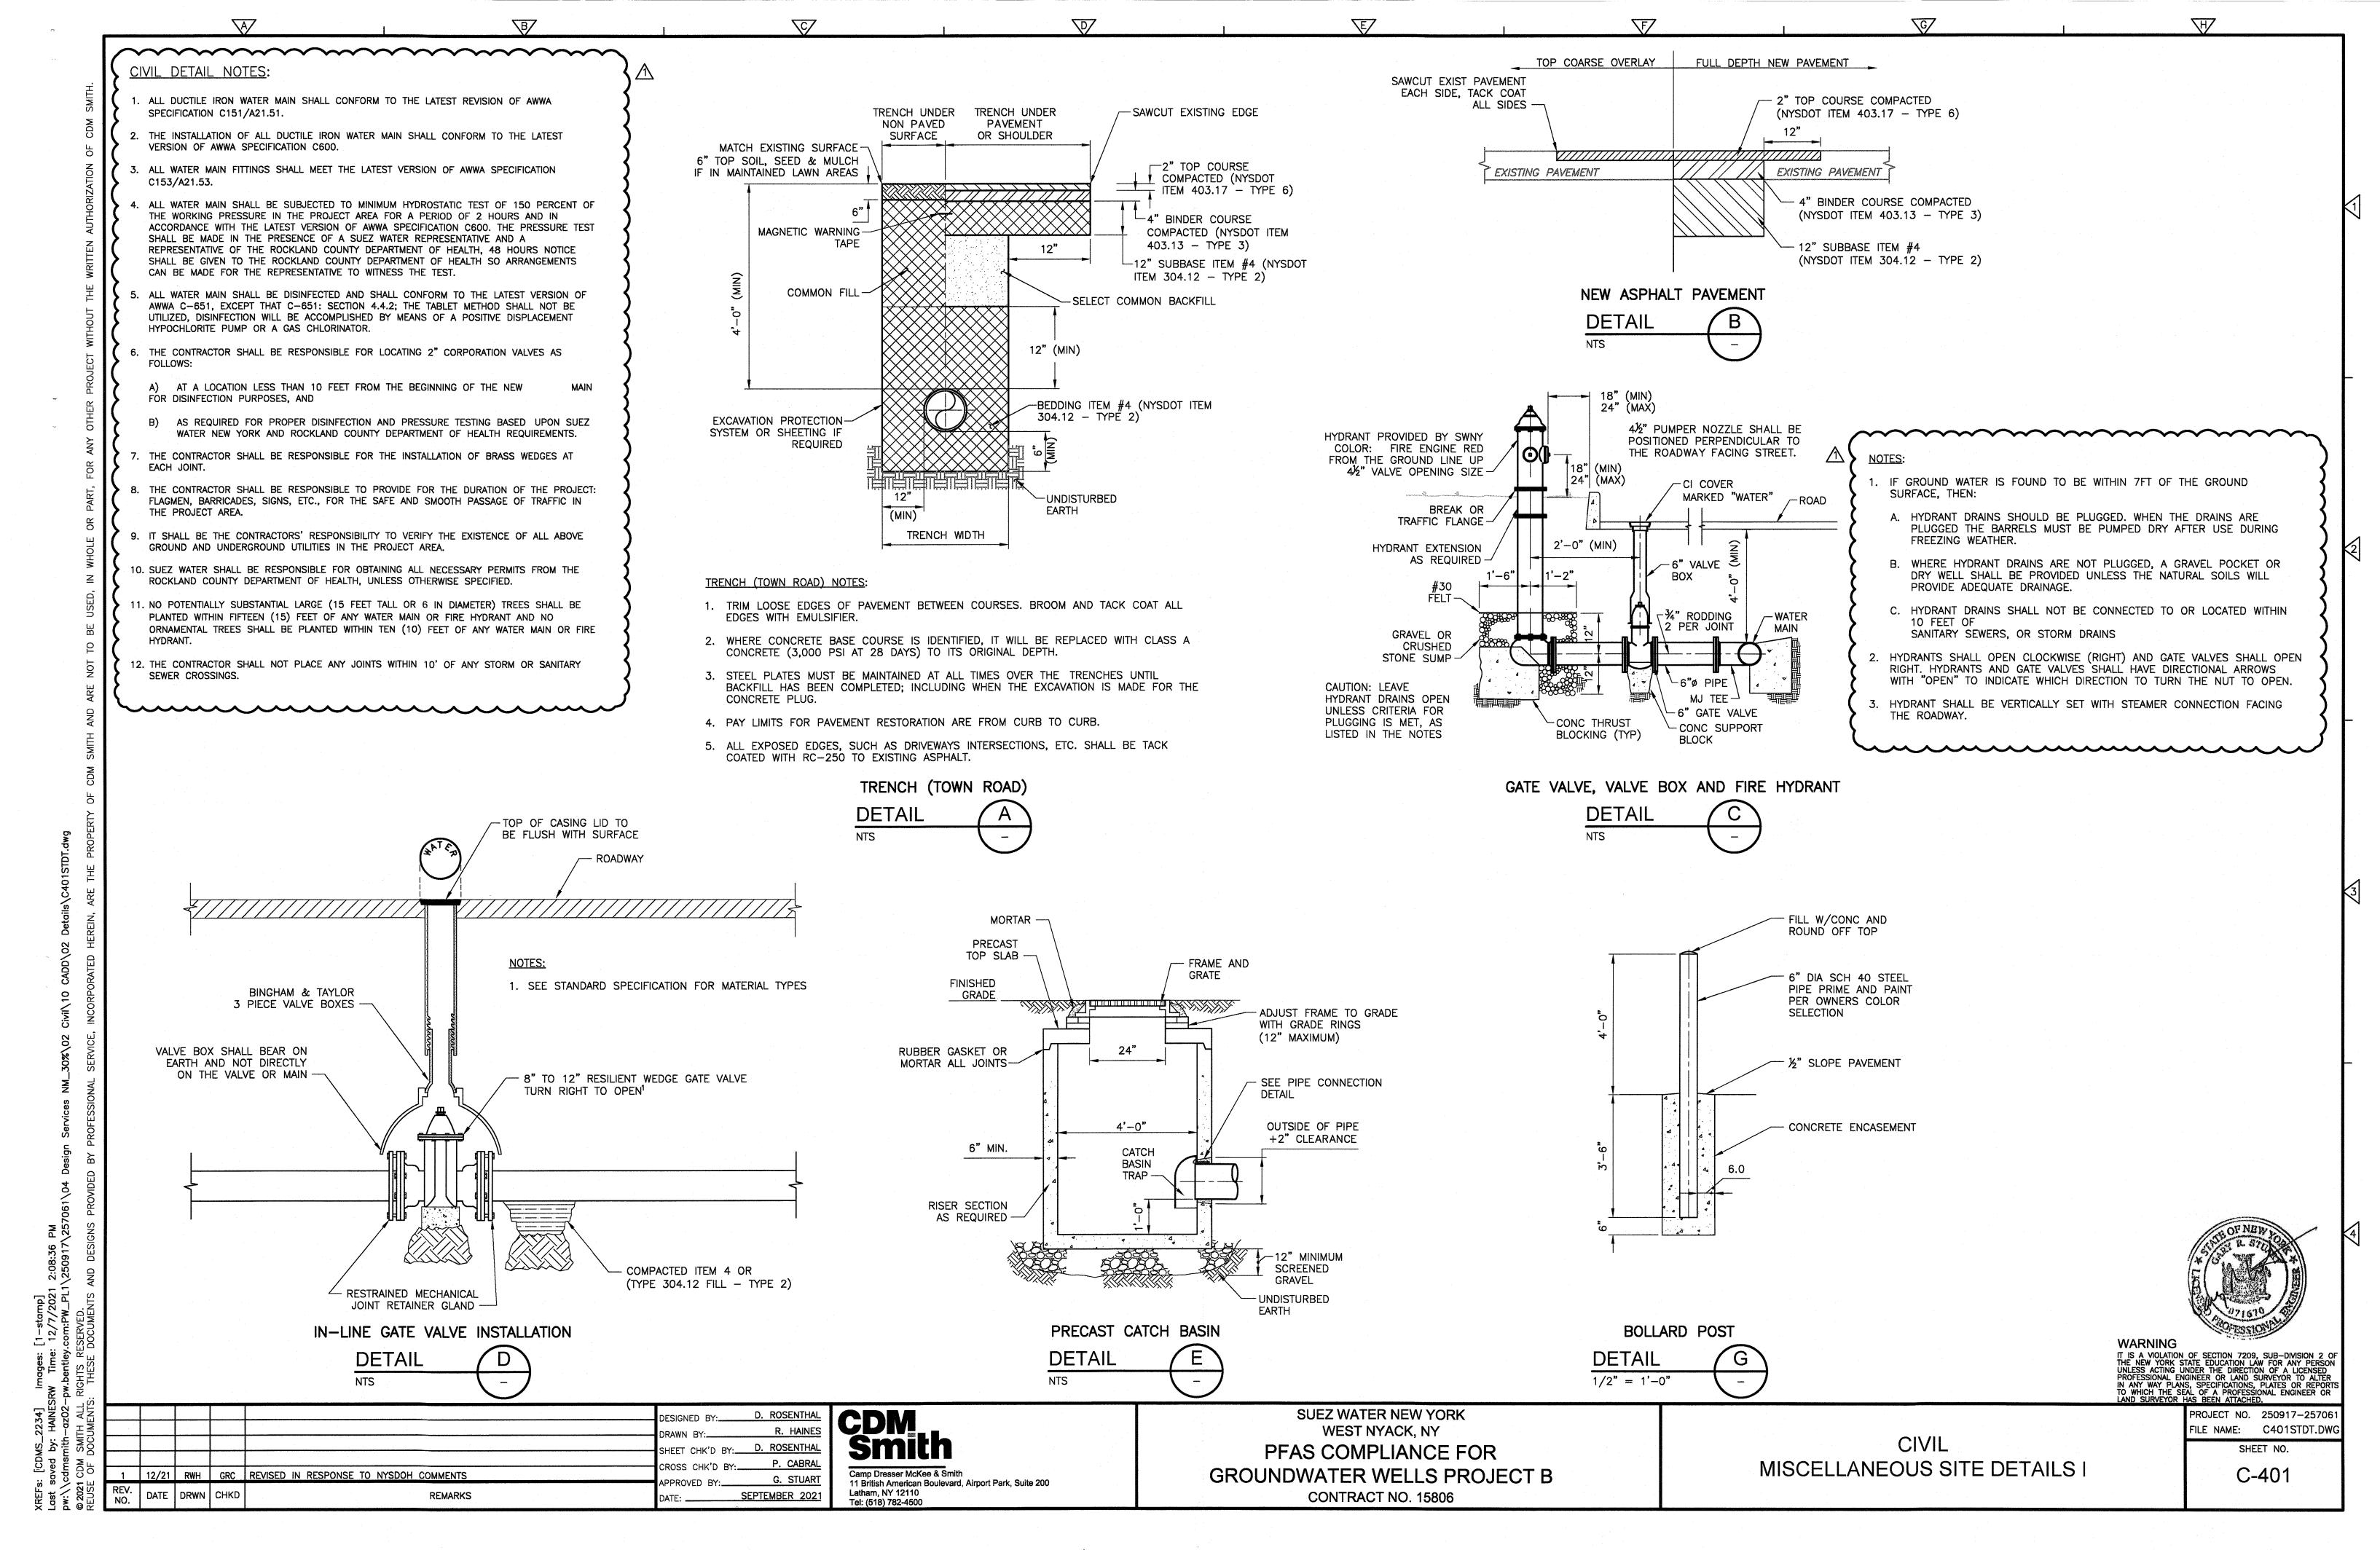

NOTES:
1. FENCING SHALL BE INSTALLED AROUND PERIMETER OF EXISTING TREE TO BE PROTECTED AS SHOWN ON PLANS.

2. FENCING SHALL REMAIN IN PLACE AND BE MAINTAINED THROUGHOUT CONSTRUCTION AND THEN REMOVED COMPLETELY AS DIRECTED BY OWNER TO COMPLETE LOAMING AND SEEDING ACTIVITIES.

### TREE PROTECTION

**DETAIL** 




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DETAIL	A
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SUEZ WATER NEW YORK WEST NYACK, NY PFAS COMPLIANCE FOR GROUNDWATER WELLS PROJECT B CONTRACT NO. 15806

CIVIL MISCELLANEOUS SITE DETAILS III FILE NAME: C403STDT.DW SHEET NO. C-403

D. ROSENTHA 2 5/22 RWH DAR REVISED PER TOWN COMMENTS 1 12/21 RWH GRC UPDATED IN RESPONSE TO NYSDOH COMMENTS G. STUART DATE DRWN CHKD REMARKS SEPTEMBER 2021


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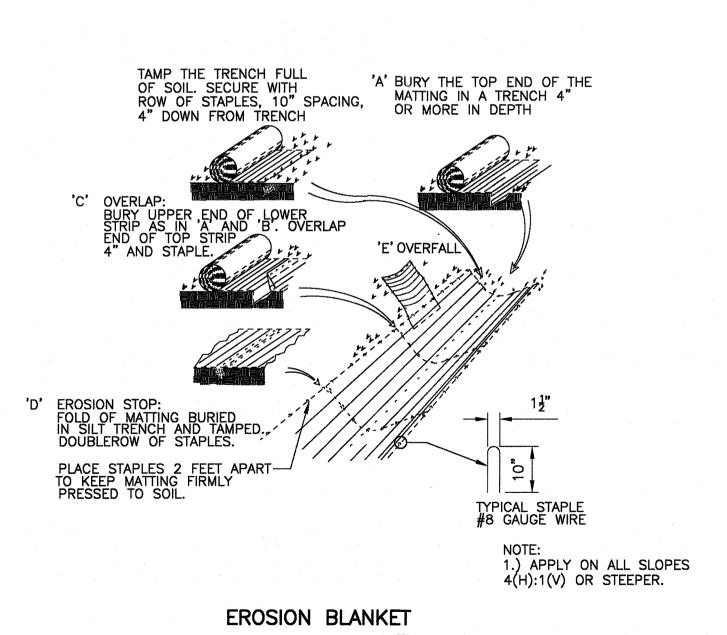


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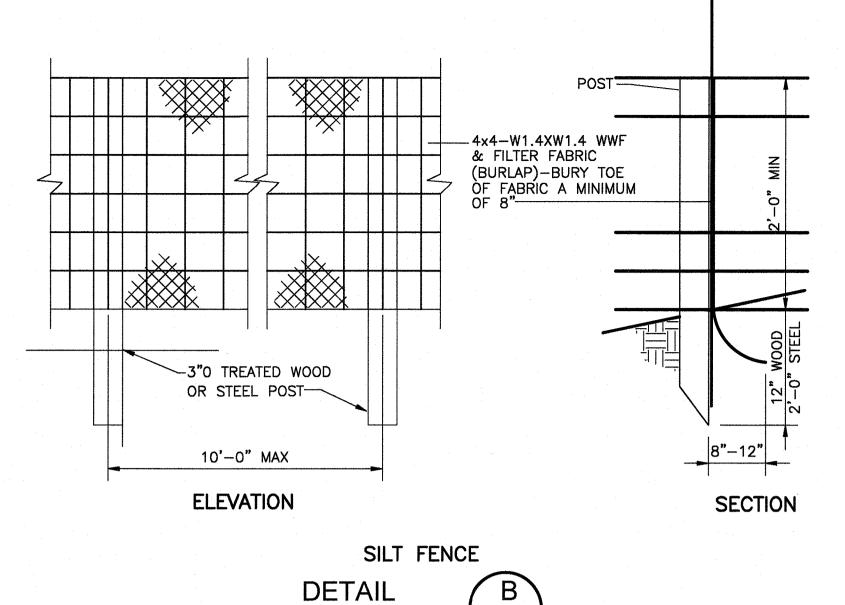
PROVIDE APPROPRIATE TRANSITION BETWEEN STABILIZED CONSTRUCTION ENTRANCE AND PUBLIC RIGHT-OF-WAY
THE ENTRANCE SHALL BE MAINTAINED IN A CONDITION WHICH WILL PREVENT TRACKING OR FLOWING OF SEDIMENT ONTO PUBLIC RIGHT-OF-WAY THIS MAY REQUIRE PERIODIC TOP DRESSING WITH ADDITIONAL STONE OR ADDITIONAL LENGTH AS CONDITIONS DEMAND AND REPAIR AND/OR CLEANOUT OF ANY MEASURES USED TO TRAP SEDIMENT ALL SEDIMENT SPILLED, DROPPED, WASHED, OR TRACKED ONTO PUBLIC RIGHT-OF-WAY MUST BE REMOVED IMMEDIATELY

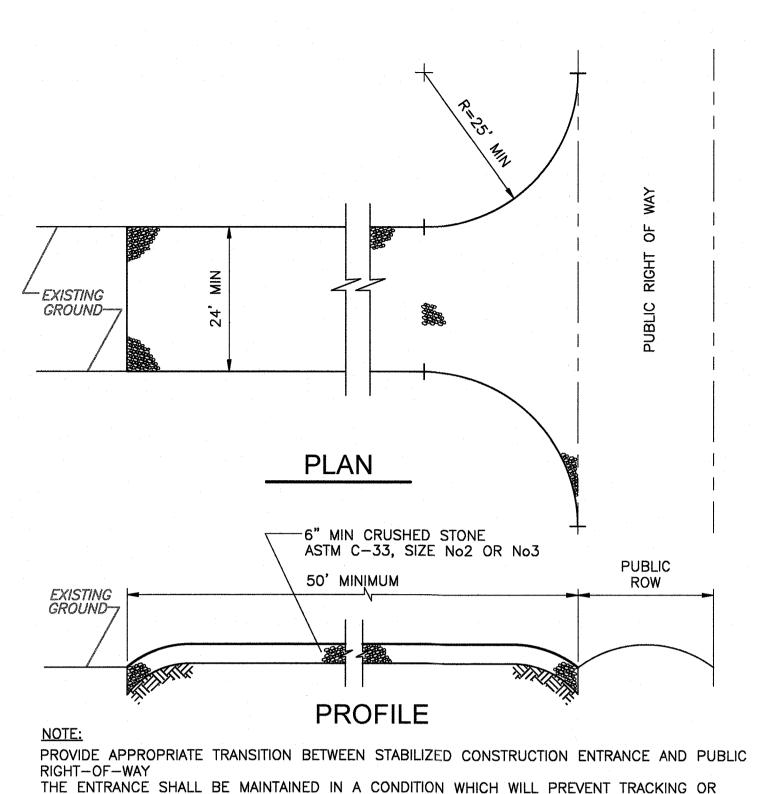
# STABILIZED CONSTRUCTION ENTRANCE




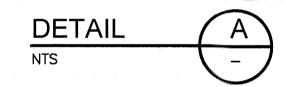

**DETAIL** 



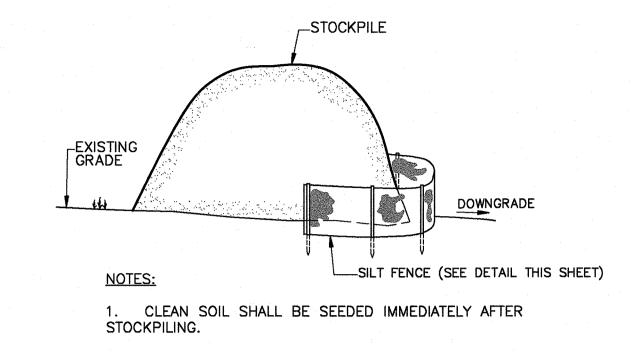


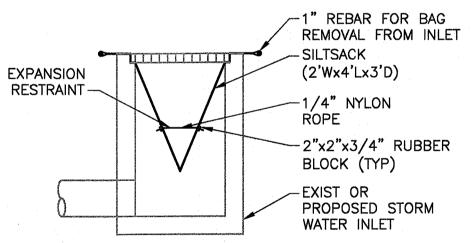


# INLET SEDIMENT CONTROL DEVICE NOTE:

- 1. GEOTEXTILE SEDIMENT COLLECTION SACKS OR BAGS THAT ARE MADE TO FIT INSIDE A STORM INLET MAY BE USED FOR STORM INLET PROTECTION. THE GEOTEXTILE SHOULD BE ABLE TO TRAP FINE SAND OR LARGER SEDIMENT. WHEN INSTALLED, THE GEOTEXTILE SACKS OR BAGS SHOULD BE SECURELY HELD IN THE STORM INLET AND THE INLET GRATE SHOULD BE IN PLACE. THE ITEMS NEEDED FOR REMOVAL OF THE GEOTEXTILE SACKS OR BAGS SHOULD BE PROVIDED AND THE SACKS OR BAGS SHOULD BE PROVIDED AND THE SACKS OR BAGS SHOULD BE REMOVED AND CLEANED OUT OR REPLACED BEFORE THEY BECOME 1/3 FULL OF SEDIMENT. GEOTEXTILE SEDIMENT COLLECTION DEVICES MUST BE INSTALLED IN ACCORDANCE WITH MANUFACTURER'S RECOMMENDATIONS.
- 2. BERMS MAY BE NECCESSARY TO DIRECT WATER INTO INLET AND TO PREVENT SEDIMENT LADEN WATER FROM BYPASSING THE INLET SEDIMENT CONTROL DEVICE.

# INLET SEDIMENT CONTROL DEVICE

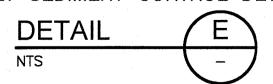

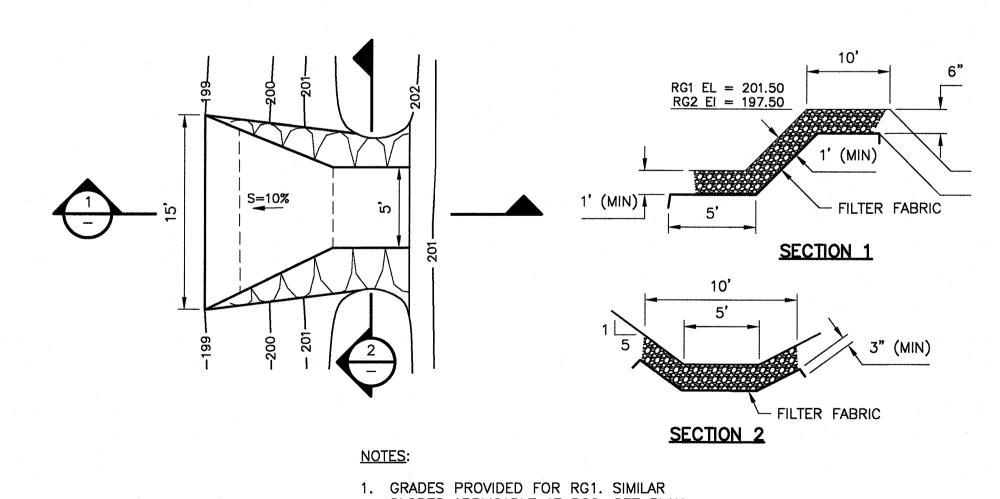

SLOPES APPLICABLE AT RG2. SEE PLAN SHEET FOR ACTUAL ELEVATIONS.

RIP RAP OVERFLOW

DETAIL

F

NTS



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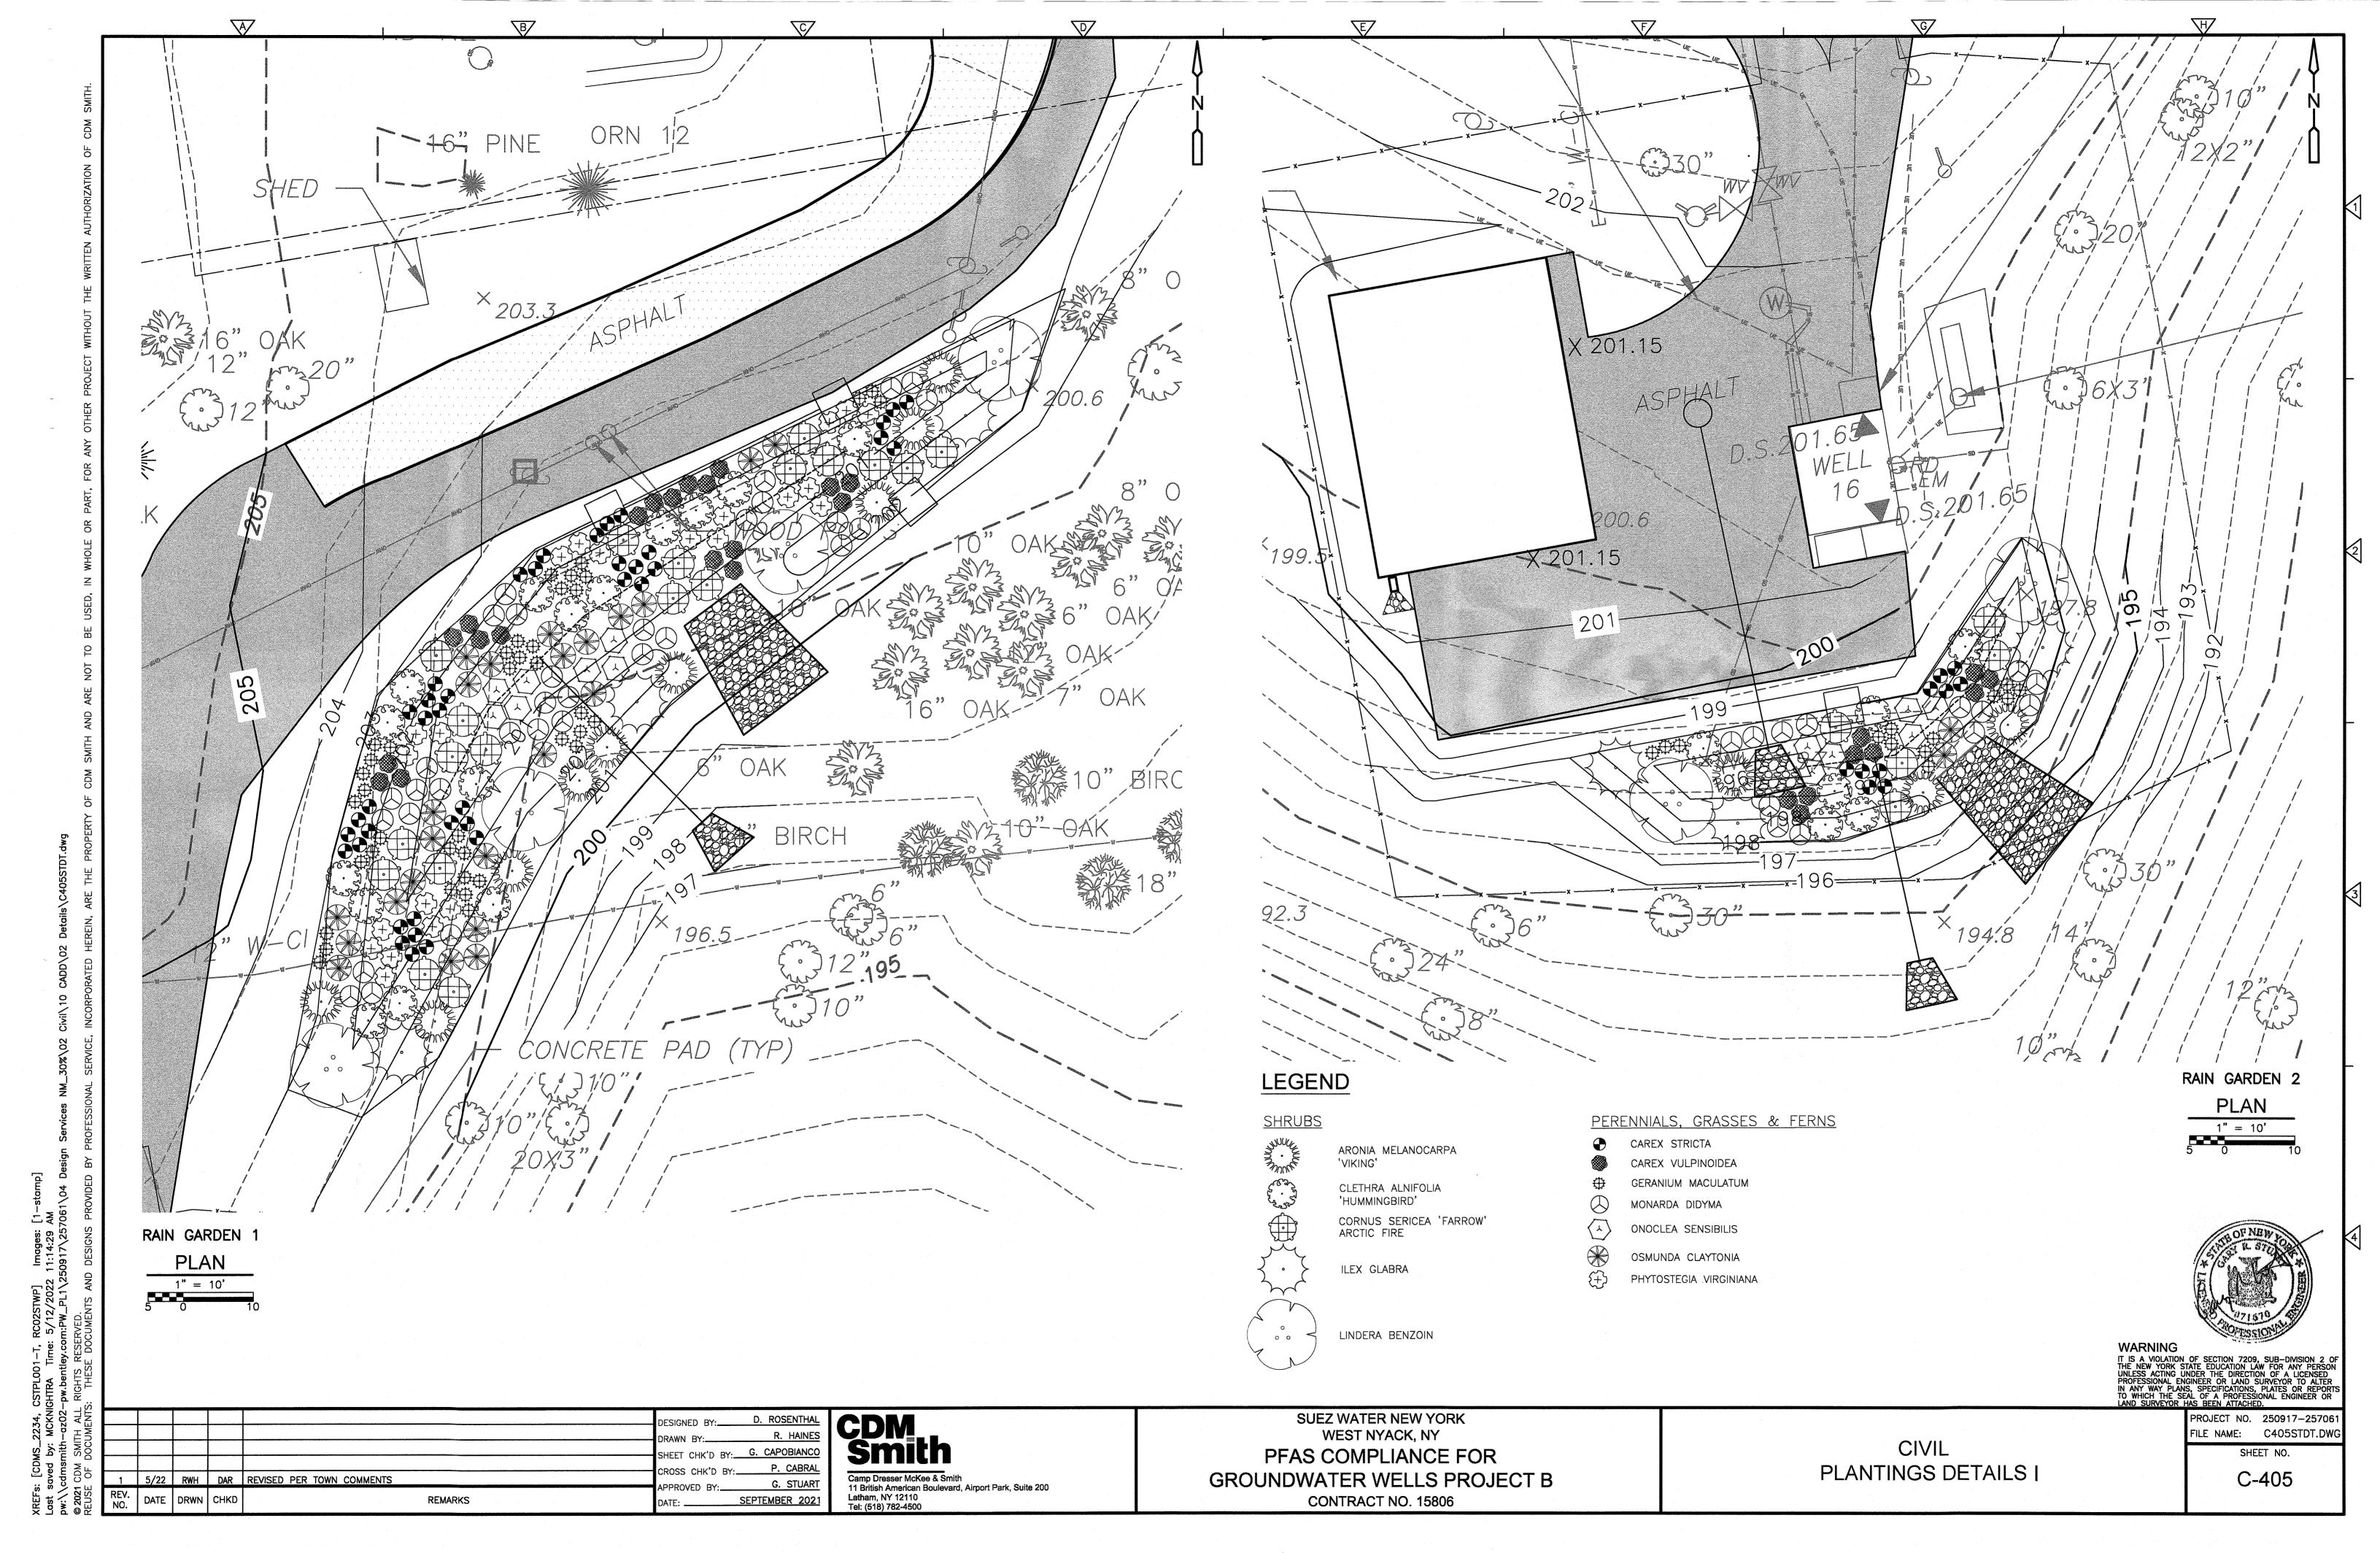
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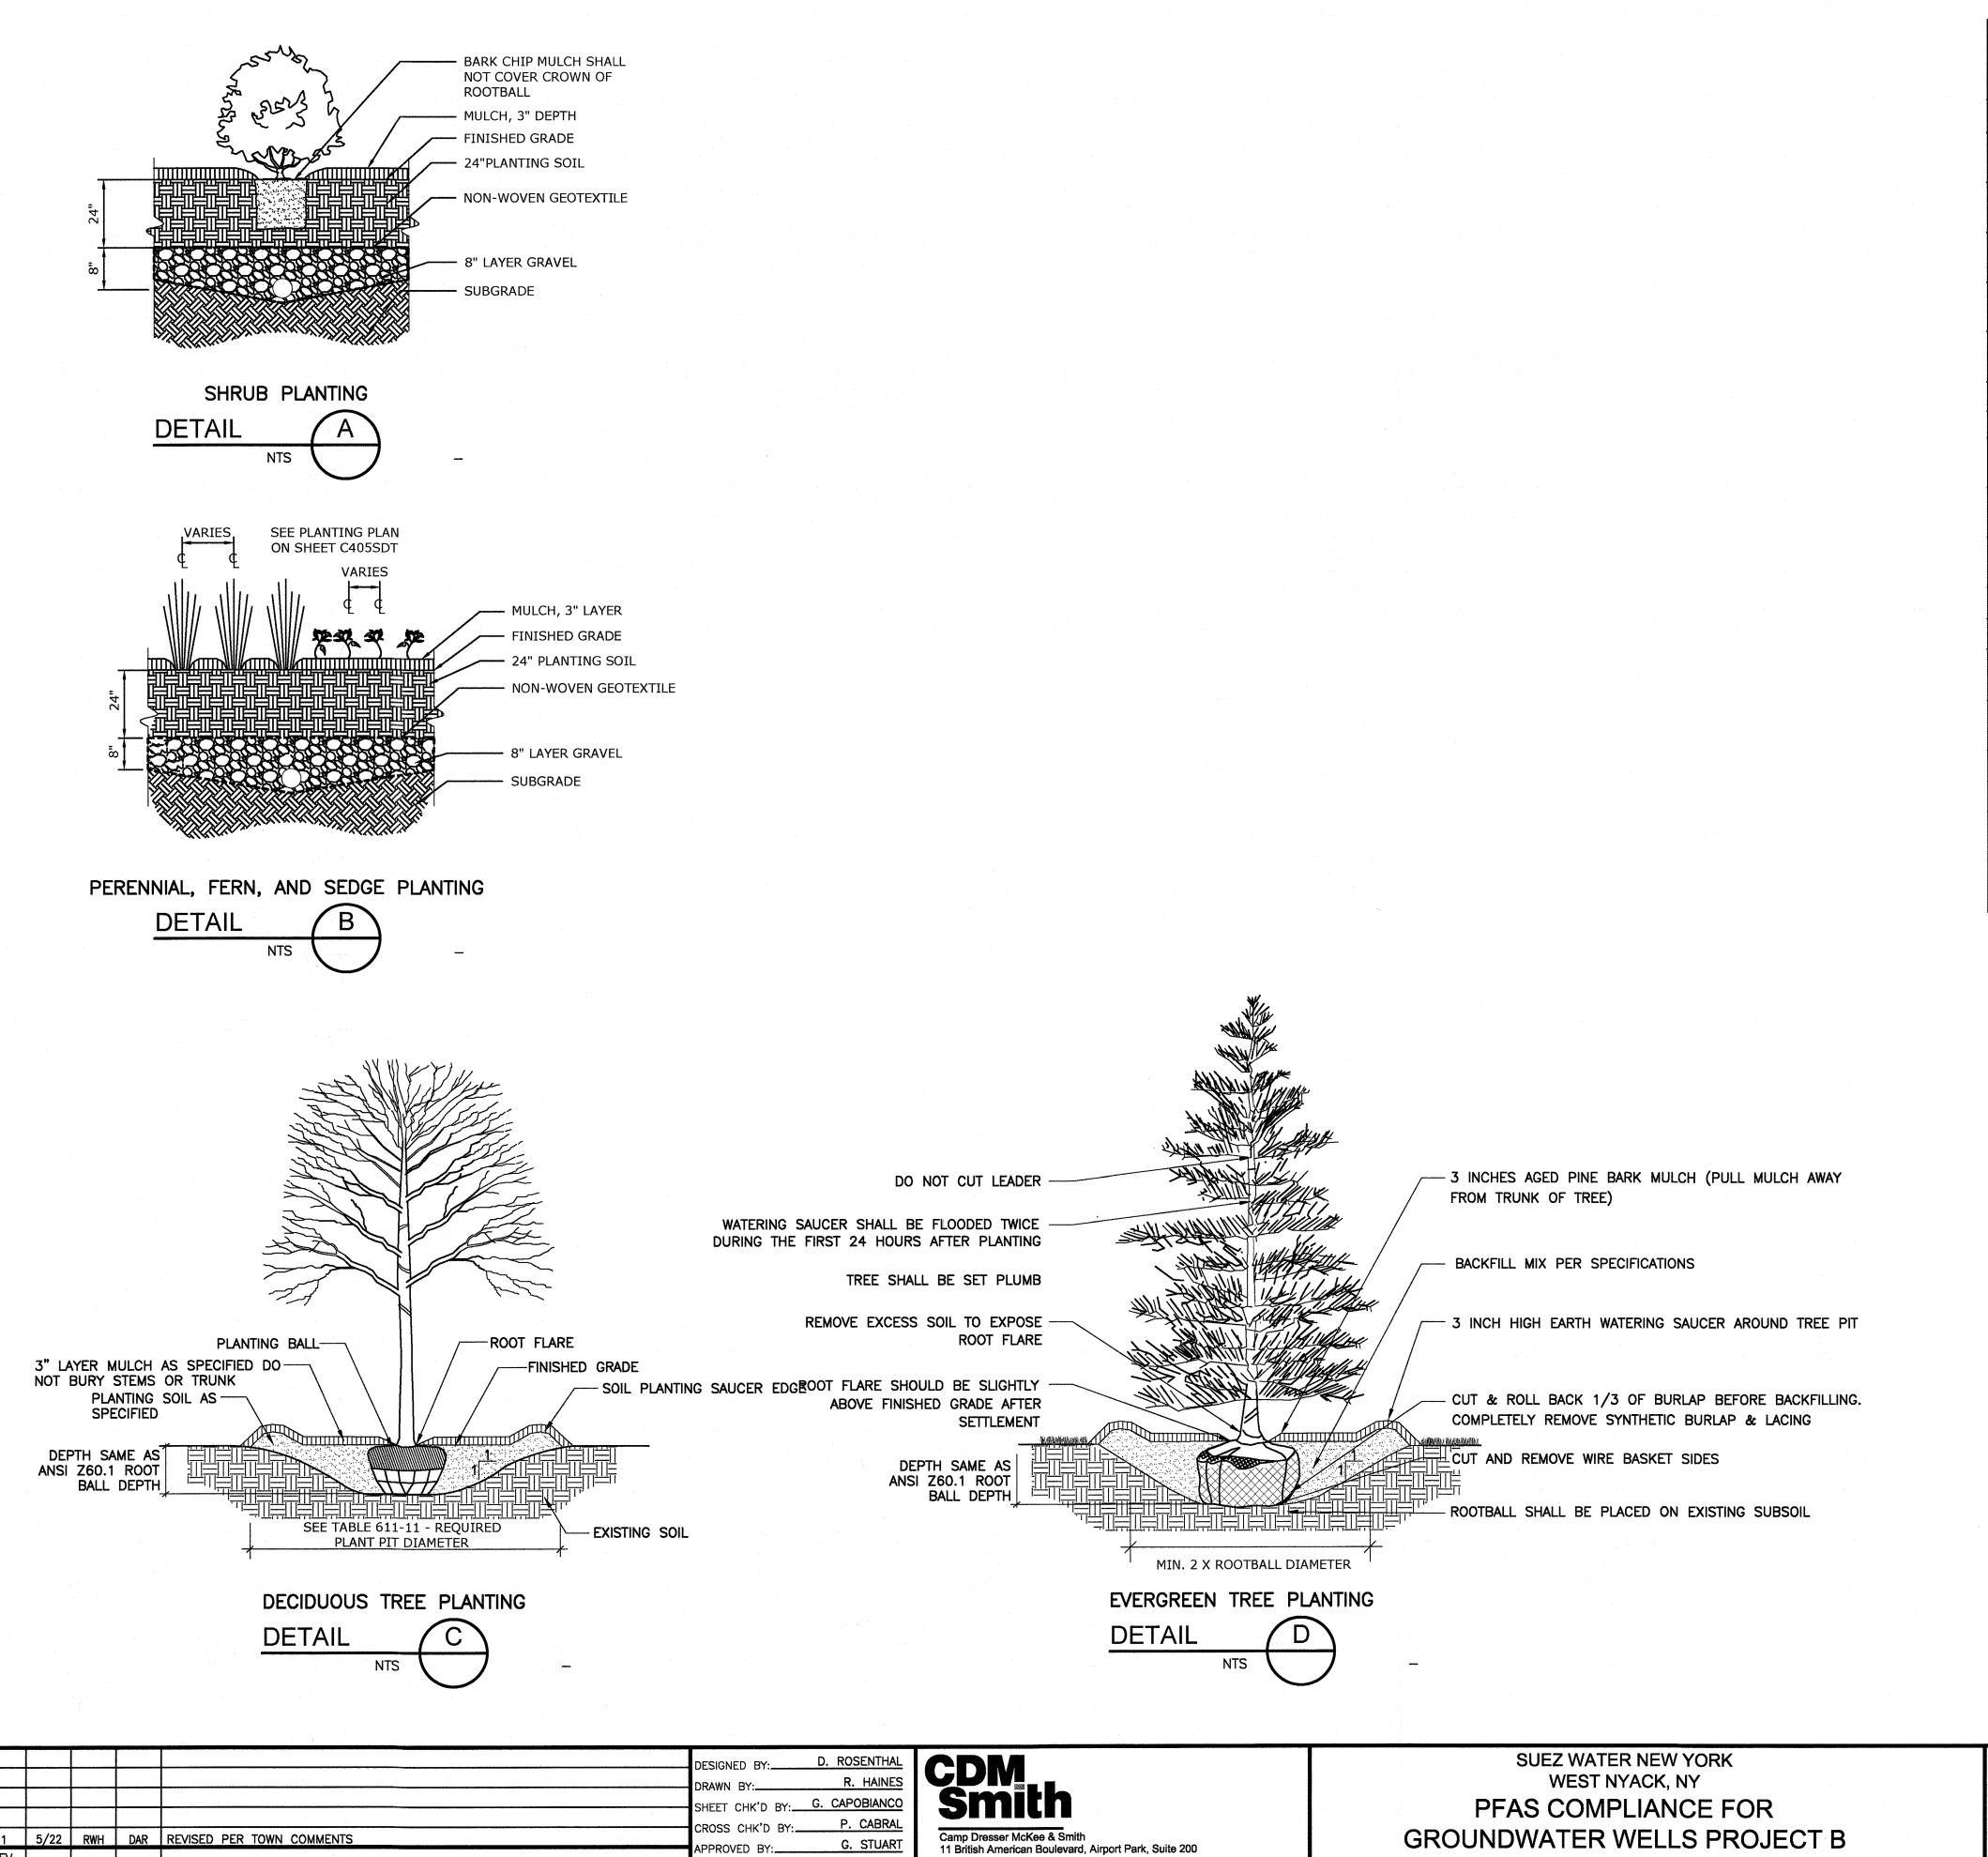
PROJECT NO. 250917-25706

FILE NAME: C404STDT.DWC

SHEET NO.

C-404





Latham, NY 12110 Tel: (518) 782-4500

SEPTEMBER 2021

DATE DRWN CHKD

REMARKS

PLANT SCHEDULE							
SHRUBS							
SYMBOL	CODE	QTY	BOTANICAL NAME	COMMON NAME	COND	SIZE	
MANAGE STATES	AV	12	ARONIA MELANOCARPA 'VIKING'	VIKING BLACK CHOKEBERRY	CONTAINER	2 GALLON	
20 20 20 20 20 20 20 20 20 20 20 20 20 2	CA	21	CLETHRA ALNIFOLIA 'HUMMINGBIRD'	FARROW ARCTIC FIRE RED TWIG DOGWOOD	CONTAINER	2 GALLON	
	cs	24	CORNUS SERICEA 'FARROW' ARCTIC FIRE	SUMMERSWEET	CONTAINER	2 GALLON	
	IG	6	ILEX GLABRA	INKBERRY	CONTAINER	5 GALLON	
	LB	6	LINDERA BENZOIN	NORTHERN SPICEBUSH	CONTAINER	5 GALLON	
PERENNIALS							
SYMBOL	CODE	QTY	BOTANICAL NAME	COMMON NAME	COND	SIZE	
***	GM	53	GERANIUM MACULATUM	WILD GERANIUM	CONTAINER	1 GALLON	
$\bigcirc$	MD	44	MONARDA DIDYMA	SCARLET BEEBALM	CONTAINER	1 GALLON	
(+)	PV	22	PHYTOSTEGIA VIRGINIANA	OBEDIENT PLANT	CONTAINER	1 GALLON	
FERNS							
SYMBOL	CODE	QTY	BOTANICAL NAME	COMMON NAME			
	os	13	ONOCLEA SENSIBILIS	SENSITIVE FERN	CONTAINER	1 GALLON	
⟨∆⟩	ос	25	OSMUNDA CLAYTONIANA	INTERRUPTED FERN	CONTAINER	1 GALLON	
SEDGES							
SYMBOL	CODE	QTY	BOTANICAL NAME	COMMON NAME			
	cs	49	CAREX STRICTA	TUSSOCK SEDGE	CONTAINER	1 GALLON	
	CV	28	CAREX VULPINOIDEA	FOX SEDGE	CONTAINER	1 GALLON	

PLANTING SCHEDULE

**DETAIL** 

GROUNDWATER WELLS PROJECT B CONTRACT NO. 15806

CIVIL PLANTINGS DETAILS II

PROJECT NO. 250917-25706 FILE NAME: C406STDT.DWG SHEET NO. C-406

B

# **GENERAL NOTES**

1. NOT ALL EQUIPMENT IS SHOWN FOR CLARITY. REFER TO THE APPROPRIATE DISCIPLINE SHEETS FOR SPECIFIC EQUIPMENT LAYOUT AND OTHER REQUIREMENTS.

2. SEE CIVIL SHEETS FOR SIDEWALK, ROAD PAVING AND FINISH GRADE ELEVATIONS.

3. SEE STRUCTURAL SHEETS FOR SIZE AND LOCATION OF CONCRETE PADS, TRENCHES, VAULTS, SUMPS, ETC.

4. SEE STRUCTURAL SHEETS FOR CONCRETE AND MASONRY REINFORCEMENT.

5. PRE-ENGINEERED METAL BUILDING (PEMB) IS A DELEGATED DESIGN ITEM, AND AS SUCH, THE MANUFACTURER SHALL PROVIDE SHOP DRAWINGS OF PEMB MAJOR AND MINOR STRUCTURE, ROOF & WALL CLADDING, ROOF INSULATION, AND ALL ASSOCIATED ATTACHMENTS AND ACCESSORIES SIGNED & SEALED BY A NYS LICENSED ENGINEER FOR EOR REVIEW & APPROVAL. THE ARCHITECTURAL DESIGN DRAWINGS SHOW PEMB ELEMENTS FOR REFERENCE & COORDINATION ONLY.

6. PATCH AND REPAIR ANY MATERIALS OR SURFACES DAMAGED DURING THE CONSTRUCTION PROCESS TO MATCH THE EXISTING ADJACENT SURFACES.

7. ALL ITEMS TO BE NEW UNLESS SPECIFICALLY NOTED OTHERWISE.

8. ALL JOINTS, VOIDS AND PENETRATIONS THROUGH FIRE-RATED WALL SYSTEMS ARE TO BE FILLED/SEALED WITH UL APPROVED FIRESAFING/FIRESTOPPING MATERIALS TO ACHIEVE THE REQUIRED FIRE-RATING (REFER TO CODE DRAWINGS FOR LOCATIONS).


9. DO NOT SCALE FROM THE DRAWINGS.

10. NOTIFY ARCHITECT IF CONSTRUCTION DOCUMENTS DIFFER FROM ACTUAL FIELD CONDITIONS PRIOR TO FABRICATION OR NEW CONSTRUCTION.

11. THIS DRAWING CONTAINS A GENERAL LIST OF SYMBOLS AND ABBREVIATIONS. NOT ALL ITEMS SHOWN HERE APPEAR ON THE CONTRACT DRAWINGS.



\c/

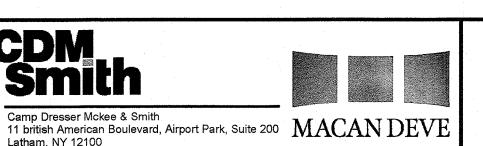

SUFFIX 1,2,3,4 IS FIRE

RESISTANCE RATING W/A



ARCHITECTURAL **GENERAL NOTES** ABBREVIATIONS AND SYMBOLS

FILE NAME: SHEET NO. A-001

250917-257061


TYPICAL DOOR LOCATION FOR

CMU WALLS

- VARIES, SEE

PARTITION TYPES

D	E	F	G/	
LIME TYPES	DIMENCIONING CYCLEM			
LINE TYPES (UNLESS OTHERWISE NOTED)	DIMENSIONING SYSTEM			
DASHED ON CONSTRUCTION PLAN/SHEETS - HIDDEN			4"3'-4"	8" 3'
ELEMENTS BEYOND, ABOVE OR BELOW			1 RO 1	M
MATERIAL SYMBOLS	COLUMN CENTERLINES	.0-	TYPICAL OFFSET TYPICAL OFFSET FROM	
EARTH	1'-	4" 3'-4" <sup>©</sup>	FROM FACE OF STUD (UON)  NOM FACE OF CMU WALL (UON)	
GRAVEL			TYPICAL DOOR LOCATION FOR STUD FRAMED WALLS	TYPICAL DOOR L CMU W
BRICK		5"4'-4 7/8"	AL DIMENSION —— DIMENSION GIVEN ——	
CONCRETE MASONRY UNIT (CMU)		G	IVEN ON PLAN  TO CENTERLINE OF  WALL (UON)	VA PA
PRECAST CONCRETE	4"	1.4 S I VCLAY	CVP PD A	Q EQ GYP BD
CAST-IN-PLACE CONCRETE		4 L ACIU/	AL DIMENSION 7 5/8" AS BUILT	
WOOD BLOCKING				
WOOD FINISH		4-0,		
PLYWOOD				
RIGID INSULATION	5'-4" 5'-0" MO		MASONRY (TYP)  MO	L STUD (TYP)
BLANKET INSULATION	A		SEE SCHEDULES	
STEEL				
ALUMINUM			ACTUAL AS BUILT MO =	
STUCCO / GROUT			NOMINAL MO ON PLAN +3/8"	
CAULK			WINDOW OR LOUVER OPENING IN PLAN	
OPENINGS				<u> </u>
USUALLY LABELED IN PLAN VIE	W; HOWEVER, OPENINGS NOT SHOWN IN PLAN ARE LABELED O	N ELEVATIONS		
D*-202A	SEQUENTIAL LETTER DESIGNATION ASSIGNED	LOUVER — SEQUENTIAL LETTER DESIGNATION ASSIGNED TO	W*-202A WINDOW — SEQUENTIAL LETTER DESIGNATION	
DESIGNATION BUILDING	TO EACH ADDITIONAL DOOR	DESIGNATION  BUILDING  ROOM NUMBER	DESIGNATION BUILDING BUILDING SEQUENTIAL LETTER DESIGNATION ASSIGNED TO EACH ADDITIONAL WINDOW	
DESIGNATION	— ROOM NUMBER 001 SUB BASEMENT 01 BASEMENT 101 FIRST FL	DESIGNATION	DESIGNATION ROOM NUMBER	
	201 SECOND FL			
SYMBOLS				
	A	ROOM NAME	NATA O	
	COLUMN TAG AND & CENTER	BUILDING DESIGNATION —	M TAG KEYNOTE CALLOUT	
	LINE	(IF APPLICABLE)	KEVNOTE DESIGNATION	

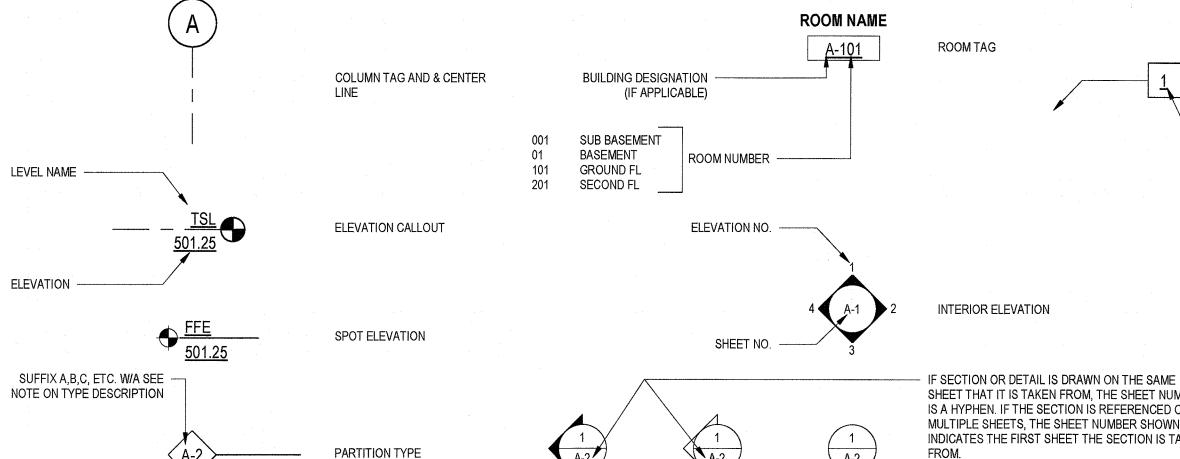

BUILDING SECTION

INDICATOR

WALL SECTION

INDICATOR

SHEET THAT IT IS TAKEN FROM, THE SHEET NUMBER IS A HYPHEN. IF THE SECTION IS REFERENCED ON A-2

DETAIL INDICATOR

MULTIPLE SHEETS, THE SHEET NUMBER SHOWN INDICATES THE FIRST SHEET THE SECTION IS TAKEN

WARNING

KEYNOTE DESIGNATION,

EACH SHEET

CORRESPONDS TO KEY ON

IT IS A VIOLATION OF THE LAW FOR ANY PERSON, UNLESS ACTING UNDER THE DIRECTION OF A LICENSED ARCHITECT, TO ALTER AN ITEM IN ANY WAY, IF AN ITEM BEARING THE SEAL OF AN ARCHITECT IS ALTERED, THE ALTERING ARCHITECT SHALL AFFIX TO HIS ITEM THE SEAL AND THE NOTATION "ALTERED BY" FOLLOWED BY HIS SIGNATURE AND THE DATE OF SUCH ALTERATION, AND A SPECIFIC DESCRIPTION OF THE ALTERATION.

PROJECT NO.

REV. NO.	DATE	DRWN	CHKD	REMARKS	DATE: SEP 2021
					APPROVED BY KS
					CROSS CHK'D BY PC
					SHEET CHK'D BY
					DRAWN BY: HK
		-			DESIGNED BY: JL

GROUNDWATER WELLS PROJECT B

AGREEMENT NO. 15806

NOTE: SEE WALL SECTIONS FOR ADDITIONAL

REQUIREMENTS

EGRESS PLAN 1/8" = 1'-0"

# GOVERNING CODES AND STANDARDS

- The new building is subject to all applicable Federal, State, and Local Codes and Standards including, but not limited to the following:

  A. 2020 Building Code of New York State (2020 NYBC; adopts with amendments 2018 IBC)

  B. 2020 Fire Code of NYS (2020 NYSFC; adopts with amendments 2018 IFC)
- 2020 New York State Energy Conservation Code (2020 NYSECC; adopts with amendments 2018 IECC)
  National Fire Protection Association Life Safety Code (NFPA 101)
- Underwriters Laboratory Inc.
- Factory Mutual Approval
- OSHA exists is to ensure safe and healthful working conditions for workers by setting and enforcing standards and by providing training, outreach, education, and assistance. OSHA is part of the United States Department of Labor. Work areas of the new building are subject to the current version of the standards:
- OSHA 29 CFR 1910-Occupational Safety and Health Standards
- SUEZ Water New York Policies and Procedures
  - THE PROPOSED BUILDINGS SHALL HAVE AN OCCUPANCY CLASSIFICATION OF U UTILITY, IN ACCORDANCE WITH THE 2020 NYBC.

# APPLICABLE STANDARDS

- INTERNATIONAL BUILDING CODE 2018
- NYS 2020 UNIFORM CODE
- NYS 2020 ENERGY CODE ANSI A117.1-2009
- NFPA 70-2014 (NATIONAL ELECTRICAL CODE)

# ACI-318-2014

### Code Compliance Summary SWNY PFAS Compliance Project B New York State Building Code

NS=BUILDING NOT SPRINKLERED, NA=NOT APPLICABLE, HR=HOURS, [F]=FIRE CODE REQUIREMENT ALSO, OL=OCCUPANCY LOAD, MAX=MAXIMUM, MIN=MINIMUM, SF=SQUARE FOOT, GSF=GROSS SQUARE FOOT

AND AREA AREA LIMITATIONS ABOVE GRADE PLANE, TABLE 2 STORIES 1 STORY	PROPOSED GAC BUILDING			CODE REFERENCE	CODE ITEM
TYPE  BUILDING HEIGHT SECTION 503 GENERAL BUILDING HEIGHT AND AREA LIMITATIONS ABOVE GRADE PLANE, TABLE  2 STORIES  1 STORY		,	GROUP U - UTILITY	SECTION 312	CLASSIFICATION
AND AREA AREA LIMITATIONS ABOVE GRADE PLANE, TABLE 2 STORIES 1 STORY			TYPE IIB	TABLE 601	
8,500 SF 1,120 SF		29'-0" HEI	2 STORIES 55'-0" HEIGHT		

TABLE 001 FIRE RESISTANCE RATINGS :	AND AREA	AREA LIMITATIONS ABOVE GRADE PLANE, TABLE 504.3, 504.4, 506.2	2 STORIES 55'-0" HEIGHT 8,500 SF	1 STORY 29'-0" HEIGHT 1,120 SF
PRIMARY STRUCTURAL FRAME		FIRE RESISTANCE RATING REQUIREME	NTS	
ELEMENTS	BUILDING	TABLE 601 FIRE RESISTANCE RATINGS :	FIRE RATII	NG (HOUR)
BEARING WALLS (EXTERIOR AND INTERIOR)	,		ALLOWED	PROPOSED
FLOOR CONSTRUCTION		PRIMARY STRUCTURAL FRAME	0	0
ROOF CONSTRUCTION   NON BEARING WALLS (INTERIOR)   O		BEARING WALLS (EXTERIOR AND INTERIOR)	0	0
NON BEARING WALLS (INTERIOR)		FLOOR CONSTRUCTION	0	0
EXTERIOR WALL	•	ROOF CONSTRUCTION	0	0
TABLE 602 FIRE SEPARATION DISTANCE (FT)   O   O		NON BEARING WALLS (INTERIOR)	0	0
ROTECTIVES		TABLE 602 FIRE SEPARATION DISTANCE (FT)	Ο	<b>O</b>
TABLE 508.4   REQUIRED   PROPOSED	OPENING	SECTION 715.4	REQUIRED	PROPOSED
SINGLE OCCUPANCY    PARAPETS   SECTION 705.11   NOT REQUIRED   PROPOSED	PROTECTIVES		None	None
PARAPETS		TABLE 508.4	REQUIRED	PROPOSED
EXCEPTIONS 1 : WALLS NOT REQUIRING FIRE RATING PER TABLE 502 FIRE SEPARATION DISTANCE   SECTION 713.3.1   REQUIRED   PROPOSED   NA   NA   NA   NA   NA   NA   NA   N	OCCUPANCIES			None
RATING PER TABLE 602 FIRE SEPARATION   CPROVIDING (PROVIDING GUARDRAILS FOR FALL PREVENTION)	PARAPETS			*
DISTANCE			NO	
PENETRAION   SECTION 713.3.1   REQUIRED   PROPOSED   NA				
PENETRAION   SECTION 713.3.1   REQUIRED   NA				I .
NA			,	PREVENTION)
CCCUPANT LOAD	PENETRAION	SECTION 713.3.1	REQUIRED	PROPOSED
CHAPTER 10			NA	NA
TABLE 1004.1.1 MAXIMUM FLOOR AREA   ALLOWANCES PER OCCUPANT:   INDUSTRIAL AREA   1100 GROSS SQUARE FOOT   1120/100=11.2   -712 OCCUPANTS   DURING MAINTENANCE SERVICE ONLY. BUILDING IS NON-OCCUPANT   36"   YES   YES		MEANS OF EGRESS REQUIREMENTS	S	
INDUSTRIAL AREA	OCCUPANT LOAD	TABLE 1004.1.1 MAXIMUM FLOOR AREA	ALLOWED	1
PROTECTIVES    1009.1 STAIRWAY   WIDTH = 36"   YES   YES		INDUSTRIAL AREA	1,120 GSF 1120/100=11.2	DURING MAINTENANCE SERVICE ONLY. BUILDING IS NON- OCCUPABLE AND
PROTECTIVES		4000 4 STAIDWAY	ALLOWED	
WHEN OCCUPANT LOAD < 50				
22" STAIR WIDTH	PROTECTIVES		YES	YES
RISER = 7" MAX, TREAD DEPTH = 11" MIN.			YES	YES
OCCUPANT LOAD < 50  EXIT ACCESS TRAVEL DISTANCE  TABLE 1006.2.1 MAXIMUM COMMON PATH OF EGRESS TRAVEL DISTANCE OCCUPANCY U, OL <30 = 100 FT  DOORS  1008.2 SIZE OF DOORS  REQUIRED PROPOSED 32" MIN 36" MIN  CORRIDOR  1018.5 NONPUBLIC AISLES SERVING <50 PEOPLE AND NOT REQUIRED TO BE ACCESSIBLE NEED NOT EXCEED 28 INCHES IN WIDTH  HANDRAIL  1012.2 HANDRAIL HEIGHT  REQUIRED PROPOSED 34" MIN, 38" MAX 34"  GUARDS  1013 GUARDS HEIGHT REQUIRED PROPOSED 42"  ACCESSIBILITY  1103.2.9 EQUIPMENT SPACES SPACES FREQUENTED ONLY BY PERSONNEL FOR MAINTENANCE, REPAIR OR MONITORING OF EQUIPMENT ARE NOT REQUIRED TO BE ACCESSIBLE. SUCH SPACES INCLUDE WATER TREATMENT			YES	YES
TRAVEL DISTANCE  EGRESS TRAVEL DISTANCE OCCUPANCY U, OL <30 = 100 FT  DOORS  1008.2 SIZE OF DOORS  1018.5 NONPUBLIC AISLES SERVING <50 PEOPLE AND NOT REQUIRED TO BE ACCESSIBLE NEED NOT EXCEED 28 INCHES IN WIDTH  HANDRAIL  1012.2 HANDRAIL HEIGHT  REQUIRED  PROPOSED  34" MIN, 38" MAX  34"  GUARDS  1013 GUARDS HEIGHT  REQUIRED  PROPOSED  42"  ACCESSIBILITY  1103.2.9 EQUIPMENT SPACES SPACES FREQUENTED ONLY BY PERSONNEL FOR MAINTENANCE, REPAIR OR MONITORING OF EQUIPMENT ARE NOT REQUIRED TO BE ACCESSIBLE. SUCH SPACES INCLUDE WATER TREATMENT	ONE EXIT		YES	YES
CORRIDOR  1018.5 NONPUBLIC AISLES SERVING <50 PEOPLE AND NOT REQUIRED TO BE ACCESSIBLE NEED NOT EXCEED 28 INCHES IN WIDTH  HANDRAIL  1012.2 HANDRAIL HEIGHT  1013 GUARDS HEIGHT  ACCESSIBILITY  1103.2.9 EQUIPMENT SPACES SPACES FREQUENTED ONLY BY PERSONNEL FOR MAINTENANCE, REPAIR OR MONITORING OF EQUIPMENT ARE NOT REQUIRED TO BE ACCESSIBLE. SUCH SPACES INCLUDE WATER TREATMENT  32" MIN 36" PREFERRED  28" MIN 36" PREFERRED  REQUIRED PROPOSED  42" 42"  NO  NO		EGRESS TRAVEL DISTANCE OCCUPANCY U,	YES	YES
CORRIDOR  1018.5 NONPUBLIC AISLES SERVING <50 PEOPLE AND NOT REQUIRED TO BE ACCESSIBLE NEED NOT EXCEED 28 INCHES IN WIDTH  1012.2 HANDRAIL HEIGHT  1013 GUARDS HEIGHT  REQUIRED PROPOSED 34" MIN, 38" MAX 34"  GUARDS  1013 GUARDS HEIGHT  REQUIRED PROPOSED 42"  42"  ACCESSIBILITY  1103.2.9 EQUIPMENT SPACES SPACES FREQUENTED ONLY BY PERSONNEL FOR MAINTENANCE, REPAIR OR MONITORING OF EQUIPMENT ARE NOT REQUIRED TO BE ACCESSIBLE. SUCH SPACES INCLUDE WATER TREATMENT	DOORS	1008.2 SIZE OF DOORS	REQUIRED	PROPOSED
AND NOT REQUIRED TO BE ACCESSIBLE NEED NOT EXCEED 28 INCHES IN WIDTH  HANDRAIL  1012.2 HANDRAIL HEIGHT  1013 GUARDS HEIGHT  ACCESSIBILITY  1103.2.9 EQUIPMENT SPACES SPACES FREQUENTED ONLY BY PERSONNEL FOR MAINTENANCE, REPAIR OR MONITORING OF EQUIPMENT ARE NOT REQUIRED TO BE ACCESSIBLE. SUCH SPACES INCLUDE WATER TREATMENT			32" MIN	36" MIN
GUARDS  1013 GUARDS HEIGHT  REQUIRED  PROPOSED  42"  ACCESSIBILITY  1103.2.9 EQUIPMENT SPACES SPACES FREQUENTED ONLY BY PERSONNEL FOR MAINTENANCE, REPAIR OR MONITORING OF EQUIPMENT ARE NOT REQUIRED TO BE ACCESSIBLE. SUCH SPACES INCLUDE WATER TREATMENT	CORRIDOR	AND NOT REQUIRED TO BE ACCESSIBLE NEED	28" MIN	36" PREFERRED
GUARDS  1013 GUARDS HEIGHT  REQUIRED PROPOSED  42"  ACCESSIBILITY  1103.2.9 EQUIPMENT SPACES SPACES FREQUENTED ONLY BY PERSONNEL FOR MAINTENANCE, REPAIR OR MONITORING OF EQUIPMENT ARE NOT REQUIRED TO BE ACCESSIBLE. SUCH SPACES INCLUDE WATER TREATMENT	HANDRAIL	1012.2 HANDRAIL HEIGHT	REQUIRED	PROPOSED
ACCESSIBILITY  1103.2.9 EQUIPMENT SPACES SPACES FREQUENTED ONLY BY PERSONNEL FOR MAINTENANCE, REPAIR OR MONITORING OF EQUIPMENT ARE NOT REQUIRED TO BE ACCESSIBLE. SUCH SPACES INCLUDE WATER TREATMENT				34"
ACCESSIBILITY  1103.2.9 EQUIPMENT SPACES SPACES FREQUENTED ONLY BY PERSONNEL FOR MAINTENANCE, REPAIR OR MONITORING OF EQUIPMENT ARE NOT REQUIRED TO BE ACCESSIBLE. SUCH SPACES INCLUDE WATER TREATMENT	GUARDS	1013 GUARDS HEIGHT		
SPACES FREQUENTED ONLY BY PERSONNEL FOR MAINTENANCE, REPAIR OR MONITORING OF EQUIPMENT ARE NOT REQUIRED TO BE ACCESSIBLE. SUCH SPACES INCLUDE WATER TREATMENT			42"	42"
SUCH SPACES INCLUDE WATER TREATMENT	ACCESSIBILITY	SPACES FREQUENTED ONLY BY PERSONNEL FOR MAINTENANCE, REPAIR OR MONITORING OF EQUIPMENT ARE NOT REQUIRED TO BE	NO *	NO
		SUCH SPACES INCLUDE WATER TREATMENT		

	LIFE SAFETY SYSTEM REQUIREMEN	TS	
EMERGENCY LIGHING	SECTION 1006 MEANS OF EGRESS ILLUMINATION 1006.1 ILLUMINATION REQUIRED	ALLOWED YES	PROPOSED YES
EXIT SIGNS	SECTION 1011 1011.1 WHERE REQUIRED	YES	YES
AUTOMATIC SPRINKLERS	903.2.11.1 ABOVE - OR BELOW - GRADE STORIES. OPENINGS ENTIRELY ABOVE THE ADJOINING GROUND LEVEL TOTALING AT LEAST 20 SF IN EACH 50 LINEAR FEET, OR FRACTION THEREOF, OF EXTERIOR WALLS FACING ONTO A STREET, PUBLIC WAY OR FRONTAGE SPACE,  903.2.11.1.3 BELOW - GRADE STORIES. WHERE ANY PORTION OF A BELOW - GRADE STORY IS LOCATED MORE THAN 75 FEET (22M 860 MM) FROM OPENINGS REQUIRED BY SECTION 903.2.11.1	NO - OPENINGS PROVIDED PER 903.2.11.1 - NO SPACES BELOW GRADE	NO
PORTABLE FIRE EXTINGUISHER	SECTION 906	YES	YES
FIRE ALARM	SECTION 907 FIRE ALARM AND DETECTION SYSTEMS OCCUPANCY GROUP U IS NOT LISTED IN THIS CODE SECTION.	NO	NO
PANIC HARDWARE	1008.1.10 PANIC AND FIRE EXIT HARDWARE	NO	NO
	STRUCTURAL AND SEISMIC DESIGN LO	DADS	
	SEE STRUCTURAL DRAWINGS		

NEW YORK STATE ENERGY CODE 2020 (EQUIPMENT BUILDING EXCEPTION UNDER EVALUATION)						
CODE REFERENCE	CLIMATE ZONE					
TABLE C402.1.3	ZONE 5	REQUIRED	PROPOSED			
ROOF	INSULATED UNDERSIDE OF ROOF DECK	R-19+R11LS	R-19+R11LS			
WALLS, ABOVE GRADE	MASS (FIRST 4'), METAL (UPPER)	R-11.4ci, R-13+13ci	R-11.4ci, R-13+13ci			
WALLS, BELOW GRADE	BELOW-GRADE WALL	R-7.5 ci	R-7.5 ci			
TABLE C402.2 VERTICAL FENESTRATION	ENTRANCE DOOR	U-0.77	U-0.77			

# C402.1.1 LOW-ENERGY BUILDINGS

THE FOLLOWING LOW-ENERGY BUILDINGS, OR PORTIONS THEREOF SEPARATED FROM THE REMAINDER OF THE BUILDING BY BUILDING THERMAL ENVELOPE ASSEMBLIES COMPLYING WITH THIS SECTION, SHALL BE EXEMPT FROM THE BUILDING THERMAL ENVELOPE PROVISIONS OF SECTION C402.


- THOSE WITH A PEAK DESIGN RATE OF ENERGY USAGE LESS THAN 3.4 BTU/H \* FT2(10.7W/M2) OR 1.0 WATT PER SQUARE FOOT (10.7 W/M2) OF FLOOR AREA FOR SPACE CONDITIONING
- THOSE THAT DO NOT CONTAIN CONDITIONED SPACE.
- GREENHOUSES.



# WARNING

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ı		_				DESIGNED BY: JL	1
Ì		-				DRAWN BY: HK	М
1						SHEET CHK'D BY: JL	
ı						CROSS CHK'D BY PC	l
ı						APPROVED BY: KS	l
r	REV. NO.	DATE	DRWN	CHKD	REMARKS	DATE: SEP 2021	

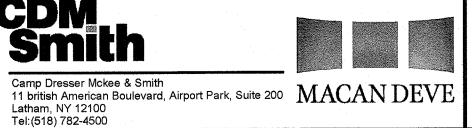

SUEZ WATER NEW YORK INC. WEST NYACK, NY


PFAS COMPLIANCE FOR GROUNDWATER WELLS PROJECT B AGREEMENT NO. 15806


ARCHITECTURAL


CODE COMPLIANCE AND EGRESS PLAN **TAPPAN** 


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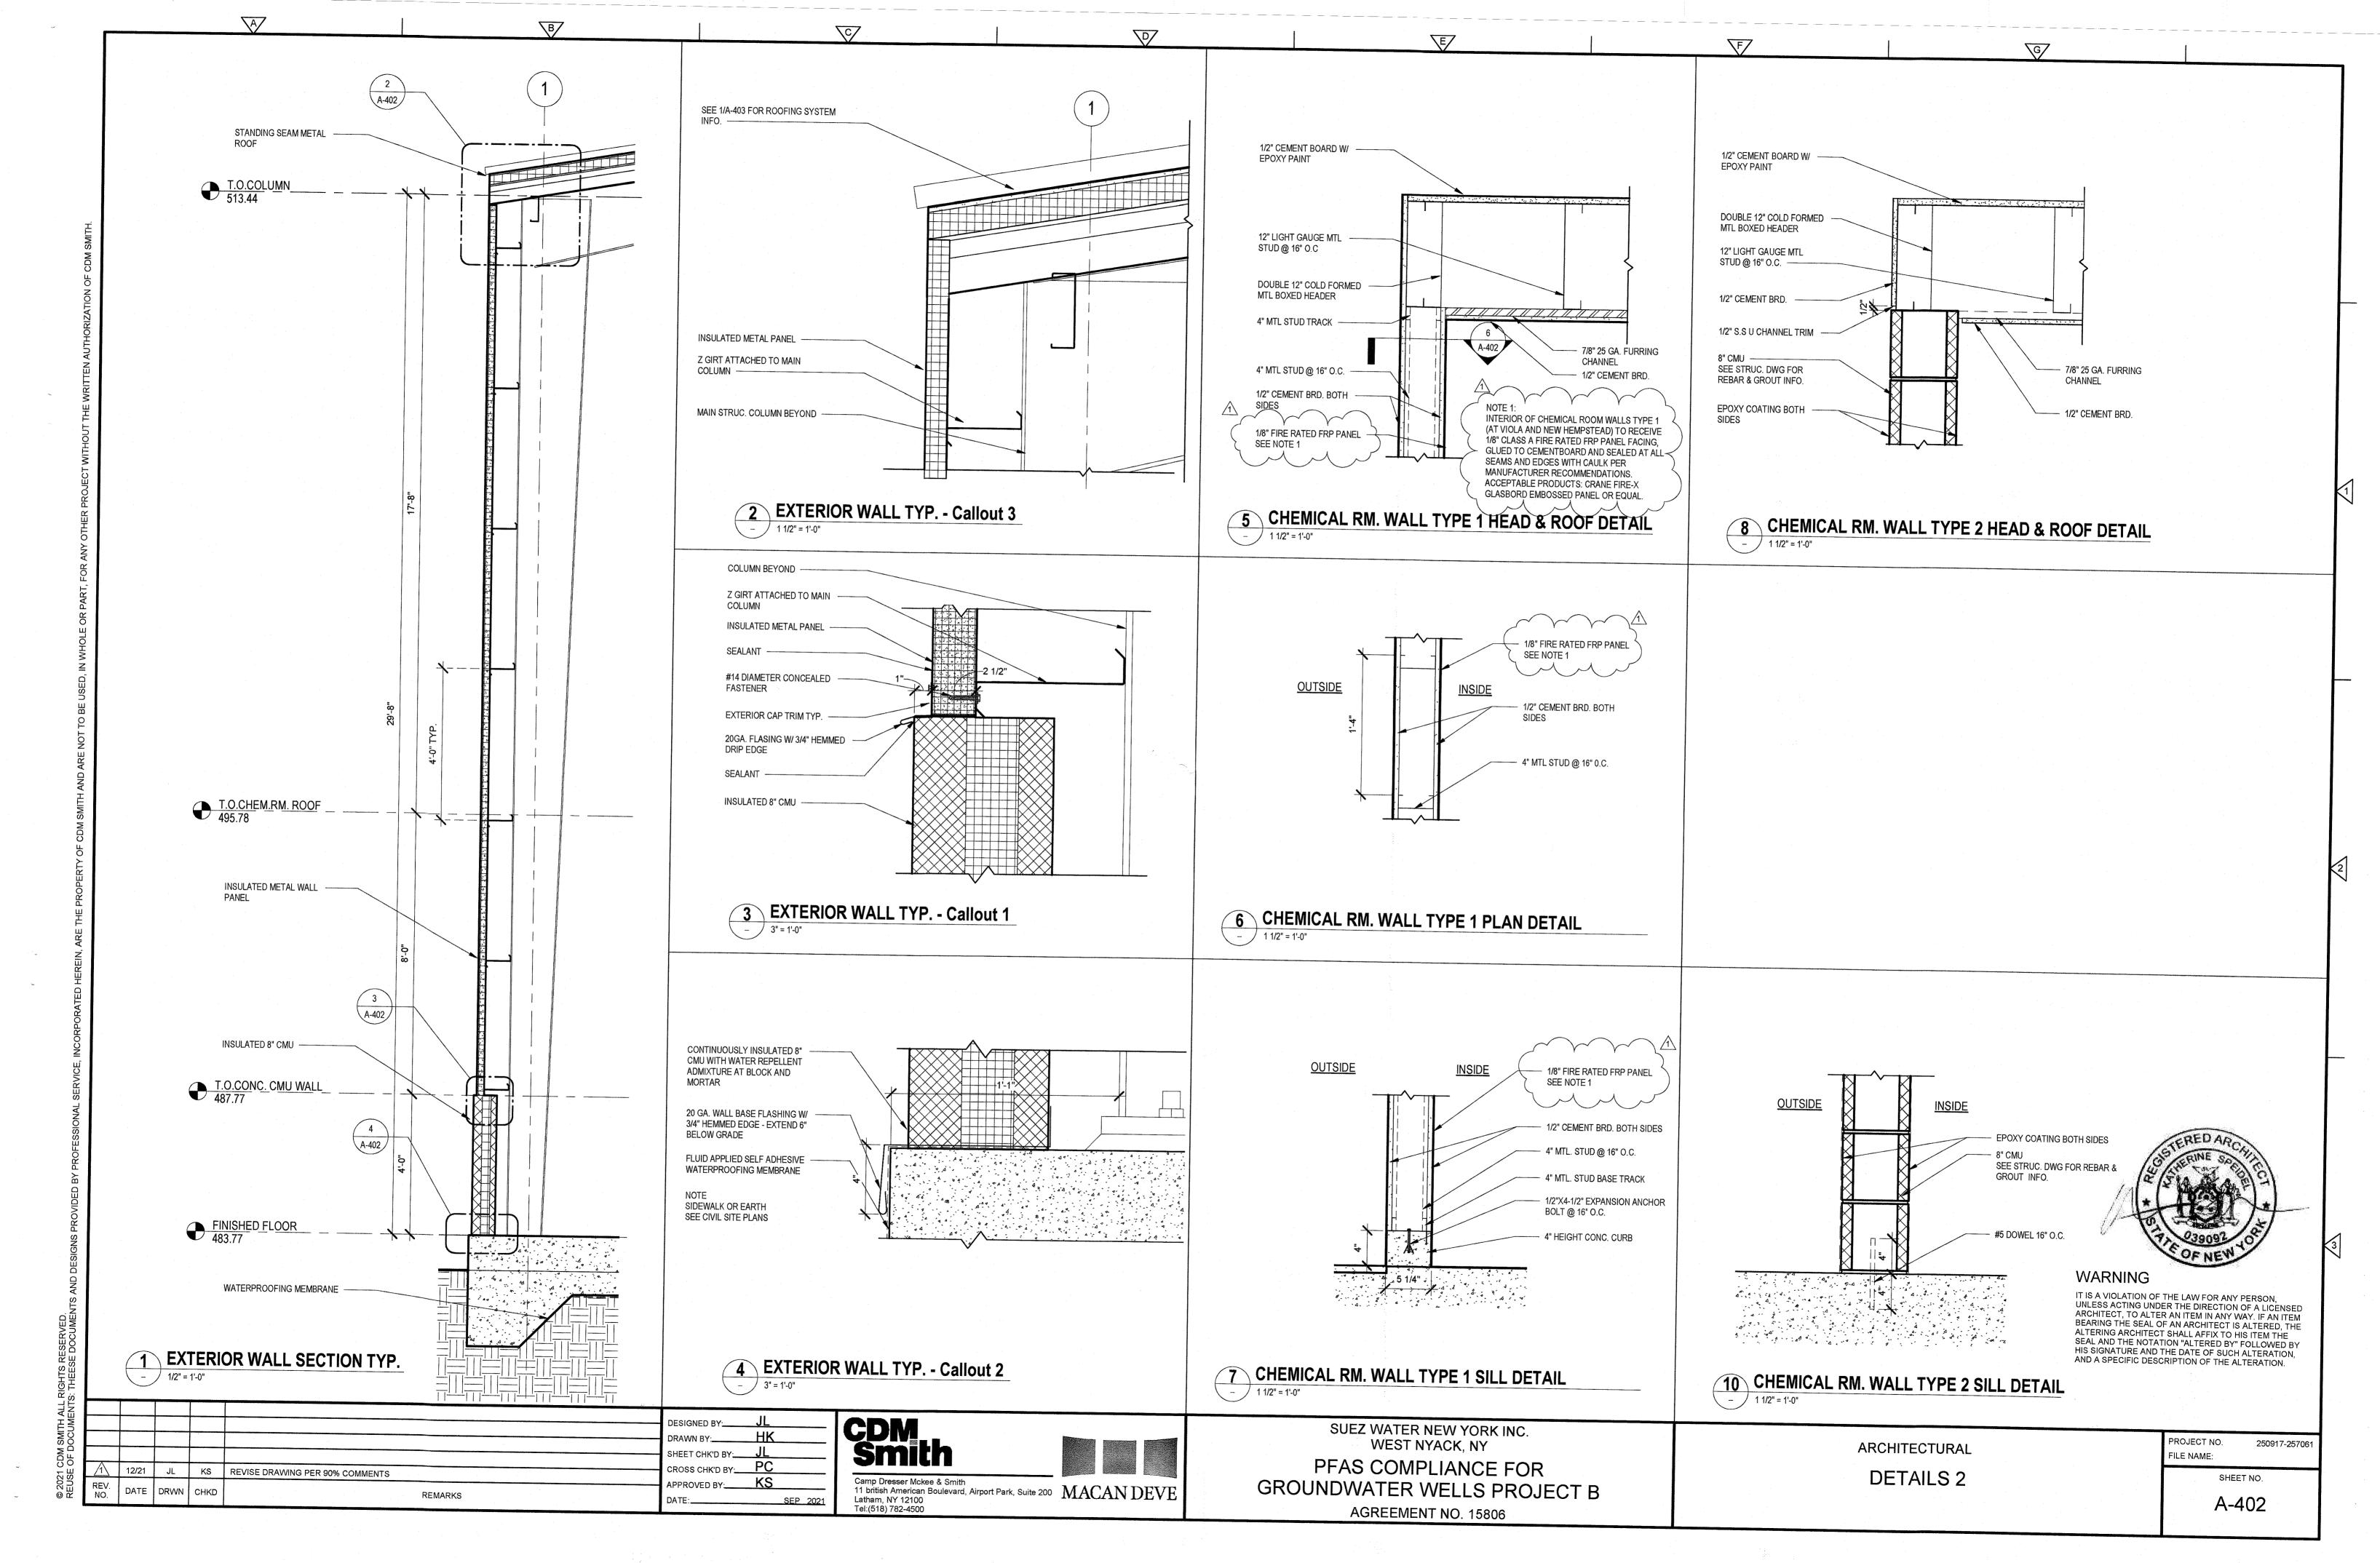
> SHEET NO. A-201




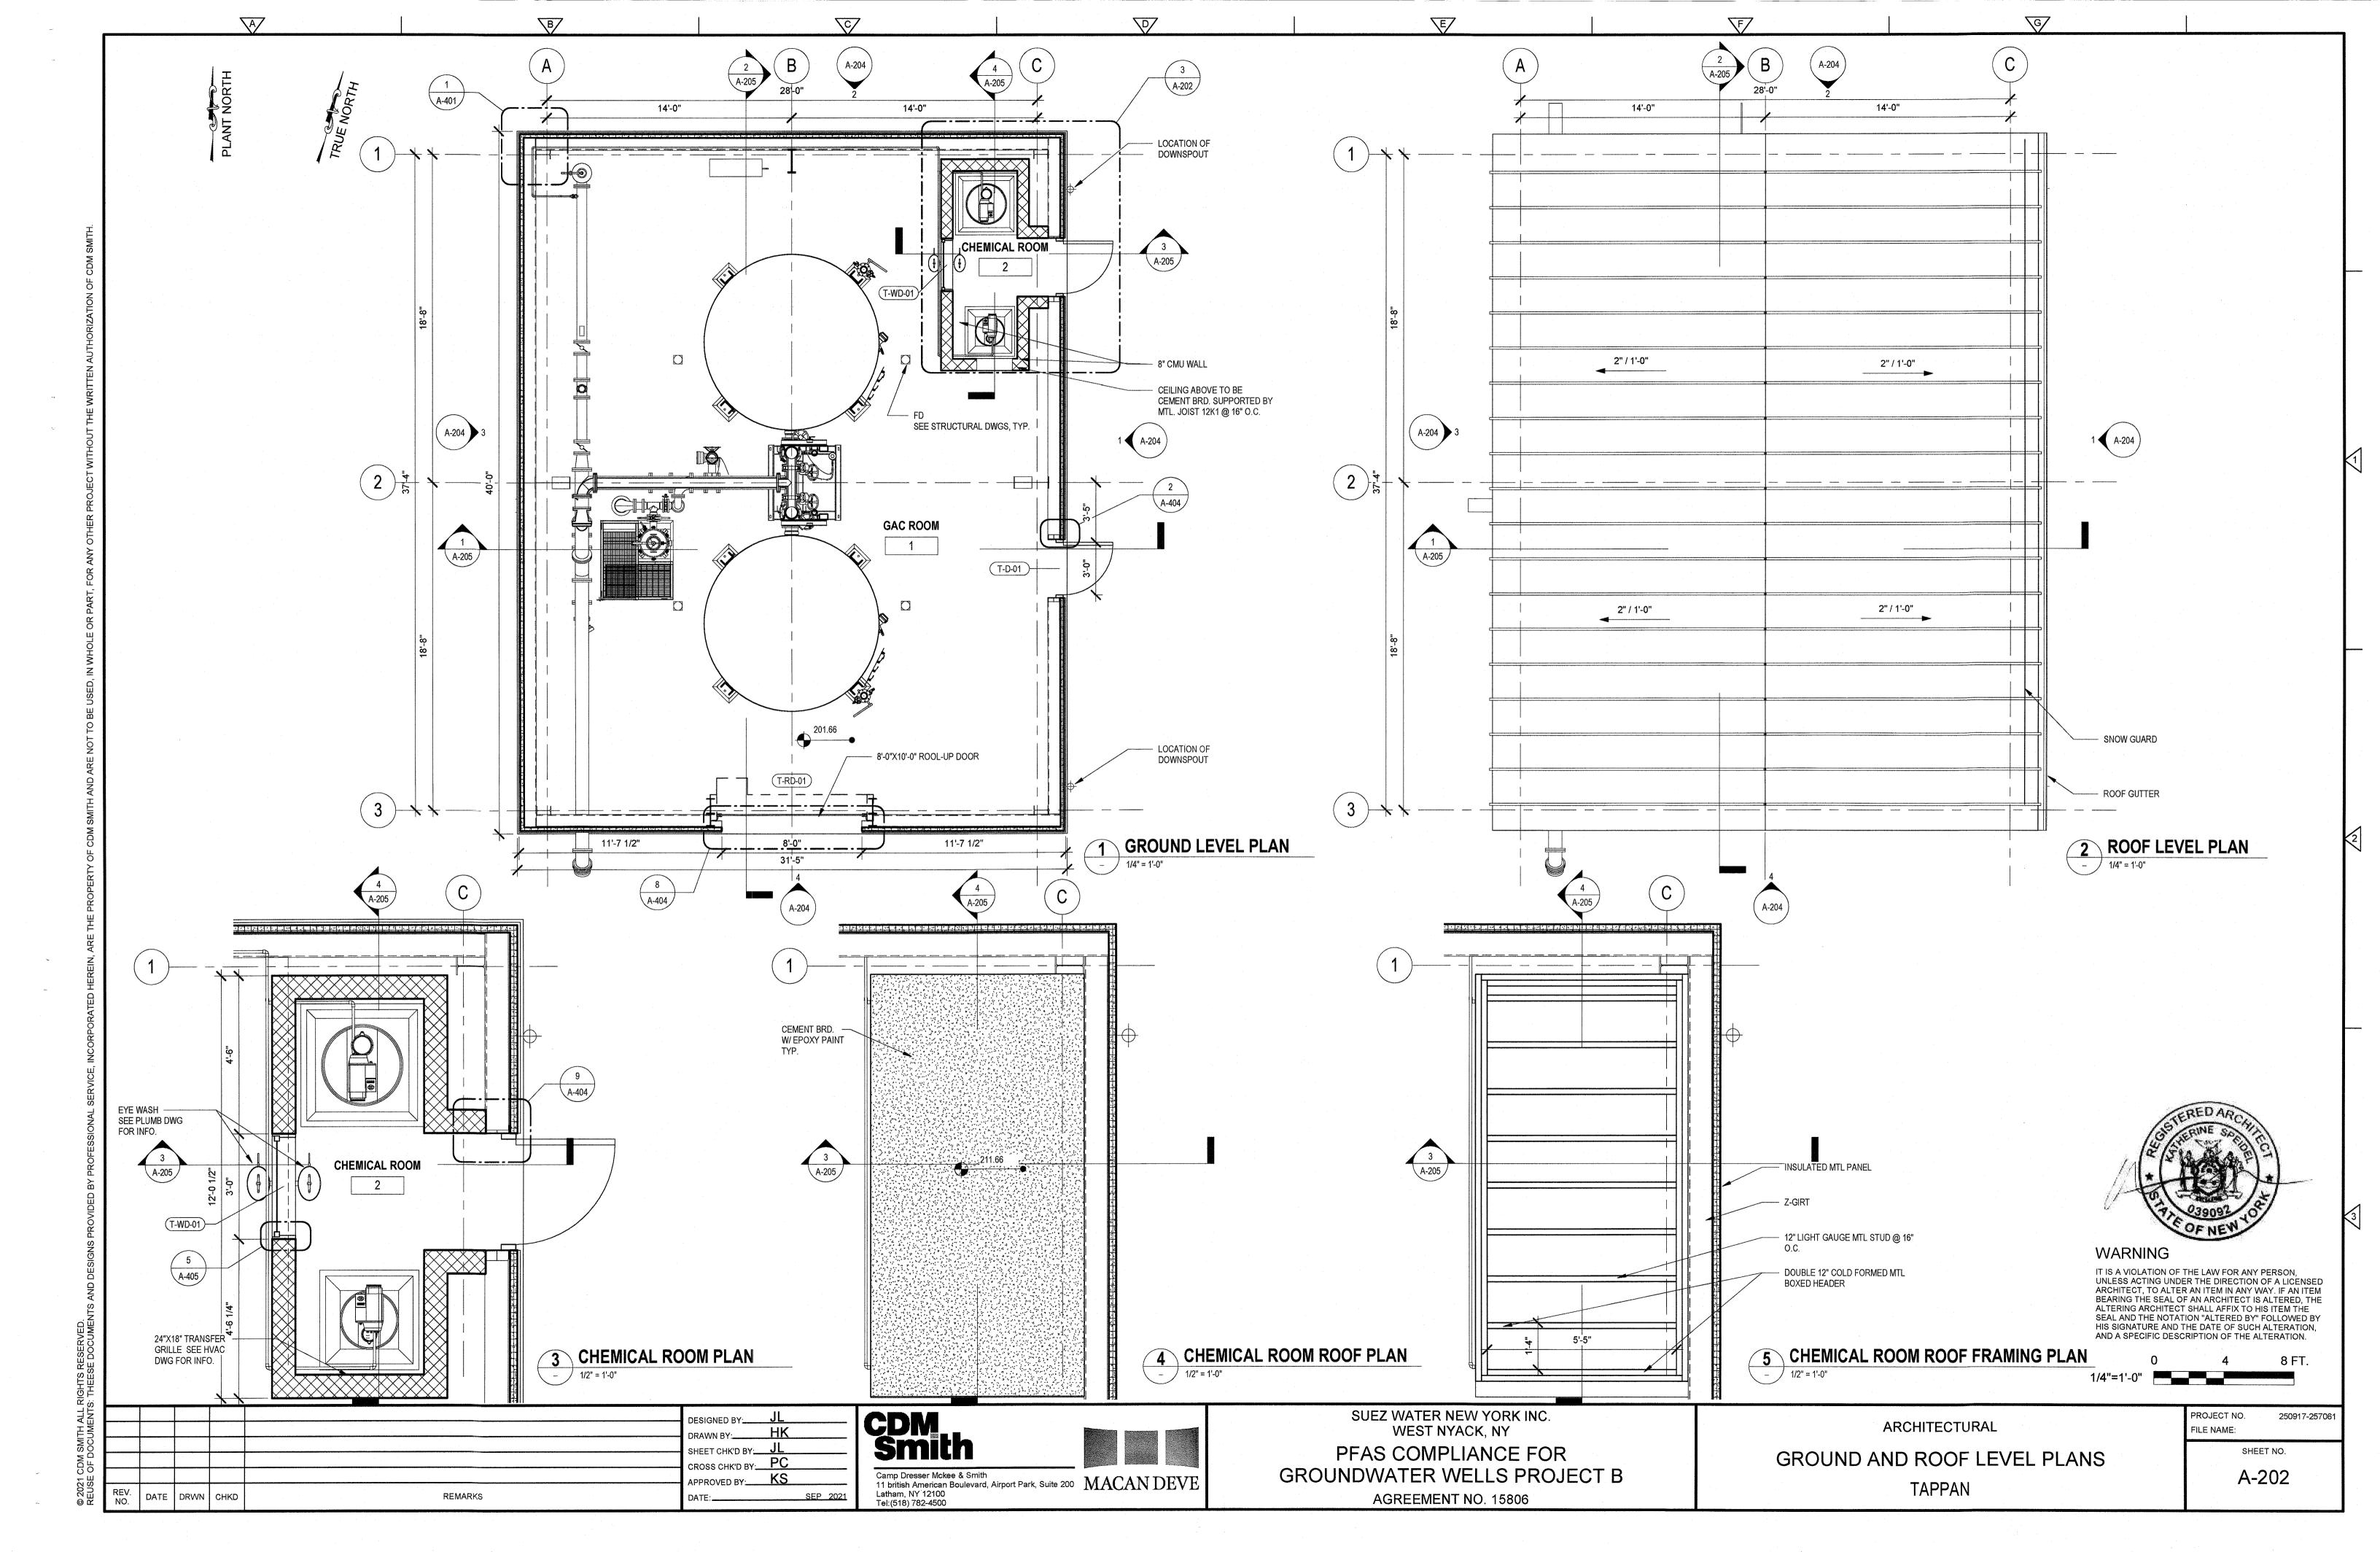


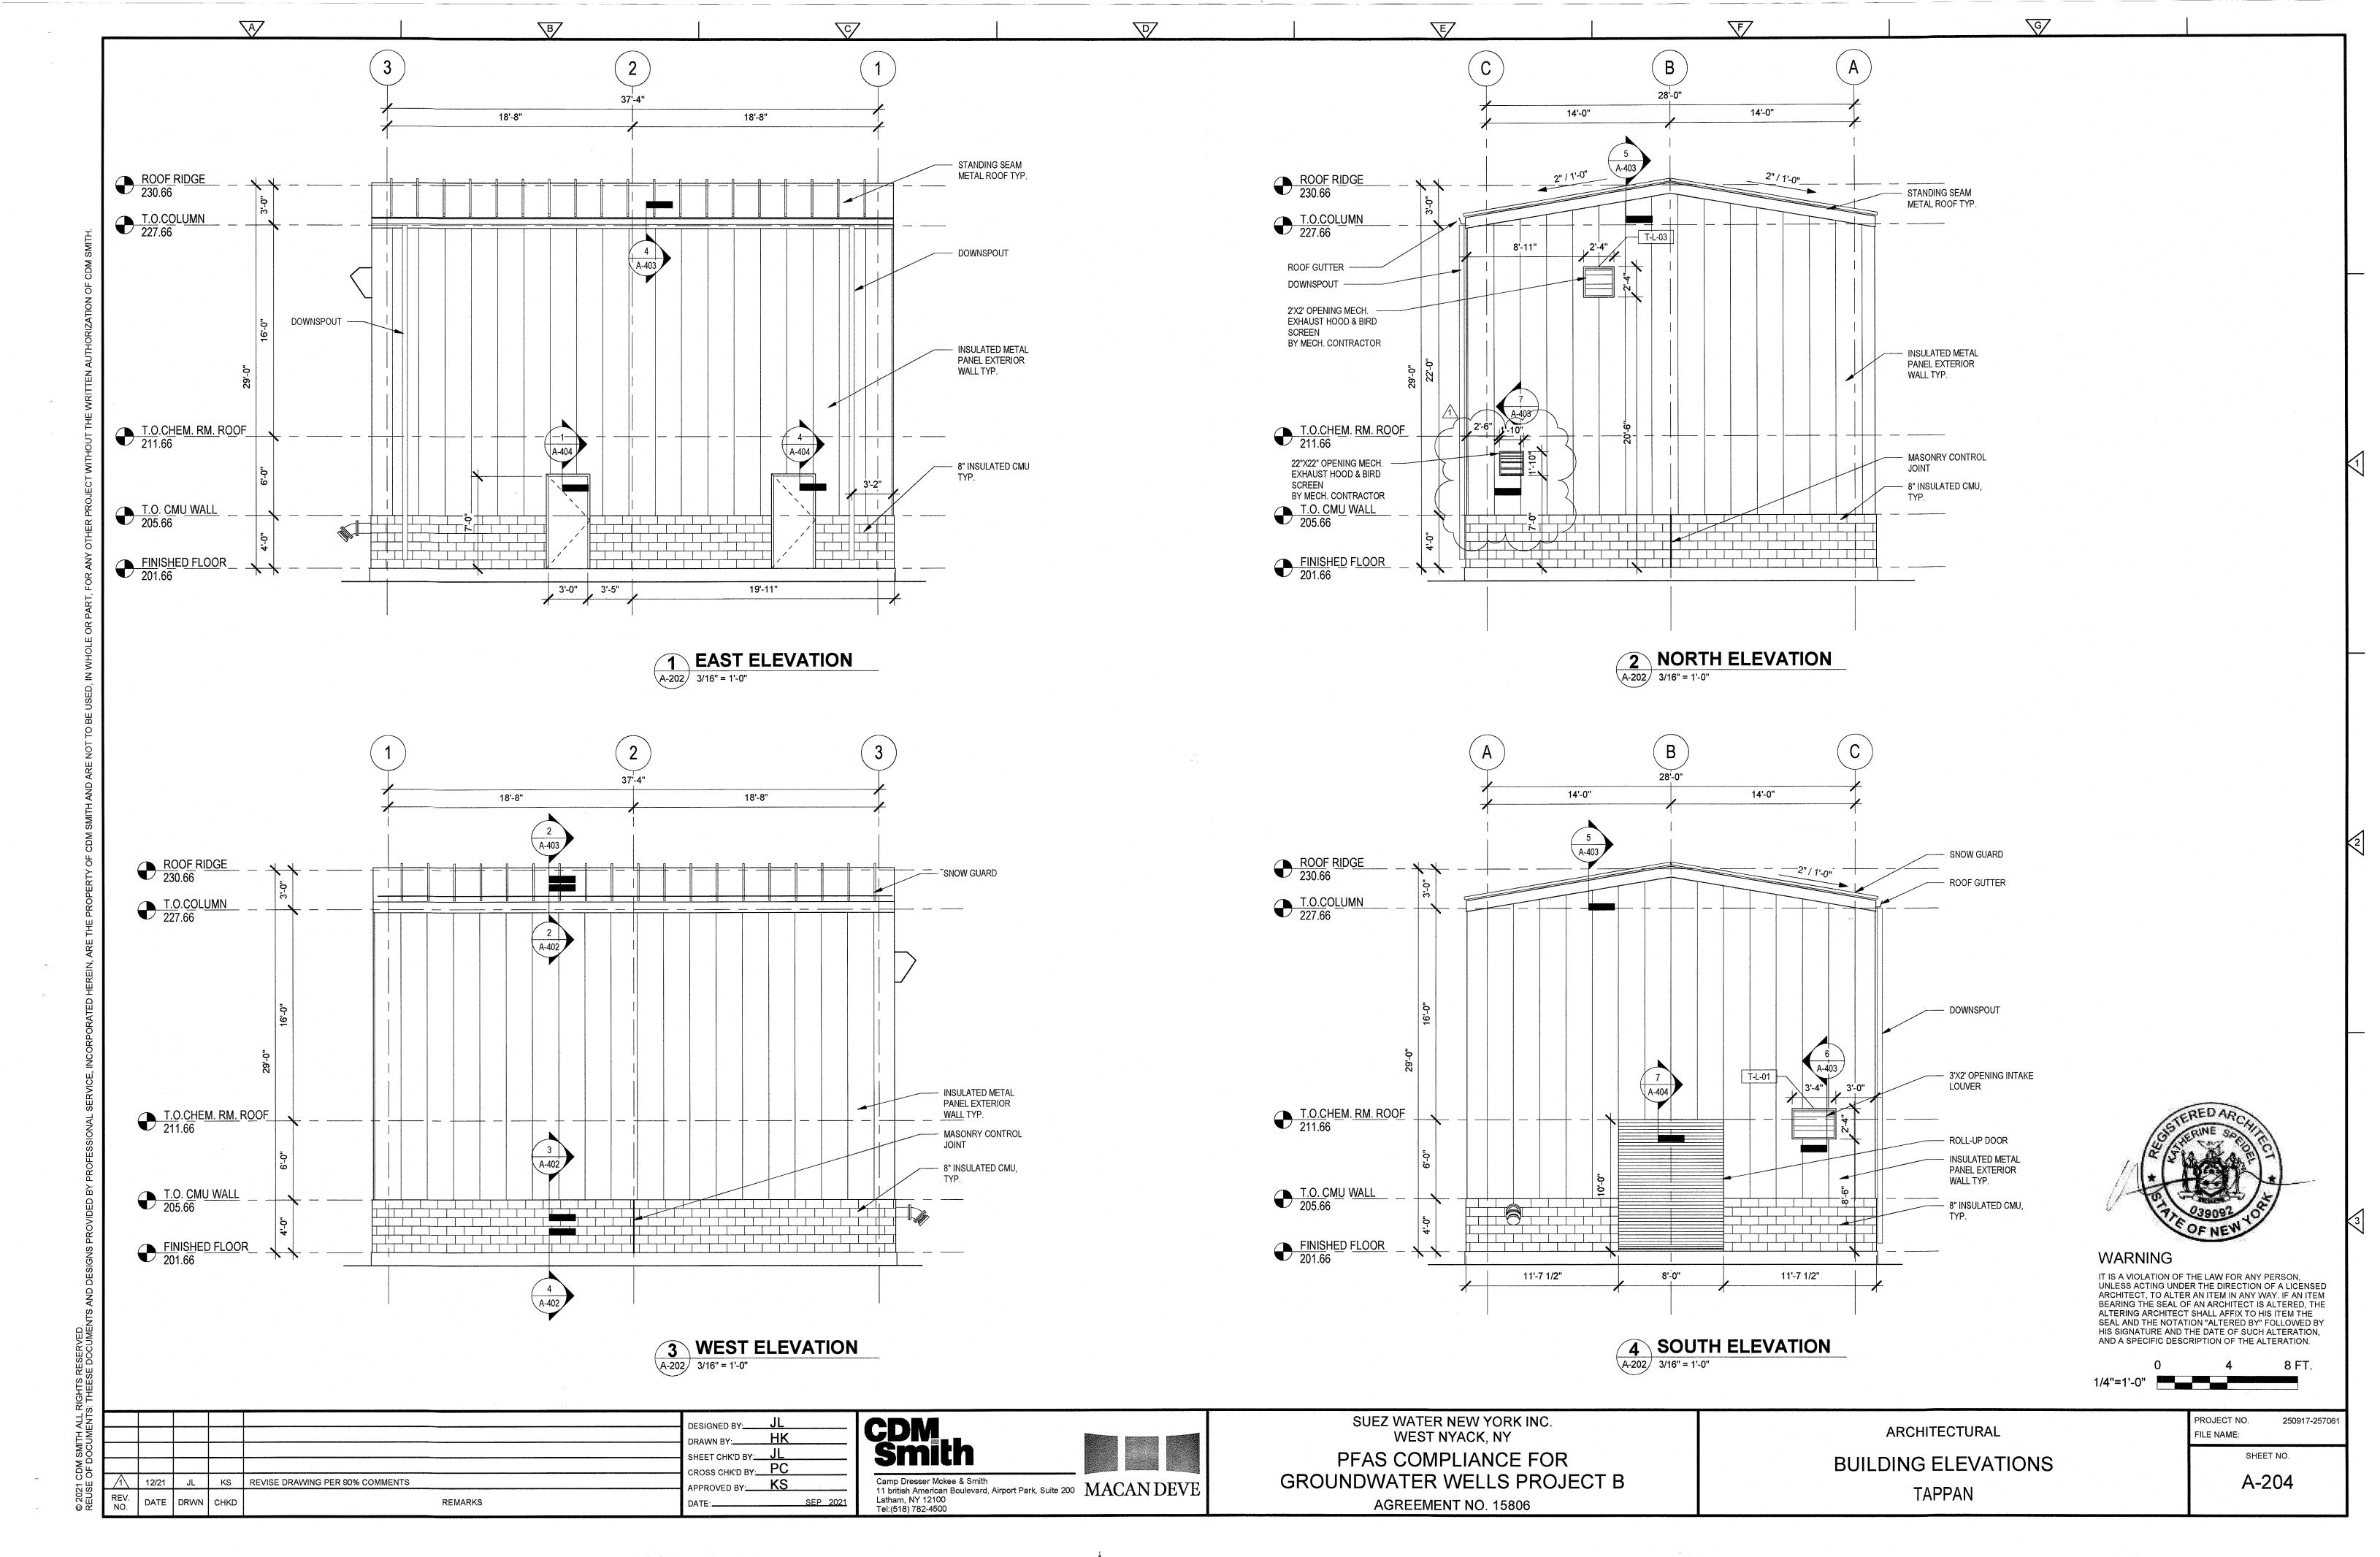


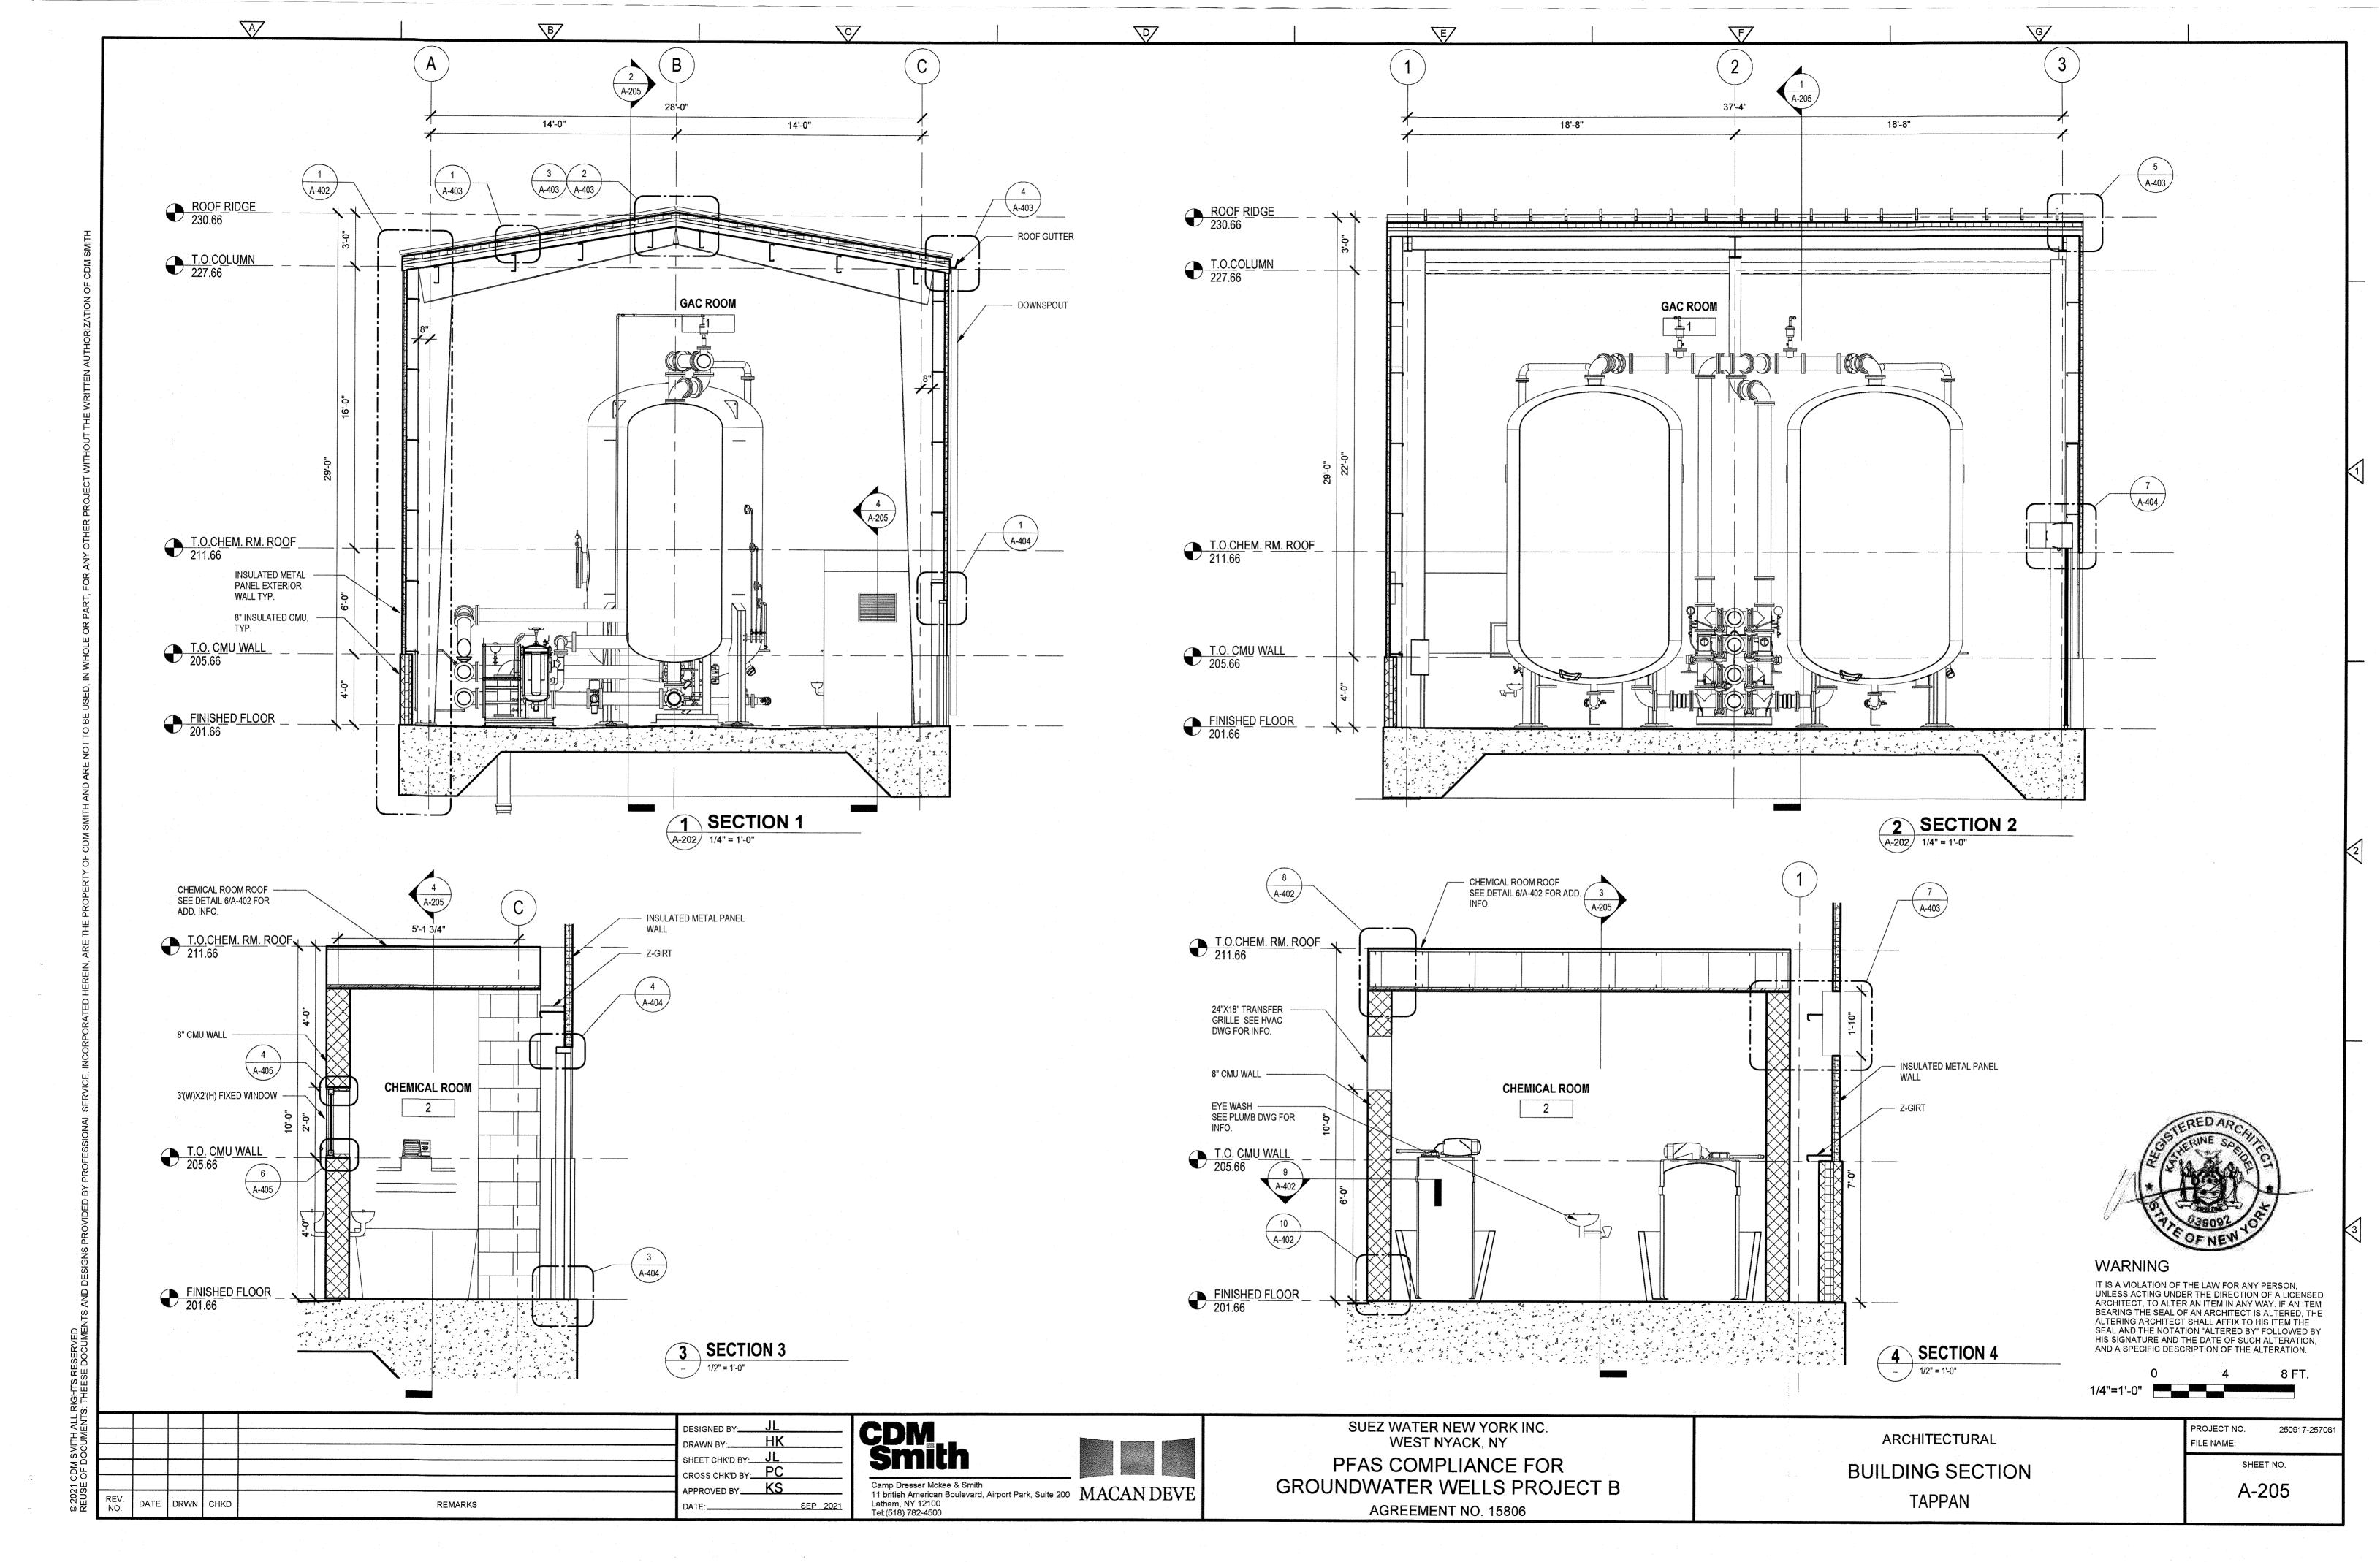

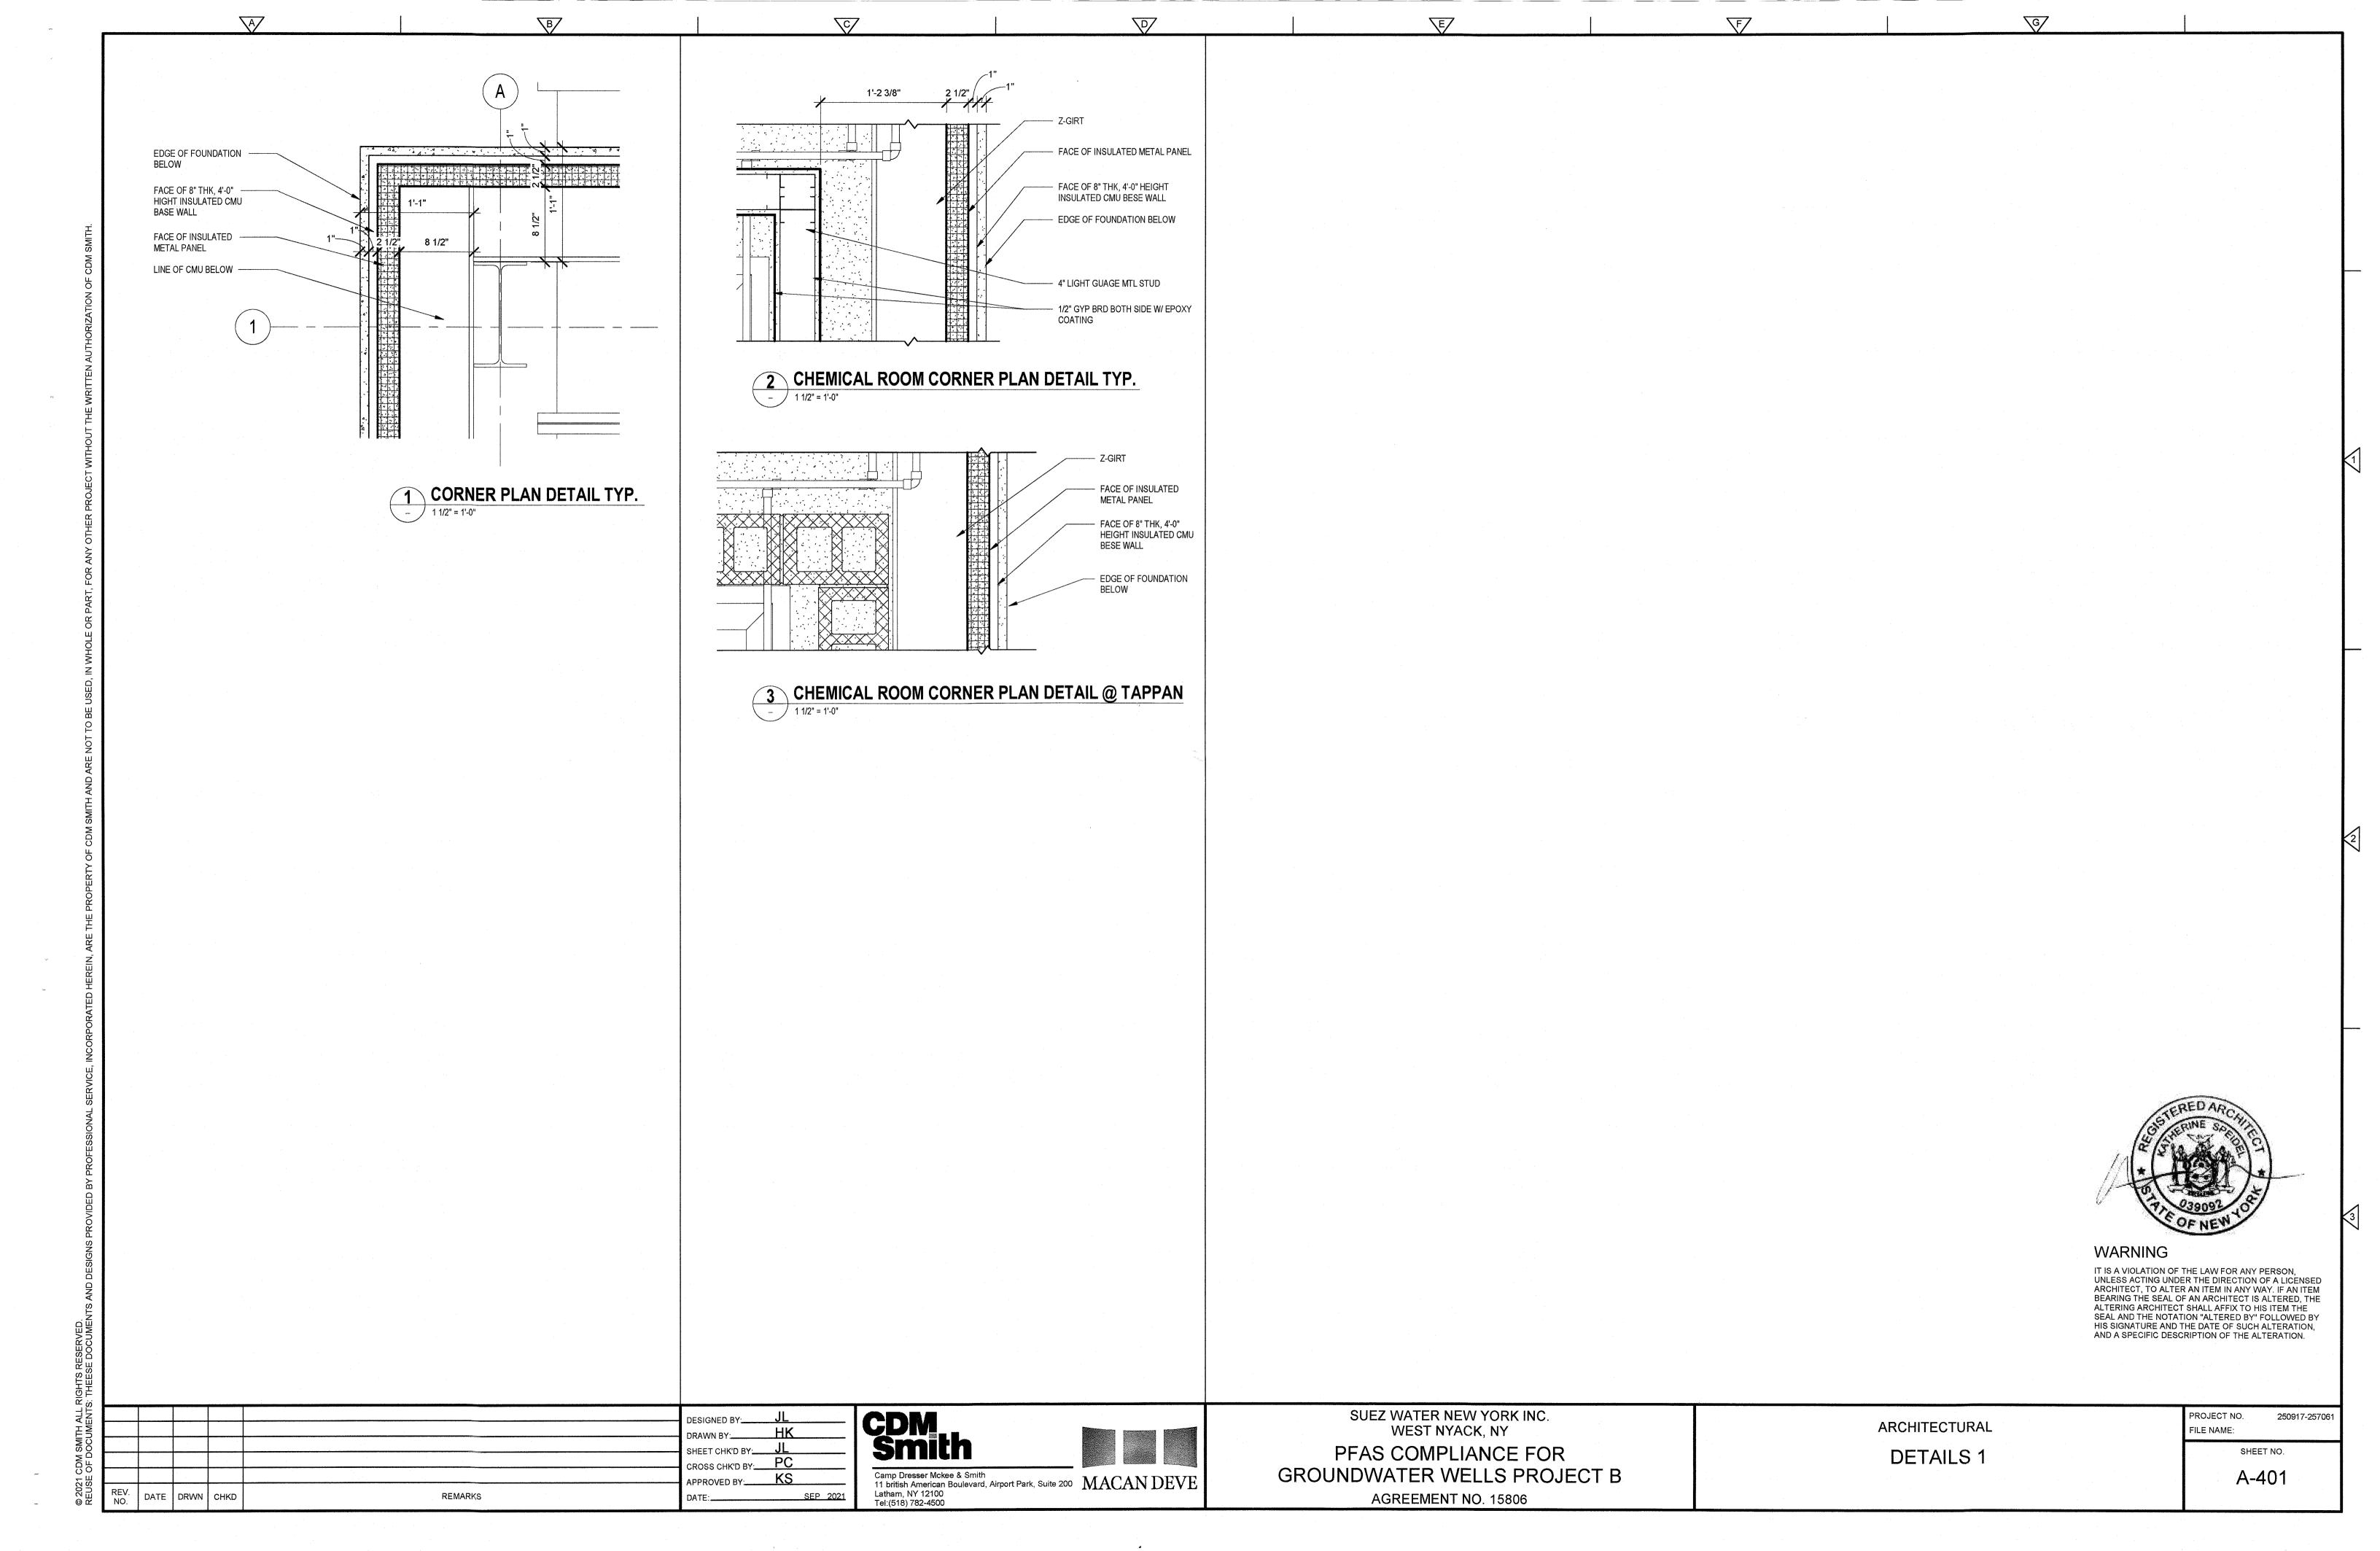

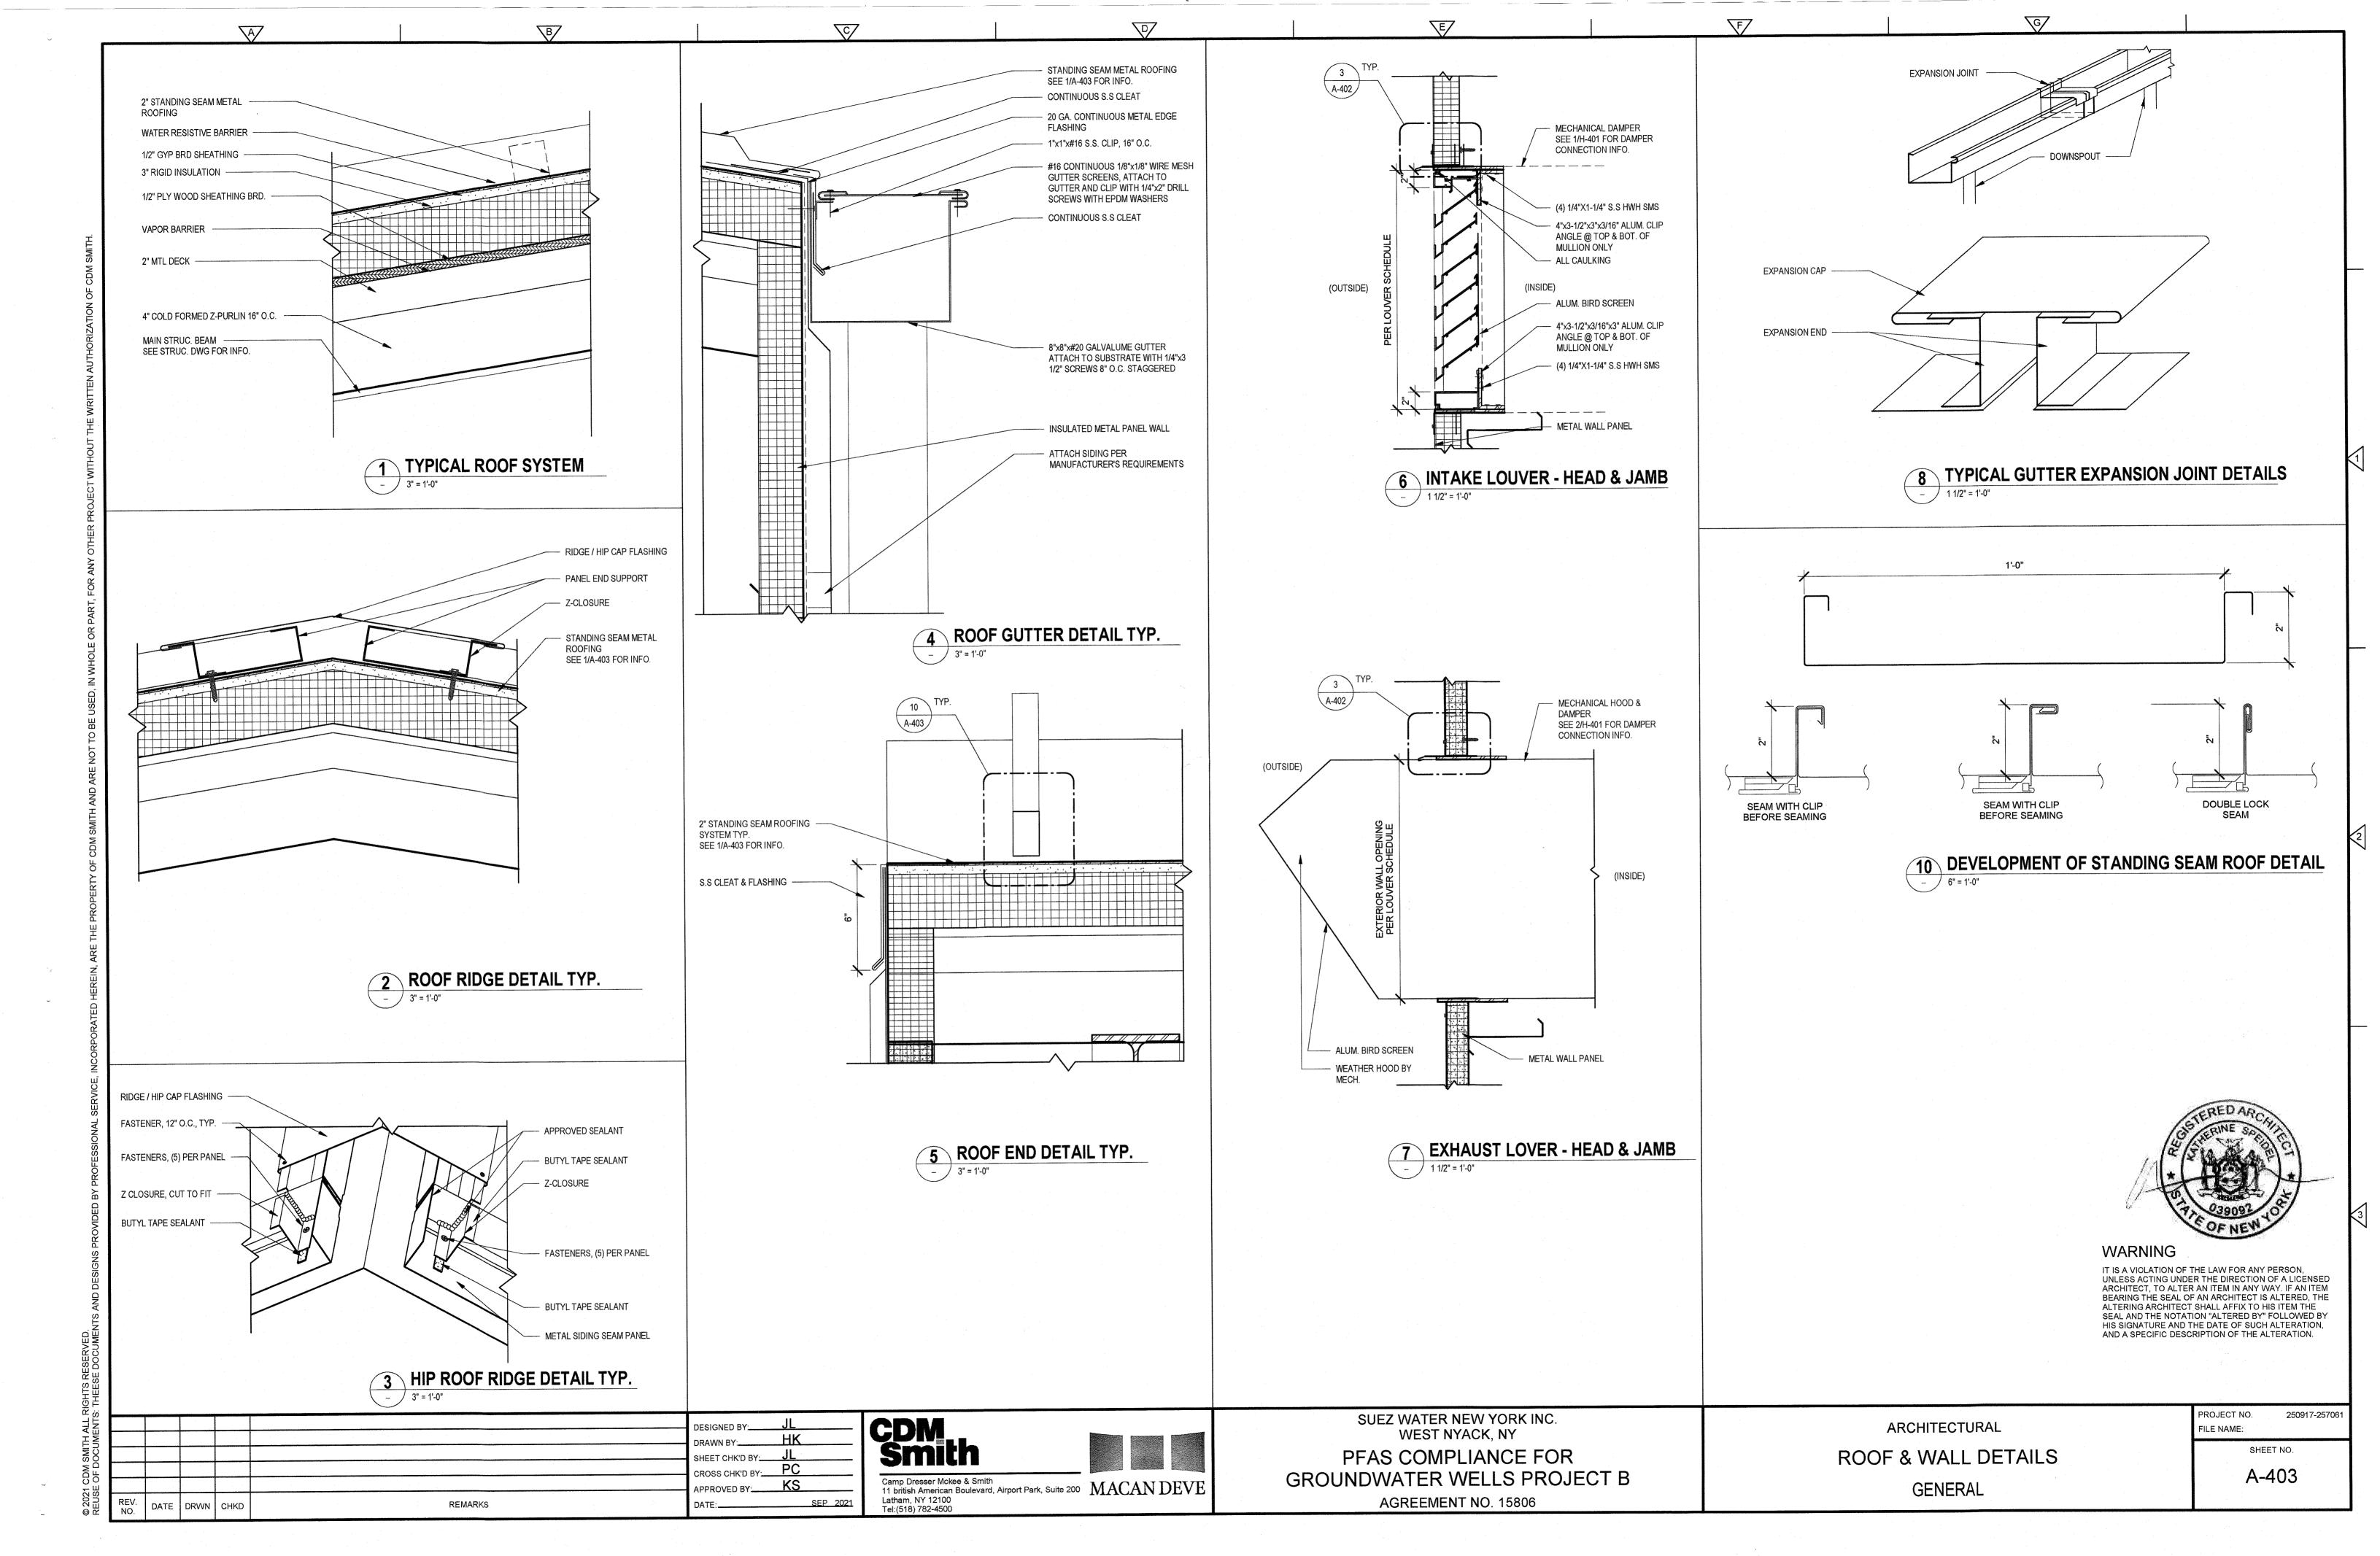

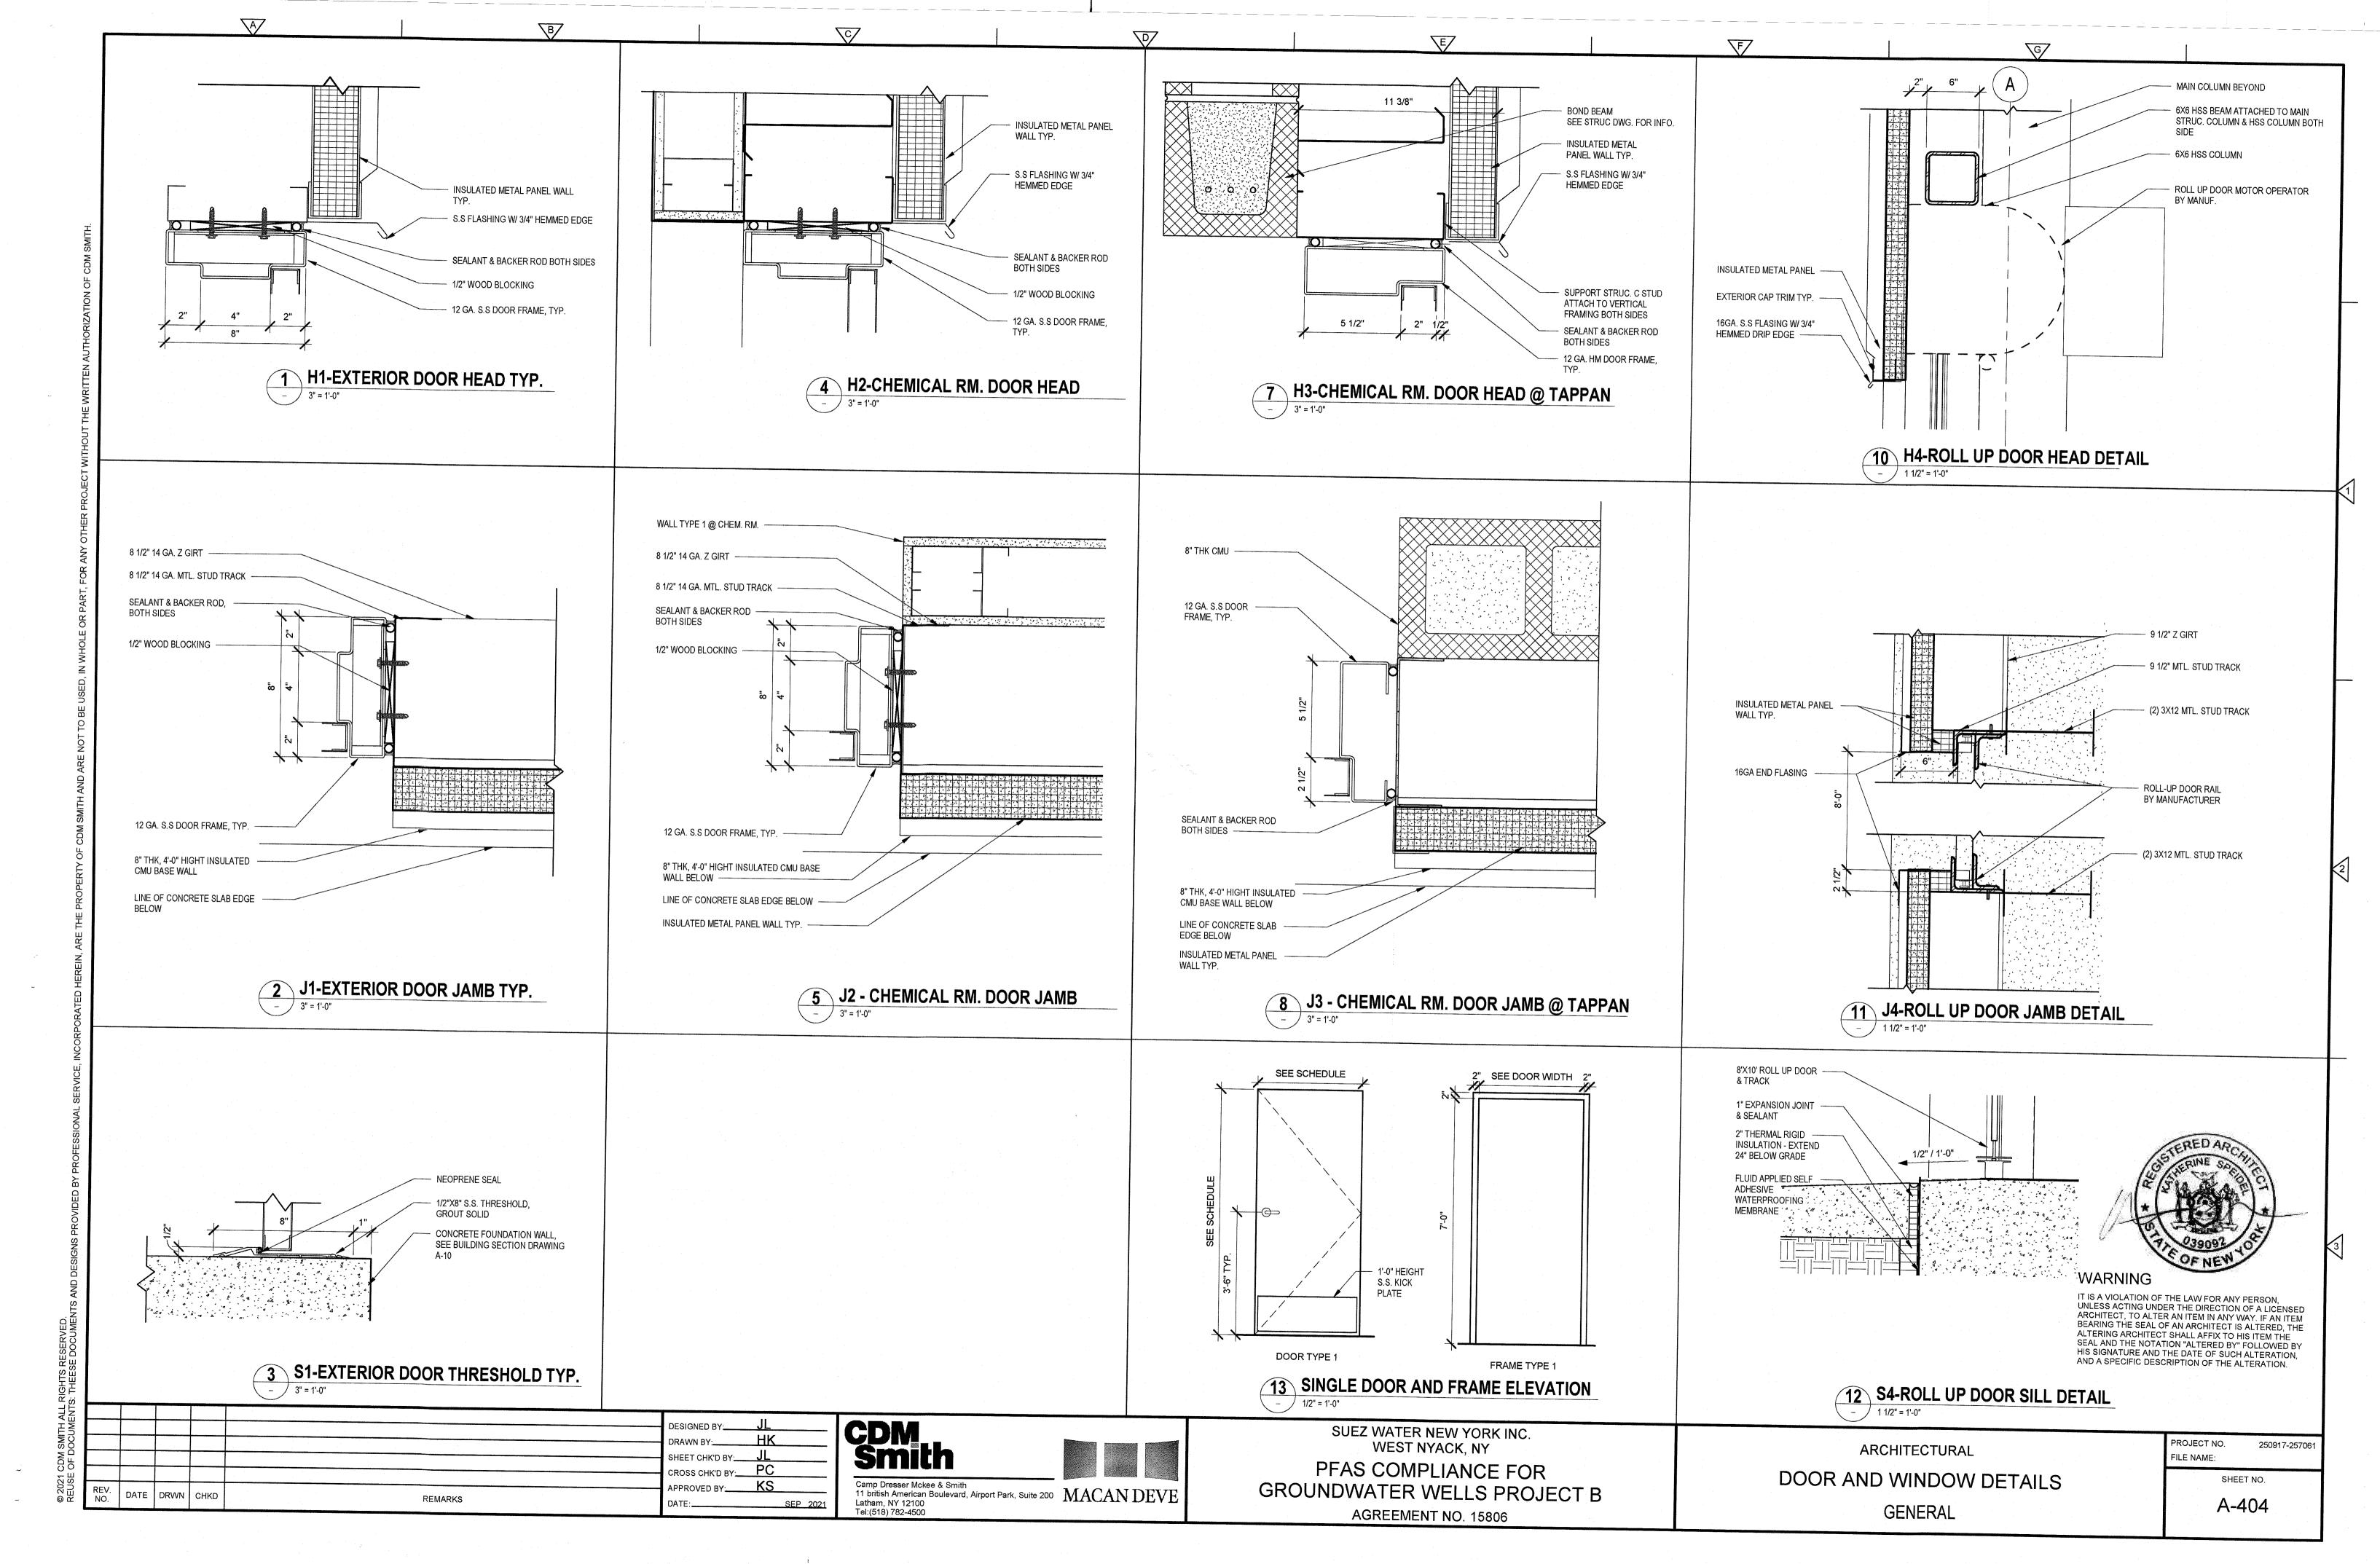

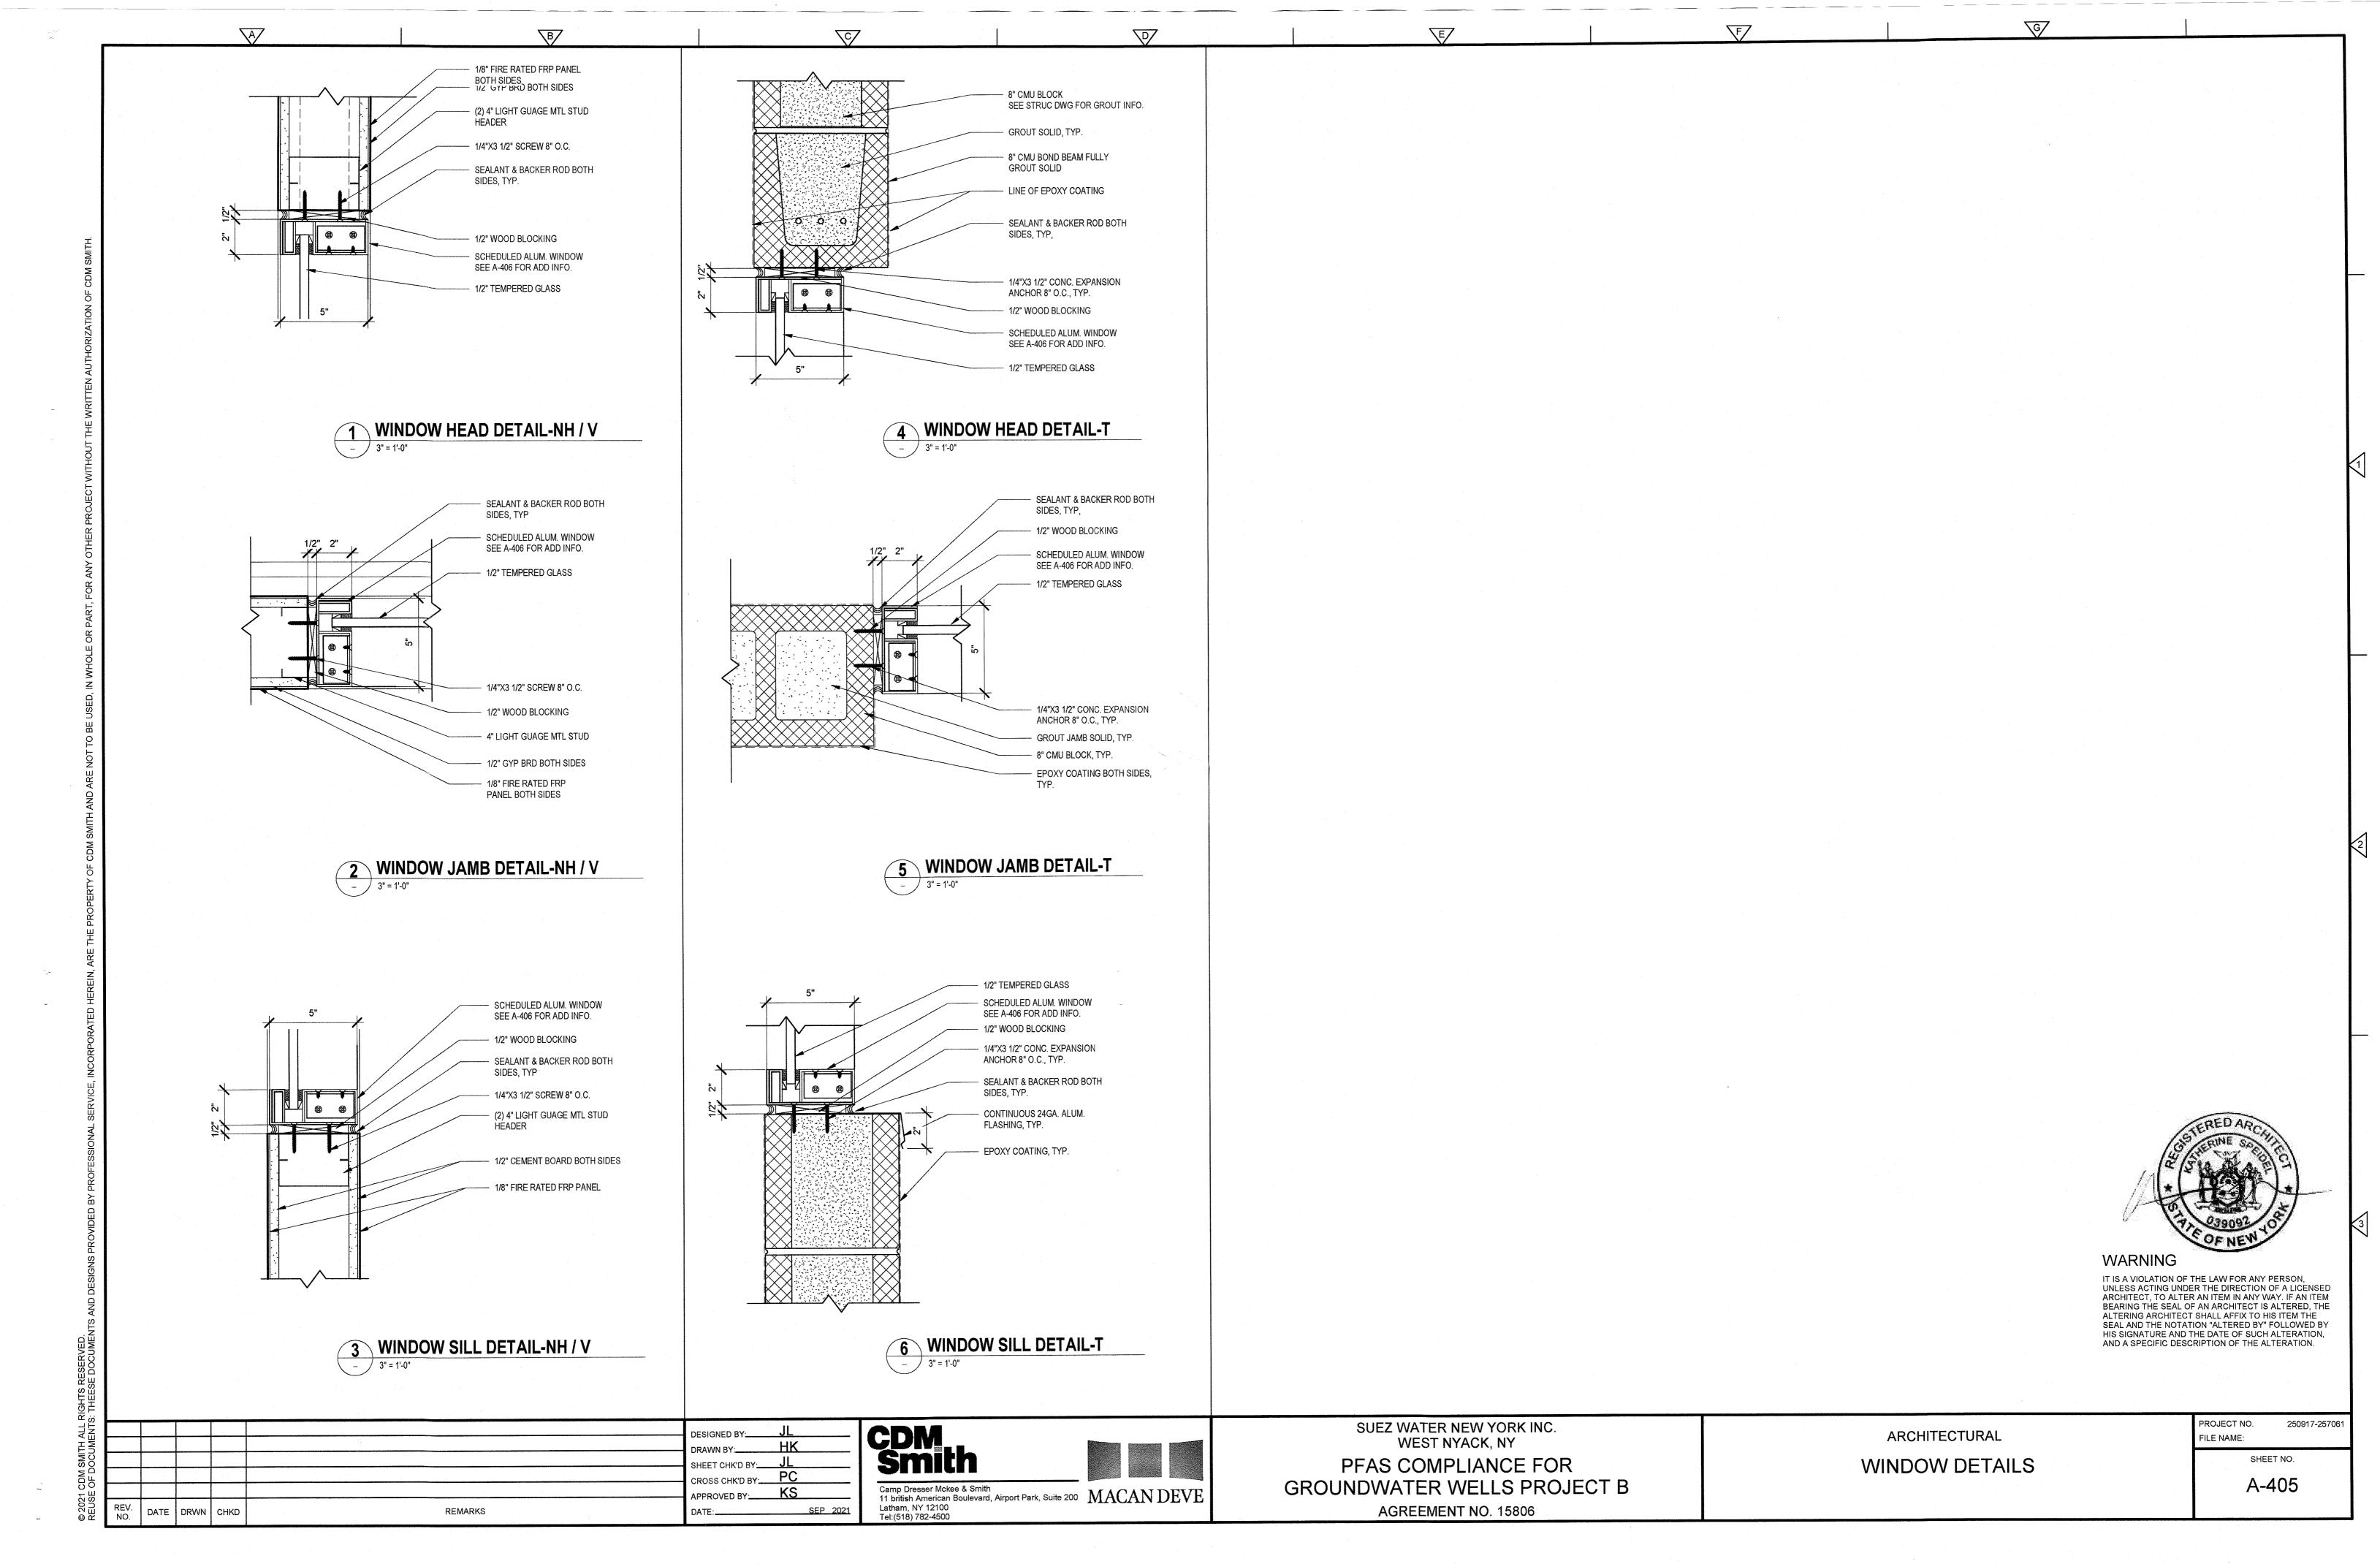

C

E

HAR	DWARE SET 1			
QTY.	DESCRIPTION	MANUFACTURER	MODEL	REMARKS
3	HINGES	McKINNEY	TA2314	STAINLESS STEEL
1	CLOSER	LCN	5015 SERIES	INSTALL PUSH SIDE, EXT. DOOR
1	PULL DEVICE	STANLEY	1700A	GC TO SUBMIT GRIP STYLE FOR APPROVAL
1	EXIT DEVICE	STANLEY	APEX 2000 SERIES	
1	DOME FLOOR STOP	IVES	FS 17	IF NECESSARY AT CONC. STEP
3	SILENCER	IVES	SR 64	

WINDOW SCHEDULE								
	NA (INIDONA / NIO	OU LUEIOUT	SI	IZE	AAA TEDIAL S			
BUILDING	WINDOW NO.	SILL HEIGHT	WIDTH	HEIGHT	MATERIAL	REMARK		
NEW	NH-W-01	4'-0"	3'-0"	2'-0"	1/4" TEMPERED GLASS			
HEMPSTEAD								
TAPPAN	T-W-01	4'-0"	3'-0"	2'-0"	1/4" TEMPERED GLASS			
VIOLA	V-W-01	4'-0"	3'-0"	2'-0"	1/4" TEMPERED GLASS			
			,					


LOUVER SO	CHEDULE			
DI III DING	LOUVER NO.	SIZE		DEMARK
BUILDING		WIDTH	HEIGHT	REMARK
NEW	NH-L-01	3'-4"	2'-4"	INTAKE
HEMPSTEAD	NH-L-02	3'-4"	2'-4"	INTAKE
	NH-L-03	1'-10"	1'-10"	EXHAUST
	NH-L-04	2'-4"	2'-4"	EXHAUST
	NH-L-05	2'-4"	2'-4"	EXHAUST
TAPPAN	T-L-01	3'-4"	2'-4"	INTAKE
	T-L-02	1'-10"	1'-10"	EXHAUST
	T-L-03	2'-4"	2'-4"	EXHAUST
VIOLA	V-L-01	3'-4"	2'-4"	INTAKE
	V-L-02	3'-4"	2'-4"	INTAKE
	V-L-03	1'-10"	1'-10"	EXHAUST
	V-L-04	2'-4"	2'-4"	EXHAUST
	V-L-05	2'-4"	2'-4"	EXHAUST

FINISH SCH	HEDULE			
AREA		FLOOR FINISH	WALL FINISH	
NEW HEMPSTEAD	MAIN GAC AREA	FINE BROOM FINISH WITH CONCRETE SEALER	N/A	
	CHEMICAL STORAGE ROOM	FINE BROOM FINISH WITH EPOXY COATING	CMU WALLS: EPOXY COATING CEMENTBOARD WALLS: FRP PANEL	
TAPPAN	MAIN GAC AREA	FINE BROOM FINISH WITH CONCRETE SEALER	N/A	
	CHEMICAL STORAGE ROOM	FINE BROOM FINISH WITH EPOXY COATING	CMU WALLS: EPOXY COATING CEMENTBOARD WALLS: FRP PANEL	
VIOLA	MAIN GAC AREA	FINE BROOM FINISH WITH CONCRETE SEALER	N/A	
	CHEMICAL STORAGE ROOM	FINE BROOM FINISH WITH EPOXY COATING	CMU WALLS: EPOXY COATING CEMENTBOARD WALLS: FRP PANEL	

					DESIGNED BY: JL
					DRAWN BY: HK
					SHEET CHK'D BY
					CROSS CHK'D BY: PC
$\Lambda$	12/21	JL	KS	REVISE DRAWING PER 90% COMMENTS	APPROVED BY. KS
REV. NO.	DATE	DRWN	CHKD	REMARKS	DATE: SEP 2021

Latham, NY 12100

Tel:(518) 782-4500

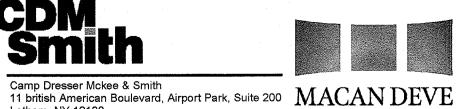

SUEZ WATER NEW YORK INC. WEST NYACK, NY PFAS COMPLIANCE FOR GROUNDWATER WELLS PROJECT B AGREEMENT NO. 15806

ARCHITECTURAL

SCHEDULES AND SIGNAGE **GENERAL** 

G

PROJECT NO. 250917-257061 FILE NAME: SHEET NO.

IT IS A VIOLATION OF THE LAW FOR ANY PERSON, UNLESS ACTING UNDER THE DIRECTION OF A LICENSED ARCHITECT, TO ALTER AN ITEM IN ANY WAY. IF AN ITEM BEARING THE SEAL OF AN ARCHITECT IS ALTERED, THE ALTERING ARCHITECT SHALL AFFIX TO HIS ITEM THE SEAL AND THE NOTATION "ALTERED BY" FOLLOWED BY HIS SIGNATURE AND THE DATE OF SUCH ALTERATION, AND A SPECIFIC DESCRIPTION OF THE ALTERATION.

WARNING

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