Name of Municipality: TOWN OF ORANGETOWN

Date Submitted: 5/20/22

2022 LAND USE BOARD APPLICATION

Subdir Numb Site P Condit Specia Varian Perfort Use Va	er of Lots lan ional Use Il Permit	Residential — Historical Board — Architectural Board — Consultation — Pre-Preliminary/Sketch — Preliminary — Final — Interpretation PERMIT#: BUR-1121-22 ASSIGNED INSPECTOR: Dom Referred from Planning Board: YES / NO If yes provide date of Planning Board meeting:	
Project Name: <u>@ Bo</u>	evoletine Julies	N	
Street Address: 280	Ehrhardt RD		
Toy Man D	09.05 Block:	3 Lot(s): 20 Lot(s):	
Directional Location:			
feet	de of <u>Chrhardf</u> (constitution of the intersection in the hamlet/village of	of Robertsin DR, approximatel Pear I RIVER	
Acreage of Parcel School District Ambulance District Water District	D.109 12 nuet 12 plari Rwer/Nanvet Syez	Zoning District R-15 Postal District Pearl Ruge Fire District S. Wangeton Sewer District S. Drangeton	n un
Project Description: (If a	edditional space required, plea	se attach a narrative summary.)	cor heigh
The undersigned agrees to an Date: 5/20/7 Appl	extension of the statutory time lin	nit for scheduling a public hearing.	

APPLICATION REVIEW FORM

FILL IN WHERE APPLICABLE. (IF THE FOLLOWING DOES NOT APPLY PLEASE MOVE ON TO THE NEXT PAGE)

lf sub	division:
II SHIP	
	Is any variance from the subdivision regulations required?
	2) Is any open space being offered? If so, what amount?
15	3) Is this a standard or average density subdivision?
If site	plan:
	Existing square footage
	2) Total square footage
	Number of dwelling units
If spec	ial permit, list special permit use and what the property will be used for.
Are there Are there	slopes greater than 25%? If yes, please indicate the amount and show the gross rea streams on the site? If yes, please provide the nameswetlands on the site? If yes, please provide the names and type: History:
Has this p	roject ever been reviewed before?
It so, prov	ide a narrative, including the list case number, name, date, and the board(s) you appeared d the status of any previous approvals.
List tax ma	ap section, block & lot numbers for all other abutting properties in the same ownership as



OFFICE OF BUILDING, ZONING, PLANNING, ADMINISTRATION AND ENFORCEMENT TOWN OF ORANGETOWN

20 Greenbush Road Orangeburg, N.Y. 10962

Jane Slavin, R.A. Director (845)359-8410


Fax: (845) 359-8526


DENIAL TO THE ZONING BOARD OF APPEALS

Date: May 19, 2022	
Applicant: Baudeline	
Address: 286 Ehrhardt Rd Pearl River NY	
RE: Application Made at: same	
Chapter 43, Table 3.12, Column 1 R-15 District, Column 1 and 30' with 19.2' and 25.8' proposed, Two variances required	mn 2 Group M , Column 3 SFR, Column 8 Front
Section: 69.05 Block: 4	Lot:35
Dear Baudeline :	
Please be advised that the Building Permit Application [In Accordance with Zoning, Chapter 43 Section 10] Building Inspector or Similar administrative office determination with the Town Clerk.	Xerox copy of your application, where you will find .322 the time to appeal a determination of a
The Clerk to the Zoning Board of Appeals, Debbie Ar	bolino, will assist you in the preparation necessary to
Richard Oliver Deputy Building/Inspector	1/19/22
Signature of Director NOTE: PLEASE KEEP FOR YOUR RECORDS	Date CC: Rosanna Sfraga Liz Decort

Debbie Arbolino

swis	PRINT KEY	NAME	ADDRESS PAGE # 1
392489	69.05-3-19 \	Trudyann Binger	297 Ehrhardt Rd, Pearl River, NY 10985
392489	69.05-3-20	lan Pena	287 Ehrhardt Rd, Pearl River, NY 10985
392489	69.05-3-21 · ·	Greg Varnum	281 Ehrhardt Rd, Pearl River, NY 10985
392489	69.05-3-22 \	Comelio Mazeriego	275 Ehrhardt Rd, Pearl River, NY 10965 —
392489	69 .05-4-24 ~	Giuseppe Oteri	11 Robertson Dr. Pearl River, NY 10985
392489	69.05-4-28 \	Jasmina Gutic	30 Robertson Dr.Pearl River, NY 10965
392489	69.05-4-29 \	Eileen G O'Connell	20 Robertson Dr. Pearl River, NY 10965 -
392489	6 9 .05-4-30 \	Elias C Geras	10 Robertson Dr. Pearl River, NY 10965
392489	69.05-4-31 、	Thomas Hanney	298 Ehrhardt Rd, Pearl River, NY 10965
392489	69.05 - 4-32 、	Raymond Stormes	33 Villa Dr.Nanuet, NY 10954
392489	69.05-4-33 、	Charles Parnow Jr	294 Ehrhardt Rd, Pearl River, NY 10985
392489	69.05-4-34 🕏	Patrick Brennan	288 Ehrhardt Rd, Pearl River, NY 10965
392489	69.05-4-35 <i>×</i>	Baudeline Julien	288 Ehrhardt Rd, Pearl River, NY 10985
392489	69.05-4-36 \	Marc W Kroenung	32 Atlantic Ave, Nanuet, NY 10954 —
392489	69.05-4-37 \	Christopher G Potamianos	278 Ehrhardt Rd, Pearl River, NY 10965
392489	69.05-4-38 `	Kevin E Hurley	270 Ehrhardt Rd. Pearl River, NY 10885
392489	69.05-4-39 `	Michael G O'Meara	268 Ehrhardt Rd, Pearl River, NY 10985
392489	69.0 5-4-4 0 \	Edward W Aufenanger	264 Ehrhardt Rd, Pearl River, NY 10965
392489	69.06-1-43 `	Diane Hogan	15 Thomsen Cir, Pearl River, NY 10985
392489	69.08-1-44	Eileen M Rufo	19 Thomsen Cir, Pearl River, NY 10985
392489	69.06-1-45 `	Michael Vislocky	24 Thomsen Cir.Pearl River, NY 10885
392489	69.06-1-46 \	Joseph Gartner	16 Thomsen Cir, Pearl River, NY 10965
392489	69.06-1-47 ·	Steven R Smith	157 Villa Rd, Pearl River, NY 10985
302460	-60.65-4-41.1	-Patrick Byrne	252 Ehrhardt Rd, Possi River, NY 10985
-302489	-69.05-4-41.3	Patrick Byme	.252 Ehrhardt Rd, Poert River, NY -10305
6	9.05-3-23	Neighborhood Church of the Christian & missionary	253 Ehrhardt B., Rearl River, NY 1096s
6	9.05 -3-11	the Christian 4 missionary	
		Maureen Benoit	178 Violet Dr., Rearl River, NY 10965
6	9.05-3-12	Norman J Peterson 4 Yeu Sunyoung	170 Violet Dr., Pearl River, NY 10965

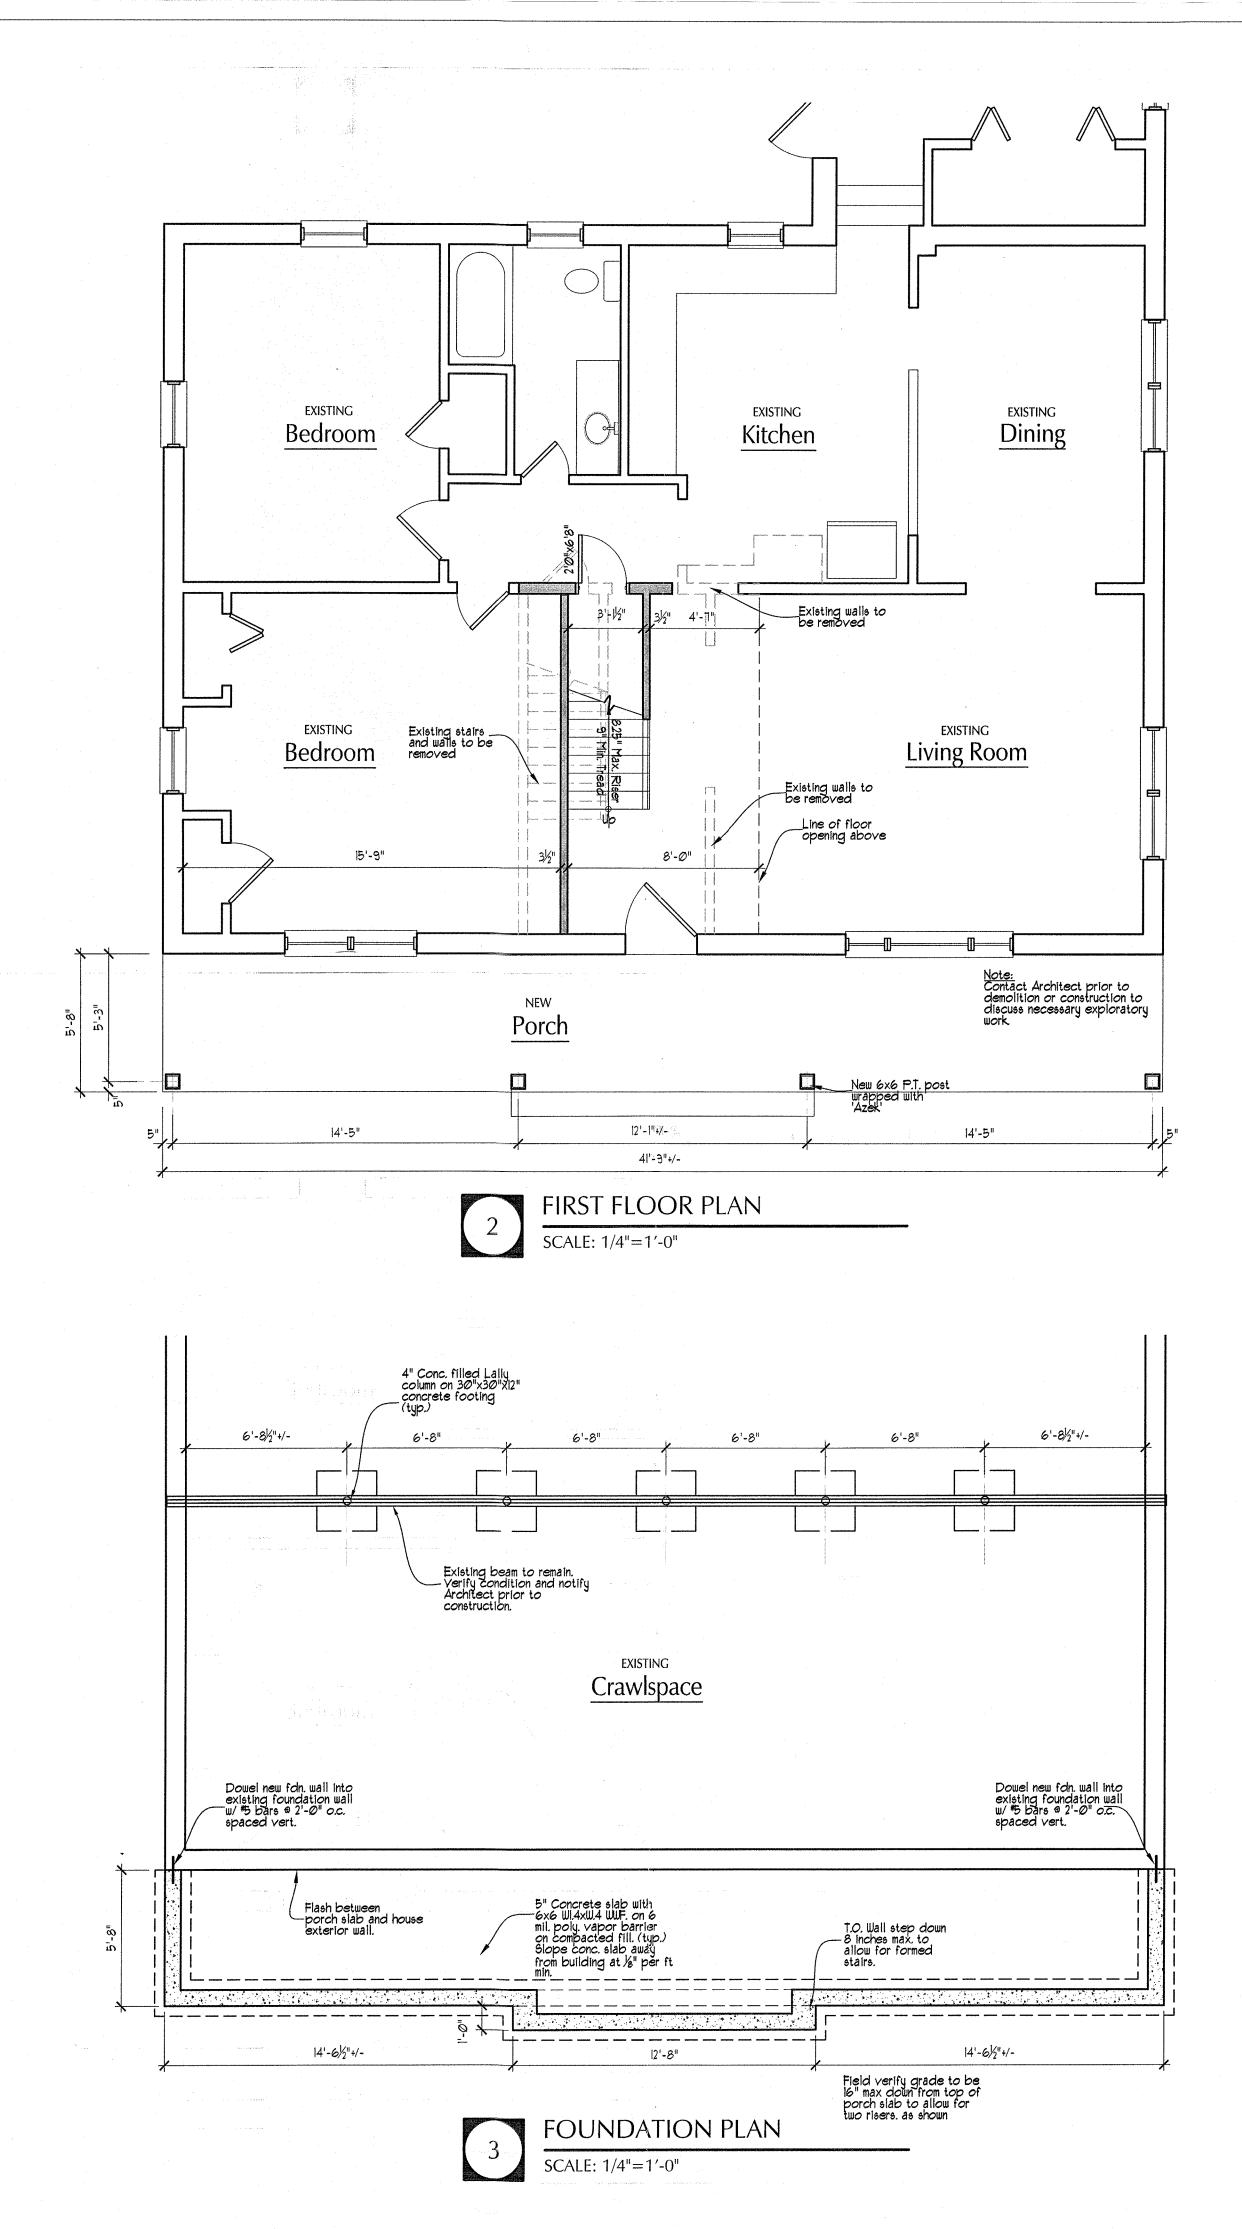

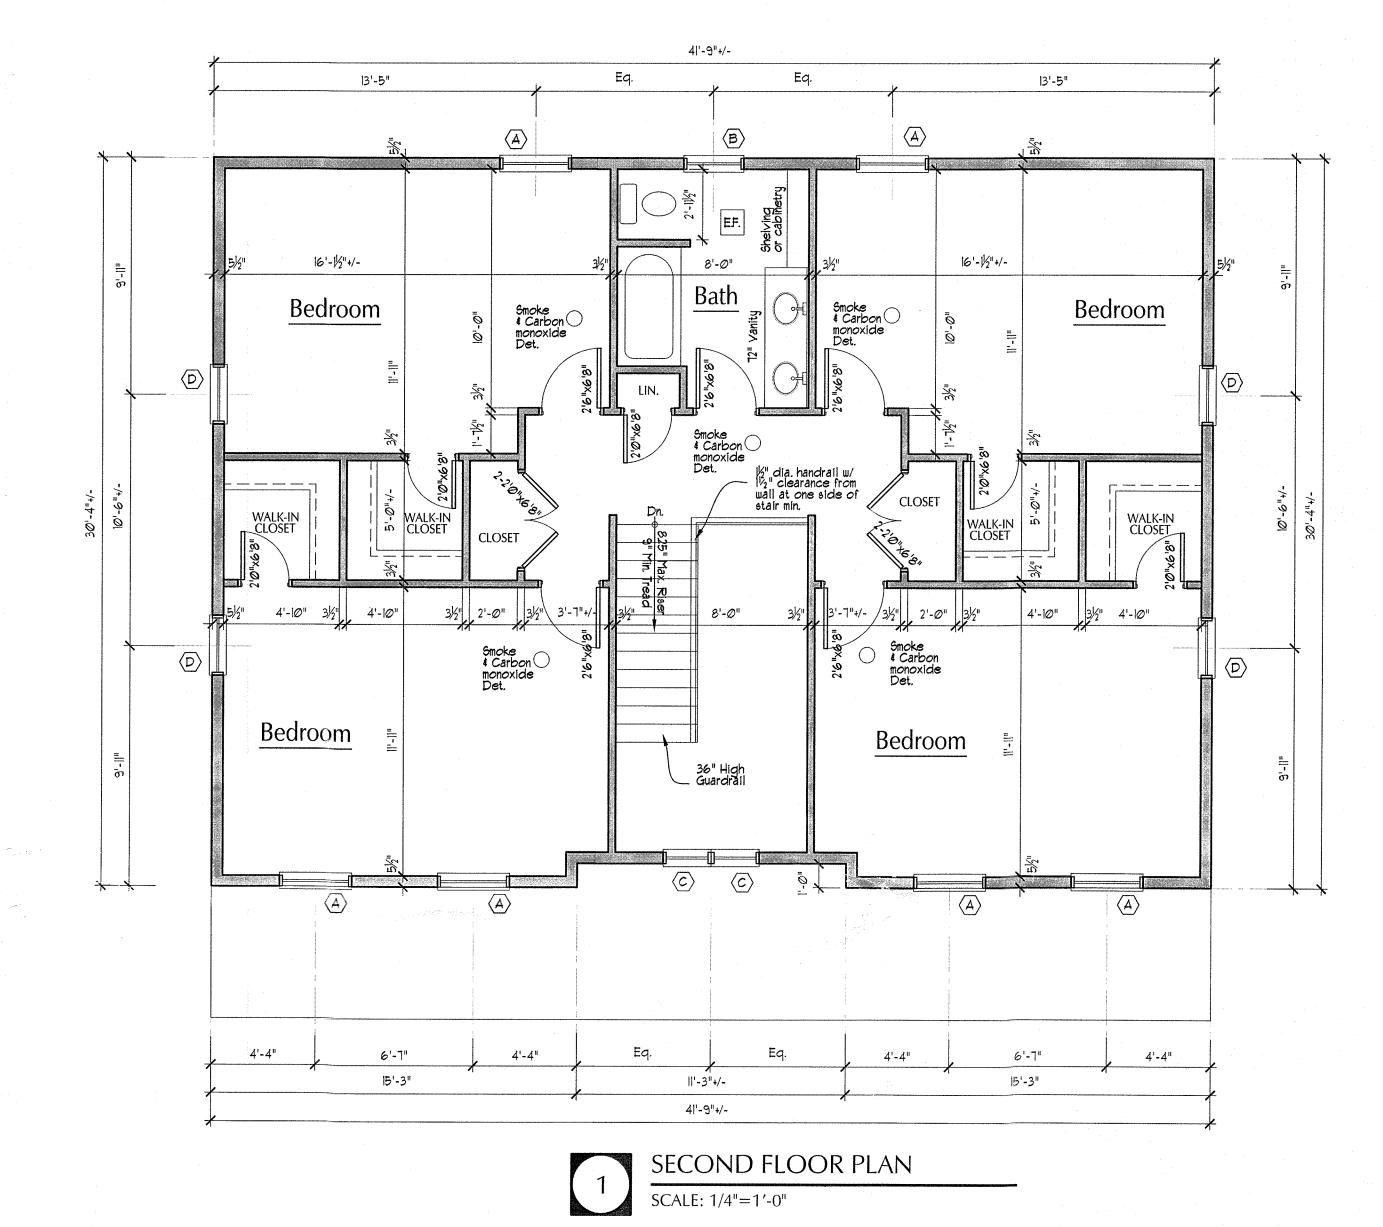

General Notes:

- I.) Contractor shall provide field verifications and measurements where the Work is affected by existing/site conditions. Contractor or Owner shall notify Architect prior to construction when plan discrepancies are found. Architect shall not be responsible for changes made in the field that deviate from the drawings unless approved by Architect
- 2.) The contractor shall comply with all local, state and federal regulations.
- 3.) Mechanical and electrical systems are to be done on a design/build basis by the contractor, and shall meet all applicable codes and standards. Consult with owner prior to installation of these systems.
- 4.) Contractor shall be responsible for securing all necessary permits and fees.
- 5.) All interior walls to be 1/2" G.W.B. on 2x4 or 2x6 studs @ 16" o.c. unless noted otherwise.
- 6.) Provide shelving and hanging rods as applicable at all closets.
- 7.) All closets shall have the same floor treatment as the adjacent room.

 8.) Provide moleture resistant GIIB behind all sinks and in all bathrooms.
- 8.) Provide moisture resistant G.W.B. behind all sinks and in all bathrooms.
- 9.) All dimensions are to face of framing unless noted otherwise.
 10.) All closets shall be provided with hanging rod at 5'-4" AFF. with shelf above unless otherwise noted.
- II.) Provide 4 shelves spaced 12"o.c. vertically in all linen closets.

Foundation Notes:


- 1.) All concrete shall have a strength of 3000 p.s.i. at 28 days (min.) Any other slabs exposed to weather shall have a strength of 3500 p.s.i. at 28 days (min.)
- 2.) All footings shall bear on undisturbed soil with min. bearing capacity of 3000 psi and shall be a minimum of 3'-6" below finish grade.
- of 3000 pst and shall be a minimum of 3'-6" below finish grade.


 3.) All foundation/footing steps shall have sloped bottom of footing.
- 4.) Provide 1/2" dia. anchor bolts at 6'-0" o.c. and 12" from corners. Bolts shall extend min. 1'-0" into concrete.
- 5.) Concrete slabs shall be 4" thk on 6 mil. poly. vapor barrier over 6" min. compacted gravel fill. (Garage 4 exterior slabs shall be 5" thick) Field verify soil conditions and provide wire mesh or fiber mesh as
- 6.) Provide structural fill (95% compaction) under all concrete slabs where backfill is required.
- 1.) Any wood in direct contact with concrete or within 8" of grade shall be pressure treated lumber.
- 8.) Provide sleeves for piping, mechanical & electrical services as required (typ.)
- 9.) Contractor to verify T.O.W. (top of wall) elevation with finish grade.
- 10.) Contractor shall be responsible for verifying soil conditions. Substandard soils shall require a structural engineer to determine proper reinforcement for foundation walls and slabs.

Window Schedule			
No.	Unit Size	Type	Remarks
А	3'-@"x5'-@"	Dbl. Hung	Egress window
В	2'-6"×4'-0"	Dbl. Hung	
С	2'-Ø"x3'-6"	Dbl. Hung	
D	2'-6"x5'-Ø"	Dbl. Hung	
E	l'-l@"xl'- @"	Auning	

Note:

Window unit sizes are shown for design purposes. Contractor shall provide window submittal for review prior to construction. Screens shall be included. Consult with owner for grille and color options. Contractor shall consult manuf. installation instructions for rough opening sizes.

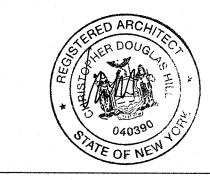

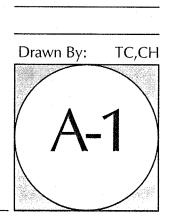


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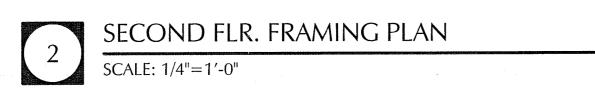
Date:

Revisions:

Ehrhardt

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Framing Notes:

Design of new framing members based on the following values: Fb (base value) = 875psi Fy = 90psi

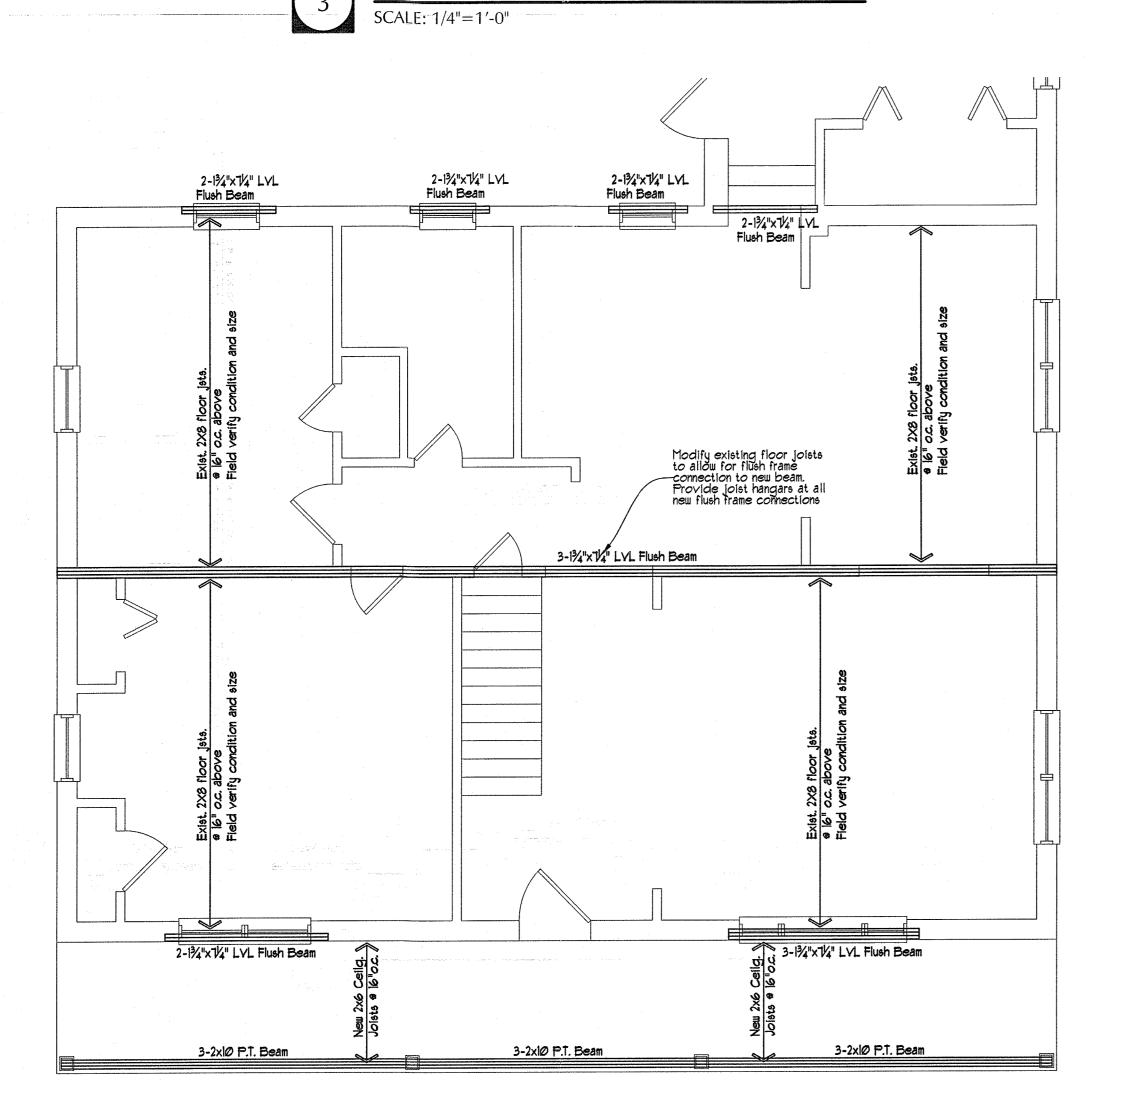E = 16000000 psi Micro-Lam Beams = 2800 Fb

Structural Loads:

Roof Notes:

	Dead Load	Live Load	Total Load
st FLOORS	10 lbs./SF.	40 lbs./SF.	50 lbs./SF.
and FLOORS	10 lbs/SF.	30 lbs/SF.	40 lbs./SF.
R00F	10 lbs/SF.	40 lbs./SF.	50 lbs./SF.
ATTIC	10 lbs/SF.	15 lbs/SF.	25 lbs./SF.

- 1.) All standard lumber joists and rafters to be kiln dried or surface dried Douglas-Fir Larch 2 or better with an allowable bending stress of 1200 psi min. All studs to be kiln dried or surface dried Spruce-pine-fir 2 grade. Max. moisture content shall not exceed 19%.
- 2.) All LVL beams from manuf. 'Boise-Cascade'. Any substitutions shall meet or exceed the performance and quality specifications of this manuf. Architect and Owner shall be notified of any substitutions prior to construction. Install engineered I-joists per manuf. Installation instructions. Notify Architect of any discrepancies prior to construction.
- 3.) All framing shall be spaced at 16"o.c. unless otherwise noted.
- 4.) Provide cross bridging at 8'-0" o.c. maximum within all horizontal framing. Refer to engineered joists and rafters installation instructions for further requirements.
- 5.) Provide solid wood blocking in floor framing space below all columns, posts and jack study to transfer loads to structure below.

1. Provide 30 year roof shingles over \$5 roofing paper unless otherwise

Provide wide ice and water barrier at all valleys, rakes, eaves and along roof surfaces that abut an adjacent wall or have a pitch of 4:12 or less. Ice and water shield shall extend 2'-0" beyond interior plain of exterior wall surfaces.

3. Provide prefinished metal gutters and downspouts. All downspouts shall have a min. 4" diameter. Coordinate downspout locations with

6. Install roofing materials per manuf. Installation instructions. Where there is a discrepancy between materials selected and scope of work shown, notify architect prior to construction.


site plan for drainage connections if req'd.


5. Provide ridge vents at all ridges.

4. Provide perforated vinyl beaded soffits at all soffits.


6.) Typical door headers shall be 2-2x8's unless noted otherwise.

- 1.) Provide metal joist hangers at all flush framing conditions unless noted otherwise.
- 8.) G.C. to minimize notching of floor joist for the installation of new plumbing piping. Where notching is unavoidable, joist hole or notch shall be less than 1/4 joist depth. Provide 1/16"x1" sheet metal straps at the bottom of all notched floor joist. Straps shall extend 8" along bottom of joist at each side of pipe.
- 9.) General Contractor shall field verify all dimensions and conditions and shall notify architect of any discrepancies prior to start of
- 10.) All lumber in direct contact with concrete, masonry or within 8" of finish grade shall be pressure treated.
- 11.) Floor construction shall remain continuous across all mechanical chases throughout the entire building. All floor penetrations shall be firestopped as required.
- 12.) Provide firestopping at all duct, pipe and other penetrations through rated partitions and floor assemblies. Use UL rated sealants and caulking as manufactured by Dow, 3M or approved equal. Follow manufacturer's installation instructions.
- 13.) Provide solid blocking for wall mounted accessories such as handrails, bathroom accessories, etc.
- 14.) Provide double joists or rafters @ all sides of all openings in floors \$ roofs.
- 15.) Provide double joists under parallel partitions.
- 16.) Provide all connectors and fasteners as req'd by code to perform work shown. Where discrepancies occur notify Architect prior to construction. Where fasteners are exposed to exterior, galvanized fasteners shall be used.

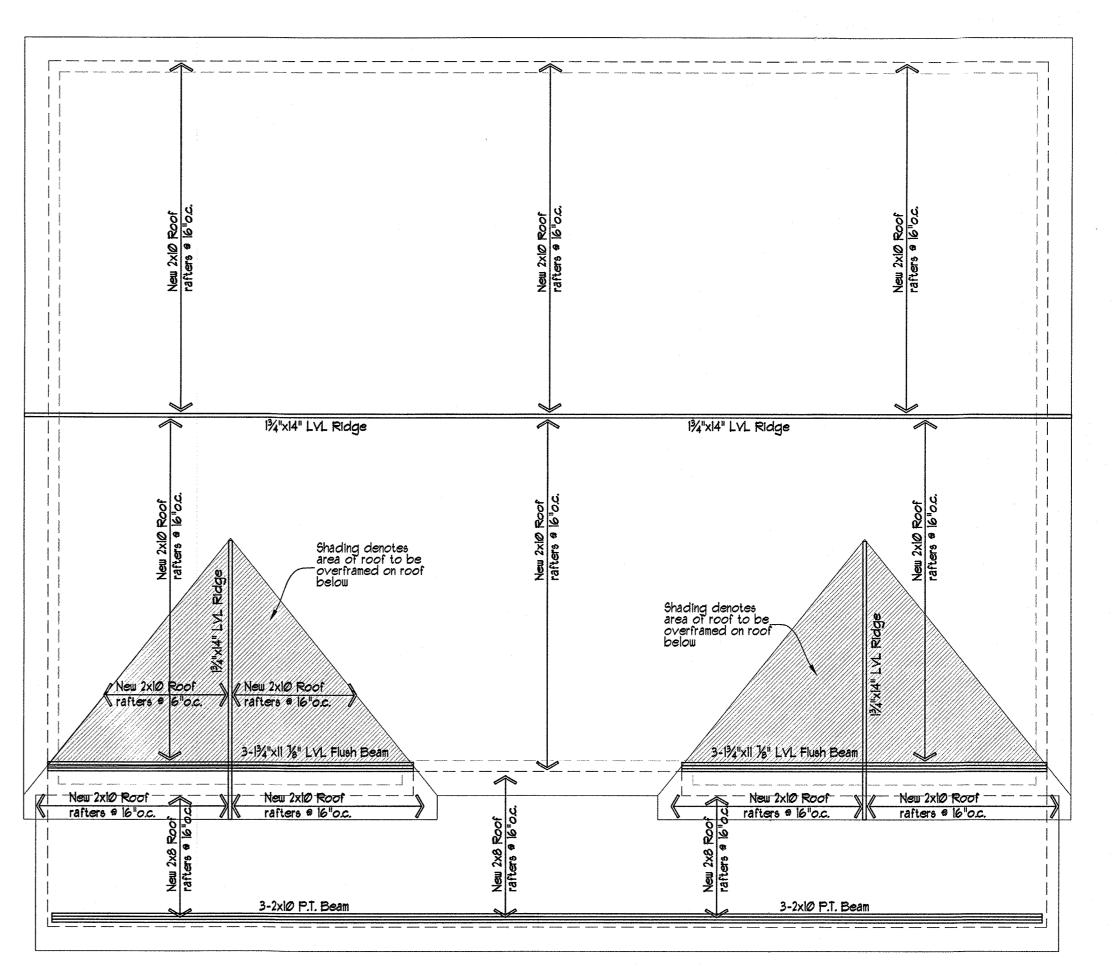

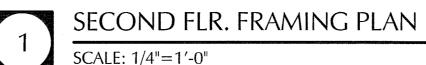



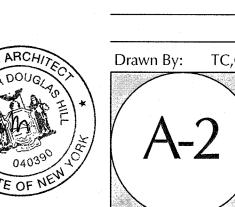

Ehrhardt

286 Ehrhardt R
Pearl River, NY

Blue Moon Design

Sheet Description Elevations

Date: 4-27-22
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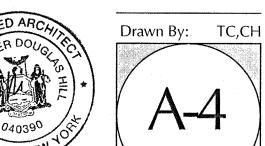
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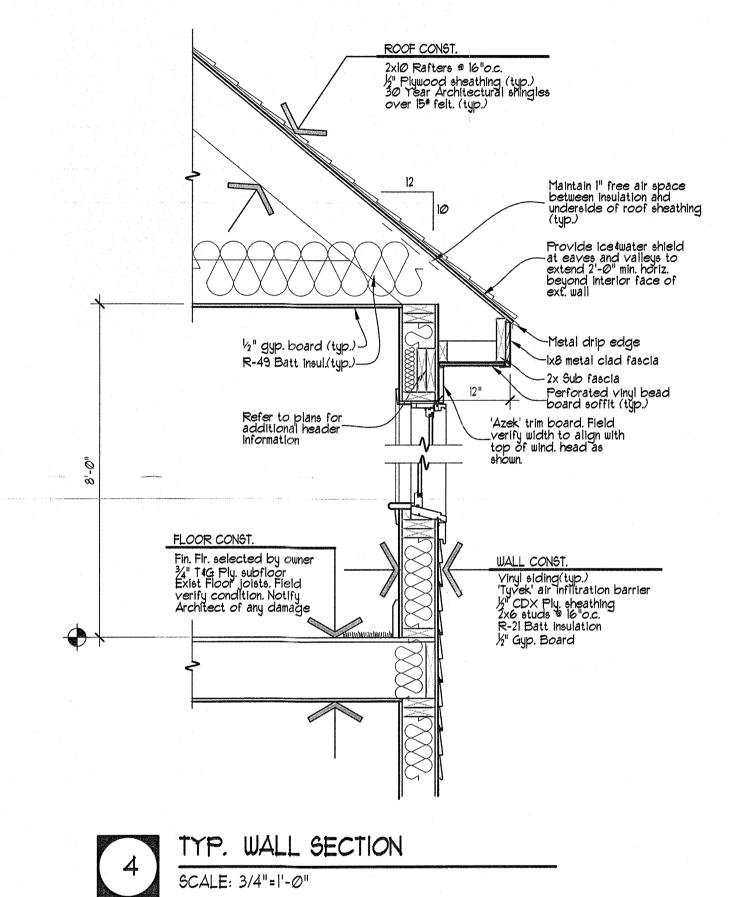
Drawn By: TC,CH


OUGLES

A-3

Revisions:





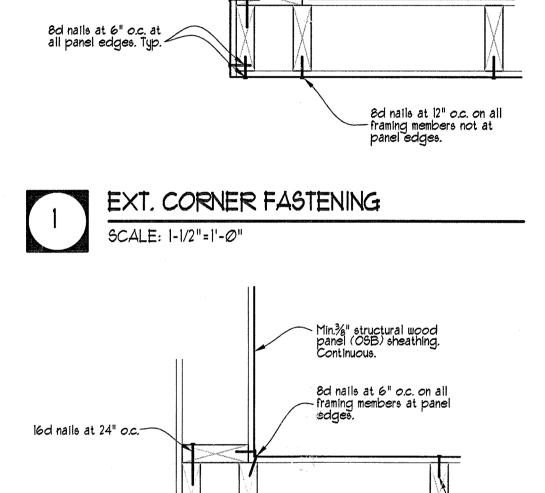


— ½" wall gyp. brd. installed 8" o.c. halls or 16"o.c. √ screws.

8d nails at 12" o.c. on all framing members not at panel edges.

Min.3%" structural wood panel (OSB) sheathing. Continuous.

16d nails at 12" o.c. -



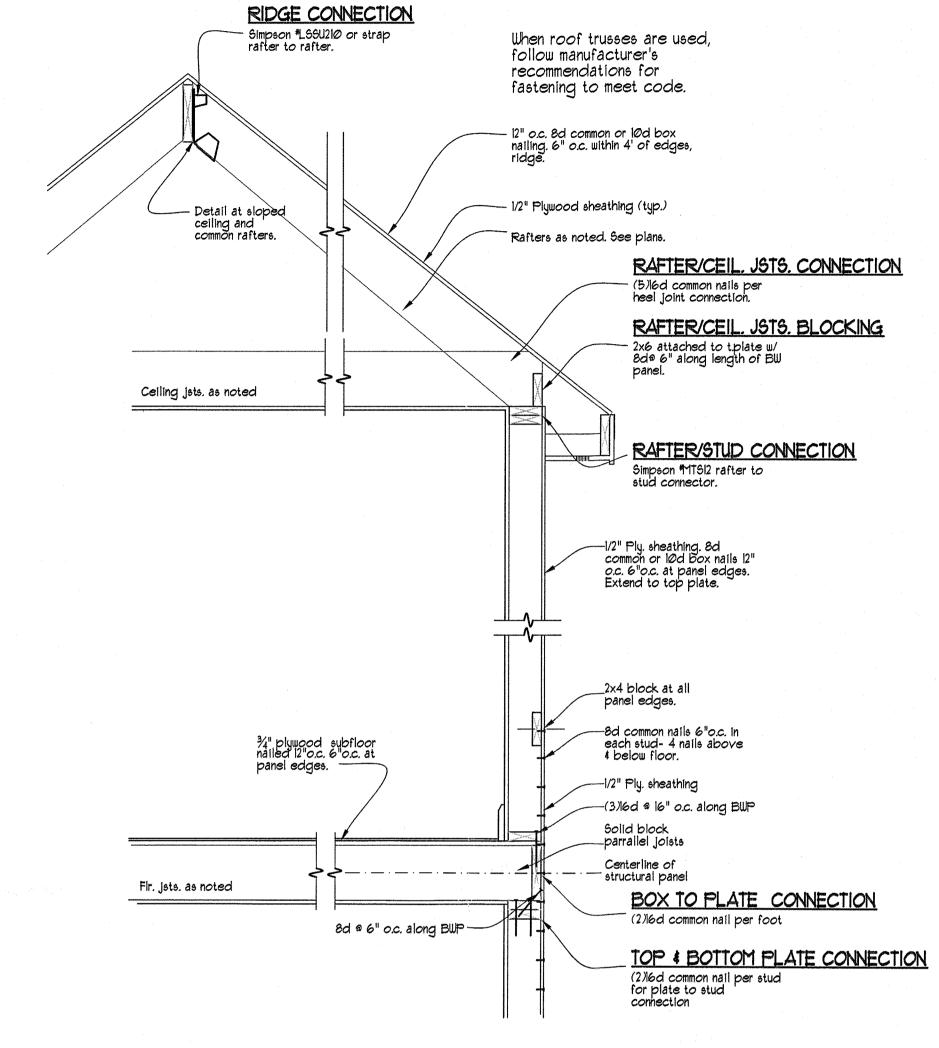




Architectural Design LLC

Architectural Design LLC

168 Main Street Terryville, CT 06786 tel. (860) 582-2225

Light shaded area depicts location of proposed front porch

Dark shaded area depicts location of second floor addition

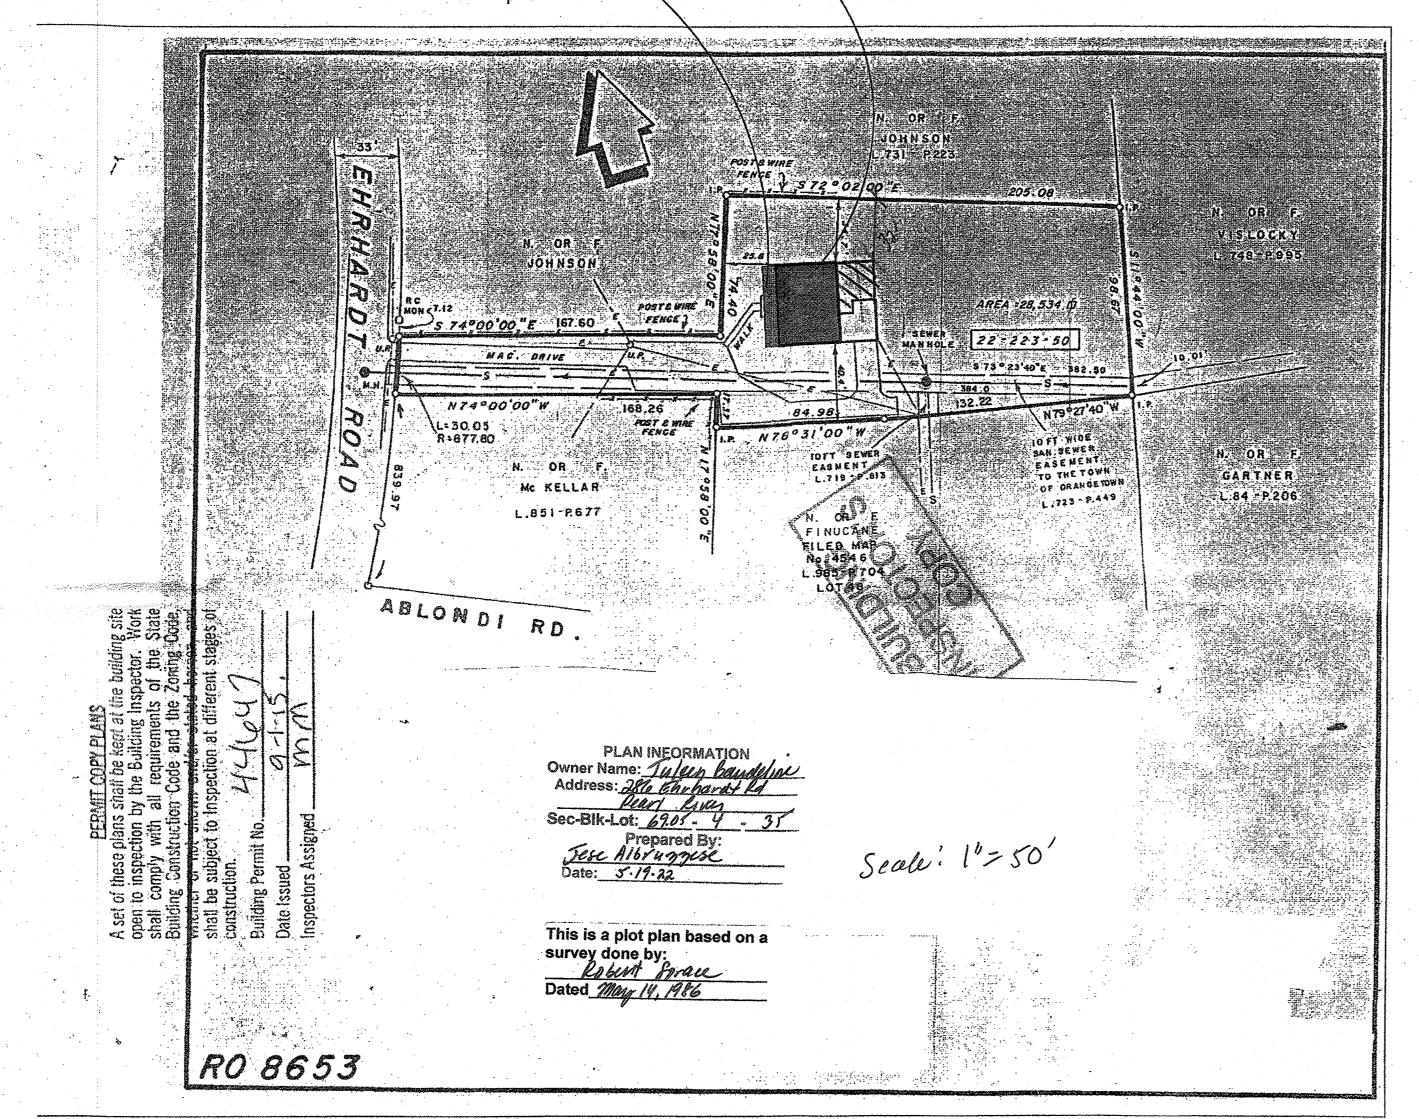

Zo	oning Table	
ZONE: R-B	Required	Provided
FAR	20 Max	10
Min. Lot. Area	15,000 s.f.	28,534 s.f.
Min. Lot Width	100'	113' (approx.)
Min. Street Frontage	75'	305' (exist.)
Required Front Yard	30'	(9,2 approx)
Required Side Yard	20'	32'
Total Side Yard	50'	604' (approx)
Required Rear Yard	35'	Ibi' (approx.)

SITE DIAGRAM

SCALE: 1/50"=1'-0"

The purpose of this diagram is to show the proposed location of work This is not to be construed as a certified site plan. The survey shown (drawn by Dillin 4 Sorace Associates) is being used as an underlay only. All proposed structures and work shall be properly located by sureveyor and shall conform with zoning regulations.

Sheet Description Site Diagram

Date: 4-27-22 Revisions:

ㅎ

Frac

286 Pearl Riv

S-1