PROPERTY INFORMATION

HARING AVENUE SPARKILL, NY 10976 PROJECT TYPE: DEVELOPMENT OF EMPTY LOT TO PROVIDE NEW SINGLE-FAMILY WOOD-FRAME DWELLING LOT NUMBER: LOT WIDTH: LOT DEPTH: 173.11'

LOT AREA: 12,165 SF (.28A) ALLOWABLE F.A.R. (3,650 SF) GROSS FLOOR AREA PROPOSED: 3,647 SF

MAXIMUM BUILDING HEIGHT*: 30'-0" PROPOSED BUILDING HEIGHT: 27'-2"

SEE SITE PLAN FOR ALL REQUIRED SETBACKS AND PROPOSED BUILDING SETBACKS. MAXIMUM BUILDING HEIGHT IS EQUAL TO 1'-4" PER 1'-0" DISTANCE FROM NEAREST PROPERTY LINE.

GENERAL NOTES

THESE SIGNED & SEALED DOCUMENTS HAVE BEEN PREPARED TO ILLUSTRATE AND EXPLAIN THE SCOPE OF WORK REQUIRED FOR THE CONSTRUCTION OF A NEW SINGLE-FAMILY WOOD-FRAMED DWELLING, AND ARE LIMITED TO BASIC STRUCTURAL & ARCHITECTURAL INFORMATION, NO FURTHER LIABILITY SHALL BE ASSUMED BEYOND THE CONTENTS HEREIN.

ALL MECHANICAL, ELECTRICAL, & PLUMBING INFORMATION AND SCOPE OF WORK SHALL BE PROVIDED BY OTHERS.

ALL WORK SHALL COMPLY WITH NYC BUILDING CODE, NFPA, NYC ELECTRICAL CODE & ALL OTHER APPLICABLE CODES & ORDINANCES AND IN ACCORDANCE WITH MUNICIPALITY RULES, APPLICABLE CODES INCLUDE: 2015 INTERNATIONAL BUILDING CODE NY STATE / 2015 INTERNATIONAL RESIDENTIAL CODE

2017 UNIFORM CONSTRUCTION CODE WITH NY STATE SUPPLEMENT 2015 ENERGY CONSERVATION CODE OF NEW YORK STATE WITH 2017 ENERGY CODE SUPPLEMENTS.

IN ADDITION TO WORKMAN'S COMPENSATION AND DISABILITY INSURANCE REQUIRED BY THE DEPARTMENT OF BUILDINGS, ALL CONTRACTORS AND SUBCONTRACTORS PERFORMING WORK IN THE PREMISES SHALL PROVIDE LIABILITY INSURANCE IN AMOUNTS DESIGNATED BY THE BUILDING OWNER.

IN THE EVENT OF CONFLICTS BETWEEN THE DOCUMENTS AND THE REQUIREMENTS OF THE BUILDING CODE, THE MORE STRINGENT REQUIREMENT GOVERNS.

IN THE EVENT OF ERRORS OR INCONSISTENCIES IN THE DOCUMENTS, THE GENERAL CONTRACTOR SHALL NOTIFY THE ARCHITECT. THE ARCHITECT SHALL PROVIDE CLARIFYING INFORMATION TO THE CONTRACTOR. THE CONTRACTOR SHALL IMMEDIATELY NOTIFY THE ARCHITECT OF ANY STRUCTURAL CONDITIONS NOT SHOWN ON THESE PLANS.

THE INTENT OF THESE DOCUMENTS IS TO ILLUSTRATE AND INCLUDE BASIC ITEMS NECESSARY FOR THE PROPER EXECUTION OF THE WORK. THE CONTRACTOR SHALL FURNISH OR CONTRACT FOR ALL LABOR, MATERIALS, TOOLS, EQUIPMENT AND OTHER ITEMS AS

MAY BE NECESSARY TO COMPLETE THE WORK CALLED FOR, SHOWN ON OR REASONABLY INFERRED BY THESE DOCUMENTS.

THE ARCHITECT IS NOT RESPONSIBLE FOR CONSTRUCTION METHODS, TECHNIQUES, OR PROCEDURES, OR FOR SAFETY PRECAUTIONS AND PROGRAMS IN CONNECTION WITH THE WORK SINCE THESE ARE SOLELY THE GENERAL CONTRACTOR'S RESPONSIBILITY.

DO NOT SCALE DRAWINGS TO OBTAIN DIMENSIONS. IF UNCERTAINTY ARISES REGARDING DIMENSIONS, ALIGNMENTS, HEIGHTS, ETC. CONTACT THE ARCHITECT FOR CLARIFICATION.

THE CONTRACTOR SHALL COORDINATE THE WORK OF SEPARATE TRADES. THE CONTRACTOR SHALL COORDINATE THE FITTING AND MATCHING OF MATERIALS AND EQUIPMENT SUPPLIED BY THE SUBCONTRACTORS OR THEIR SUPPLIERS.

THE CONTRACTOR SHALL INSURE THAT ALL WORK IS INSTALLED STRAIGHT, TRUE TO LINE, ACCURATELY FITTED AND LOCATED WITH PROPER SUPPORTS, GROUNDS, BLOCKING, HARDWARE, BACKING MATERIAL, JOINTS, SEALANT OR GROUTS AS APPLICABLE USING APPROPRIATE HARDWARE OR CONNECTION DEVICES AND FOR THE PROPER INTEGRATION OF THE WORK OF DIFFERENT TRADES. ALL ITEMS SHALL BE ANCHORED FIRMLY AS REQUIRED BY SUBSTRATE CONDITIONS, EXCEPT ITEMS REQUIRING LOOSE OR SLIP JOINTS OR CONNECTIONS TO ALLOW FOR EXPANSION AND CONTRACTION OR MOVEMENT IN THE BUILDING.

CONSTRUCTION & MATERIALS NOTES

FOR DESIGN PURPOSES, LOAD VALUES FOR THESE DOCUMENTS WERE TAKEN FROM TABLE R401.41, WITH SOILS MAINTAINING A MINUMUM LOAD-BEARING PRESSURE OF 2,000 PSF, ALL FOOTINGS AND FOUNDATION WORK SHALL ONLY BE INSTALLED ON SOIL WITH PROPER BEARING VALUE.

ALL CONCRETE WORK SHALL BE TRANSIT-MIXED STONE WITH A BEAING CAPACITY OF 3,000 PSI TESTED 28 DAYS AFTER POURING.

ALL LUMBER USED IN THE WORK SHALL BE SOUND, DRY, CONSTRUCTION GRADE DOUGLAS FIR OR KD SPRUCE WITH MINIMUM STRESS VALUES OF FB = 1,500 PSI AND E = 1,750,000.

DOOR, WINDOW, AND OPENING HEADERS FOR SPANS LESS THAN 6'-0" SHALL CONSIST OF (2) 2x10 LUMBER, UNLESS OTHERWISE NOTED. DOOR, WINDOW, AND OPENING HEADERS FOR SPANS BETWEEN 6'-0" AND 8'-0" SHALL CONSIST OF (3) 2x10 OR (2) 2x12 LUMBER IN EXTERIOR WALLS, UNLESS OTHERWISE NOTED.

PROVIDE DOUBLE FLOOR JOISTS AT ALL LOCATIONS WHERE PARTITIONS RUN PARALLEL WITH JOIST SPAN.

STAIRS TO BE CONSTRUCTED AND DIMENSIONED AS PER NEW YORK STATE CODE REQUIREMENTS.

MAXIMUM RISER HEIGHT: 8.25" MINIMUM TREAD DEPTH: 9"

MINIMUM NOSING DEPTH: 3/4" 36" ABOVE FINISHED FLOOR HANDRAIL HEIGHT:

MAXIMUM SPINDLE GAP: 4"

STRUCTURAL DESIGN LOADING CHART									
LOCATION	LIVE LOAD REQUIRED	DEAD LOAD APPLIED	TOTAL LOAD VALUE						
ATTIC	20 LBS / SF	10 LBS / SF	30 PSF						
GUARDRAIL & HANDRAIL	200 LBS / SF	20 LBS / SF	220 PSF						
PASSENGER VEHICLE GARAGE	20 LBS / SF	10 LBS / SF	30 PSF						
NON-SLEEPING ROOMS	40 LBS / SF	10 LBS / SF	50 PSF						
SLEEPING ROOMS	30 LBS / SF	20 LBS / SF	50 PSF						
STAIRS	40 LBS / SF	10 LBS / SF	50 PSF						
DECKS & PORCHES	40 LBS / SF	10 LBS / SF	50 PSF						

THERMAL & FIRE SAFETY NOTES

INSTALL HARD-WIRED SMOKE/CO2 DETECTORS IN ALL BEDROOMS, HALL AREAS NEAR BEDROOMS, ATTICS, AND BASEMENT AND AS PER BUILDING & FIRE SAFTEY CODE-MANDATED REQUIREMENTS.

BUILDING THERMAL ENVELOPE SHALL BE PROPERLY SEALED AND SECURED TO LIMIT AIR & MOISTURE INFILTRATION. REFER TO SECTION N102.4.1. OF THE NEW YORK STATE RESIDENTIAL CODE FOR DETAILED INFORMATION REGARDING CAULKING, WEATHERSTRIPPING, & OTHER AIR/VAPOR BARRIER MATERIALS AND INSTALLATIONS.

PROVIDE VAPOR RETARDERS AS PER NEW YORK STATE RESIDENTIAL CODE N1102.5 CLASS 1 (ROCKLAND COUNTY / ZONE 5). AT BASEMENT AND GARAGE STUD WALLS, PROVIDE SHEET POLYETHYLENE, NON PERFORATED ALUMINUM FOIL

	TABLE N1102.1 CLIMATE ZONE #5										
	LOCATION	PERFORMANCE REQUIRED	PERFORMANCE SPECIFIED								
	CEILING	R-49	R-49								
	WALL	R-21	R-21								
	FLOOR	R-30	R-30								
1	GLAZING	U-35	U-30								
	BASEMENT WALL	R-15	N/A								
	ON-GRADE SLAB EDGE	R-10	N/A								
	CRAWL SPACE	R-15	N/A								

NOTE: ALL WINDOW & DOOR MODEL NUMBERS REFERENCED APPLY TO TO ANDERSEN WINDOWS WOOD-FRAMED WINDOW LINE. SEE MANUFACTURER SPECIFICATIONS FOR MORE INFORMATION.

TABLE R301.2(1) CLIMATIC AND GEOGRAPHIC DESIGN CRITERIA													
GROUND SNOW LOAD	WIND DESIGN		SEISMIC	SUBJECT TO DAMAGE FROM		MAINTED	ICE BARRIER		ALD	NATANI			
	SPEED (MPH)*	TOPO- GRAPHIC EFFECTS*	SPECIAL WIND REGION*	WIND- BORNE DEBRIS ZONE*	DESIGN CATE- GORY*	WEATHE R-ING	FROST LINE DEPTH*	TERMITE*	WINTER DESIGN TEMP	UNDERLAY- MENT REQUIRED*	FLOOD HAZARDS	AIR FREEZING INDEX*	MEAN ANNUAL TEMP*
30 LBS/SF						SEVERE			15		ZONE X		

NOTE: * ALL CATEGORIES MARKED WITH AN ASTERISK TO BE DETERMINED BY THE JURISDICTION, AS PER TABLE R301.2(1) FOOTNOTES. FLOOD HAZARD ZONE DESIGNATION INDICATED BY FEMA FLOOD MAP SERVICE CENTER MAP #36087C0193G (EFFECTIVE 3/3/2014).

THE PART WHEN A PART A	FENESTRATION SCHEDULE (HABITABLE SPACE)									
Material Colonia de Co	WINDOW ID	LIGHT AREA (SF)	VENT AREA (SF)	LIVING ROOM	OFFICE	KITCHEN	MASTER BED	BED 1	BED 2	BED 3
	A281	3.70	1.20					-	1	
	WDH2456	9.56	4.38	4	4	2				
	G53	9.2	5.5			1				4
	50611APLR	17.38	28.34			2				
	WDH26410	9.01	5.1				2		2	
	WDH2442	7.01	4.02							2
	WDH210410	10.45	5.83	2				2		

FENESTRATION SCHEDULE NOTES:
FENESTRATION SCHEDULE INCLUDES ONLY EXTERIOR WINDOW & DOORS USED TO CALCULATE LIGHT & AIR CALCULATION REQUIREMENTS BELOW. SEE PLANS FOR ALL OTHERS.
ALL WINDOWS & DOORS TO BE ANDERSEN 400 SERIES OR OTHER APPROVED CODE-COMPLIANT ALTERNATE, ALL PLAN TAGS REFER TO ANDERSEN "WDH" SERIES UNLESS, NOTED

DRAWING	SHFFT	LIST


NOTES & SITE PLAN CELLAR & FIRST FLOOR PLAN 2ND FLOOR PLAN A-201 EXTERIOR ELEVATIONS

LIGHT & AIR CALCULATIONS - 1ST FLOOR									
ROOM NAME	[A] ROOM AREA	(A x 8%)	LIGHT AREA PROVIDED	VENTILATION AREA REQUIRED (LA x 45%)	VENTILATION AREA PROVIDED				
LIVING ROOM	289 SF	23 SF	59.1 SF	10 SF	29.2 SF				
KITCHEN/DINING AREA	524 SF	42 SF	63.1 SF	18.9 SF	70.9 SF				
OFFICE	154 SF	12 sf	38.2 SF	5.4 SF	26.3 SF				

LIGHT & AIR NOTES:
LIGHT & AIR REQUIREMENTS BASED ON SECTION 402 LIGHT/SECTION 403 VENTILATION. ALL CALCULATIONS AND AREAS SHOWN AS PER MANUFACTURER'S TECHNICAL SPECIFICATIONS FOR GLAZED AND VENTED AREAS.

LIGHT & AIR CALCULATIONS - 2ND FLOOR										
ROOM NAME	[A] ROOM AREA	[LA] LIGHT AREA REQUIRED (A x 8%)	LIGHT AREA PROVIDED	VENTILATION AREA REQUIRED (LA x 45%)	VENTILATION AREA PROVIDED					
MASTER BEDROOM	223 SF	17.8 SF	18.2 SF	8.0°SF	10.2 SF					
BEDROOM 1	253 SF	20.2 SF	20.9 SF	9.1 SF	11.7 SF					
BEDROOM 2	263 SF	21.0 SF	21.7 SF	9.4 SF	11.4 SF					
BEDROOM 3	161 SF	12.9 SF	14.0 SF	5.8 SF	8.0 SF					

LIGHT & AIR REQUIREMENTS BASED ON SECTION 402/SECTION 403. ALL CALCULATIONS AND AREAS SHOWN AS PER MANUFACTURER'S TECHNICAL SPECIFICATIONS FOR GLAZED AND VENTED AREAS.

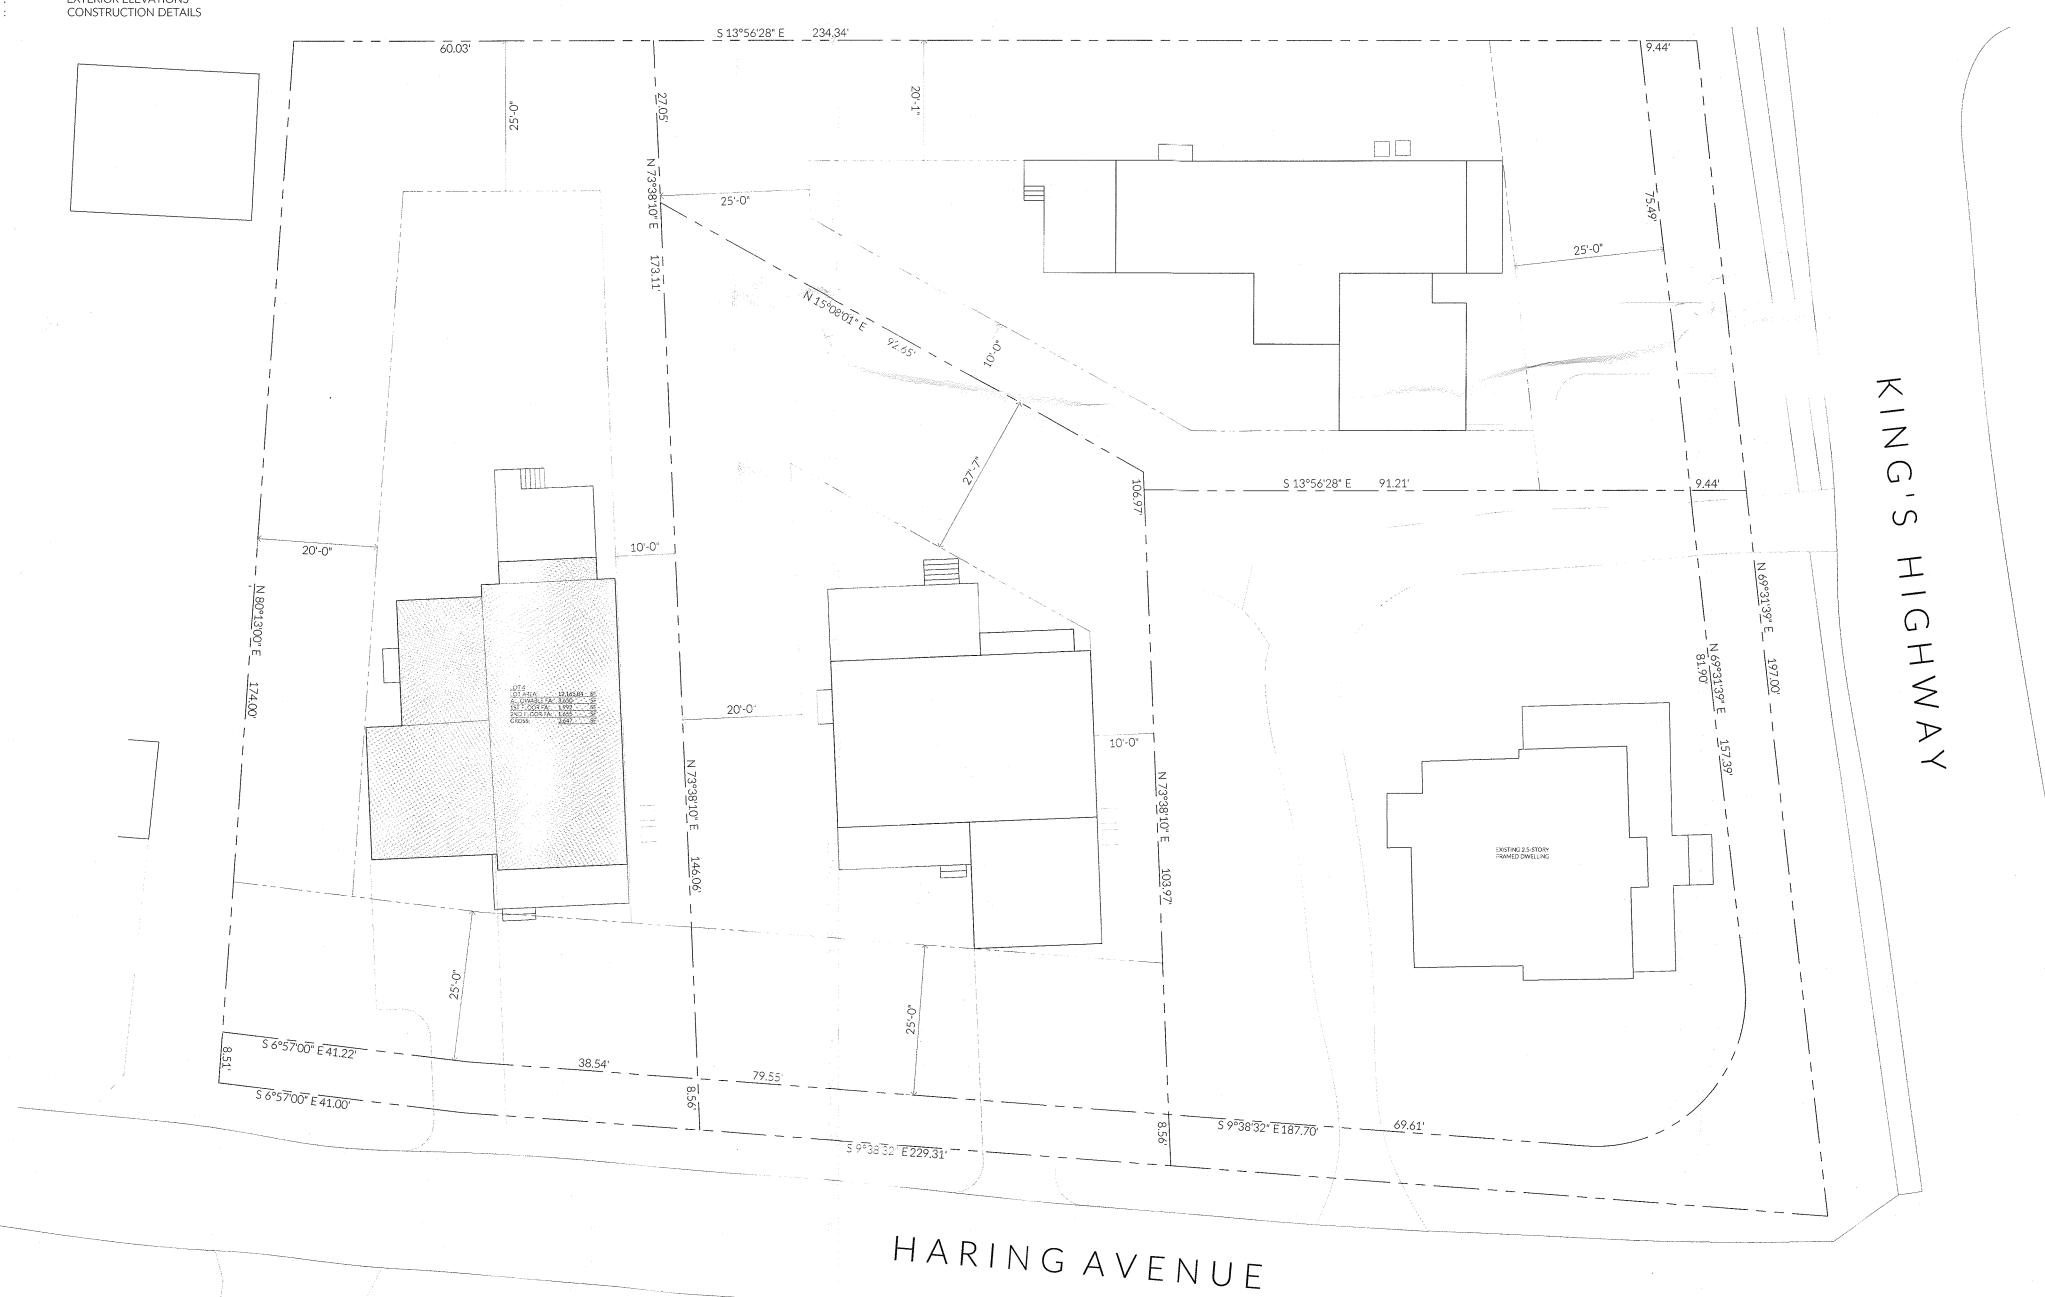

09/29/2020 ISSUE FOR PRELIMINARY REVIEW

ISSUED FOR FINAL REVIEW PRIOR TO FILING 05/27/2021

10/06/2020

10/08/2021 ISSUED FOR REVIEW **ISSUANCE RECORD**

ISSUED FOR REVIEW

OWNER:

GRIFF CONSTRUCTION, LLC 1 ROUNDHOUSE ROAD PIERMONT, NY 10968

ARCHITECT:

LUKE PETROCELLI, RA 51 STRATFORD RD, APT C3 BROOKLYN, NY 11218

PROJECT ADDRESS: LOT #4 HARING DRIVE

SPARKILL, NY 10983 DRAWING TITLE:

NOTES & PLOT PLAN




1/16" = 1'-0"

01 OF 05

DWG. NO.

G 001.00

NORTH

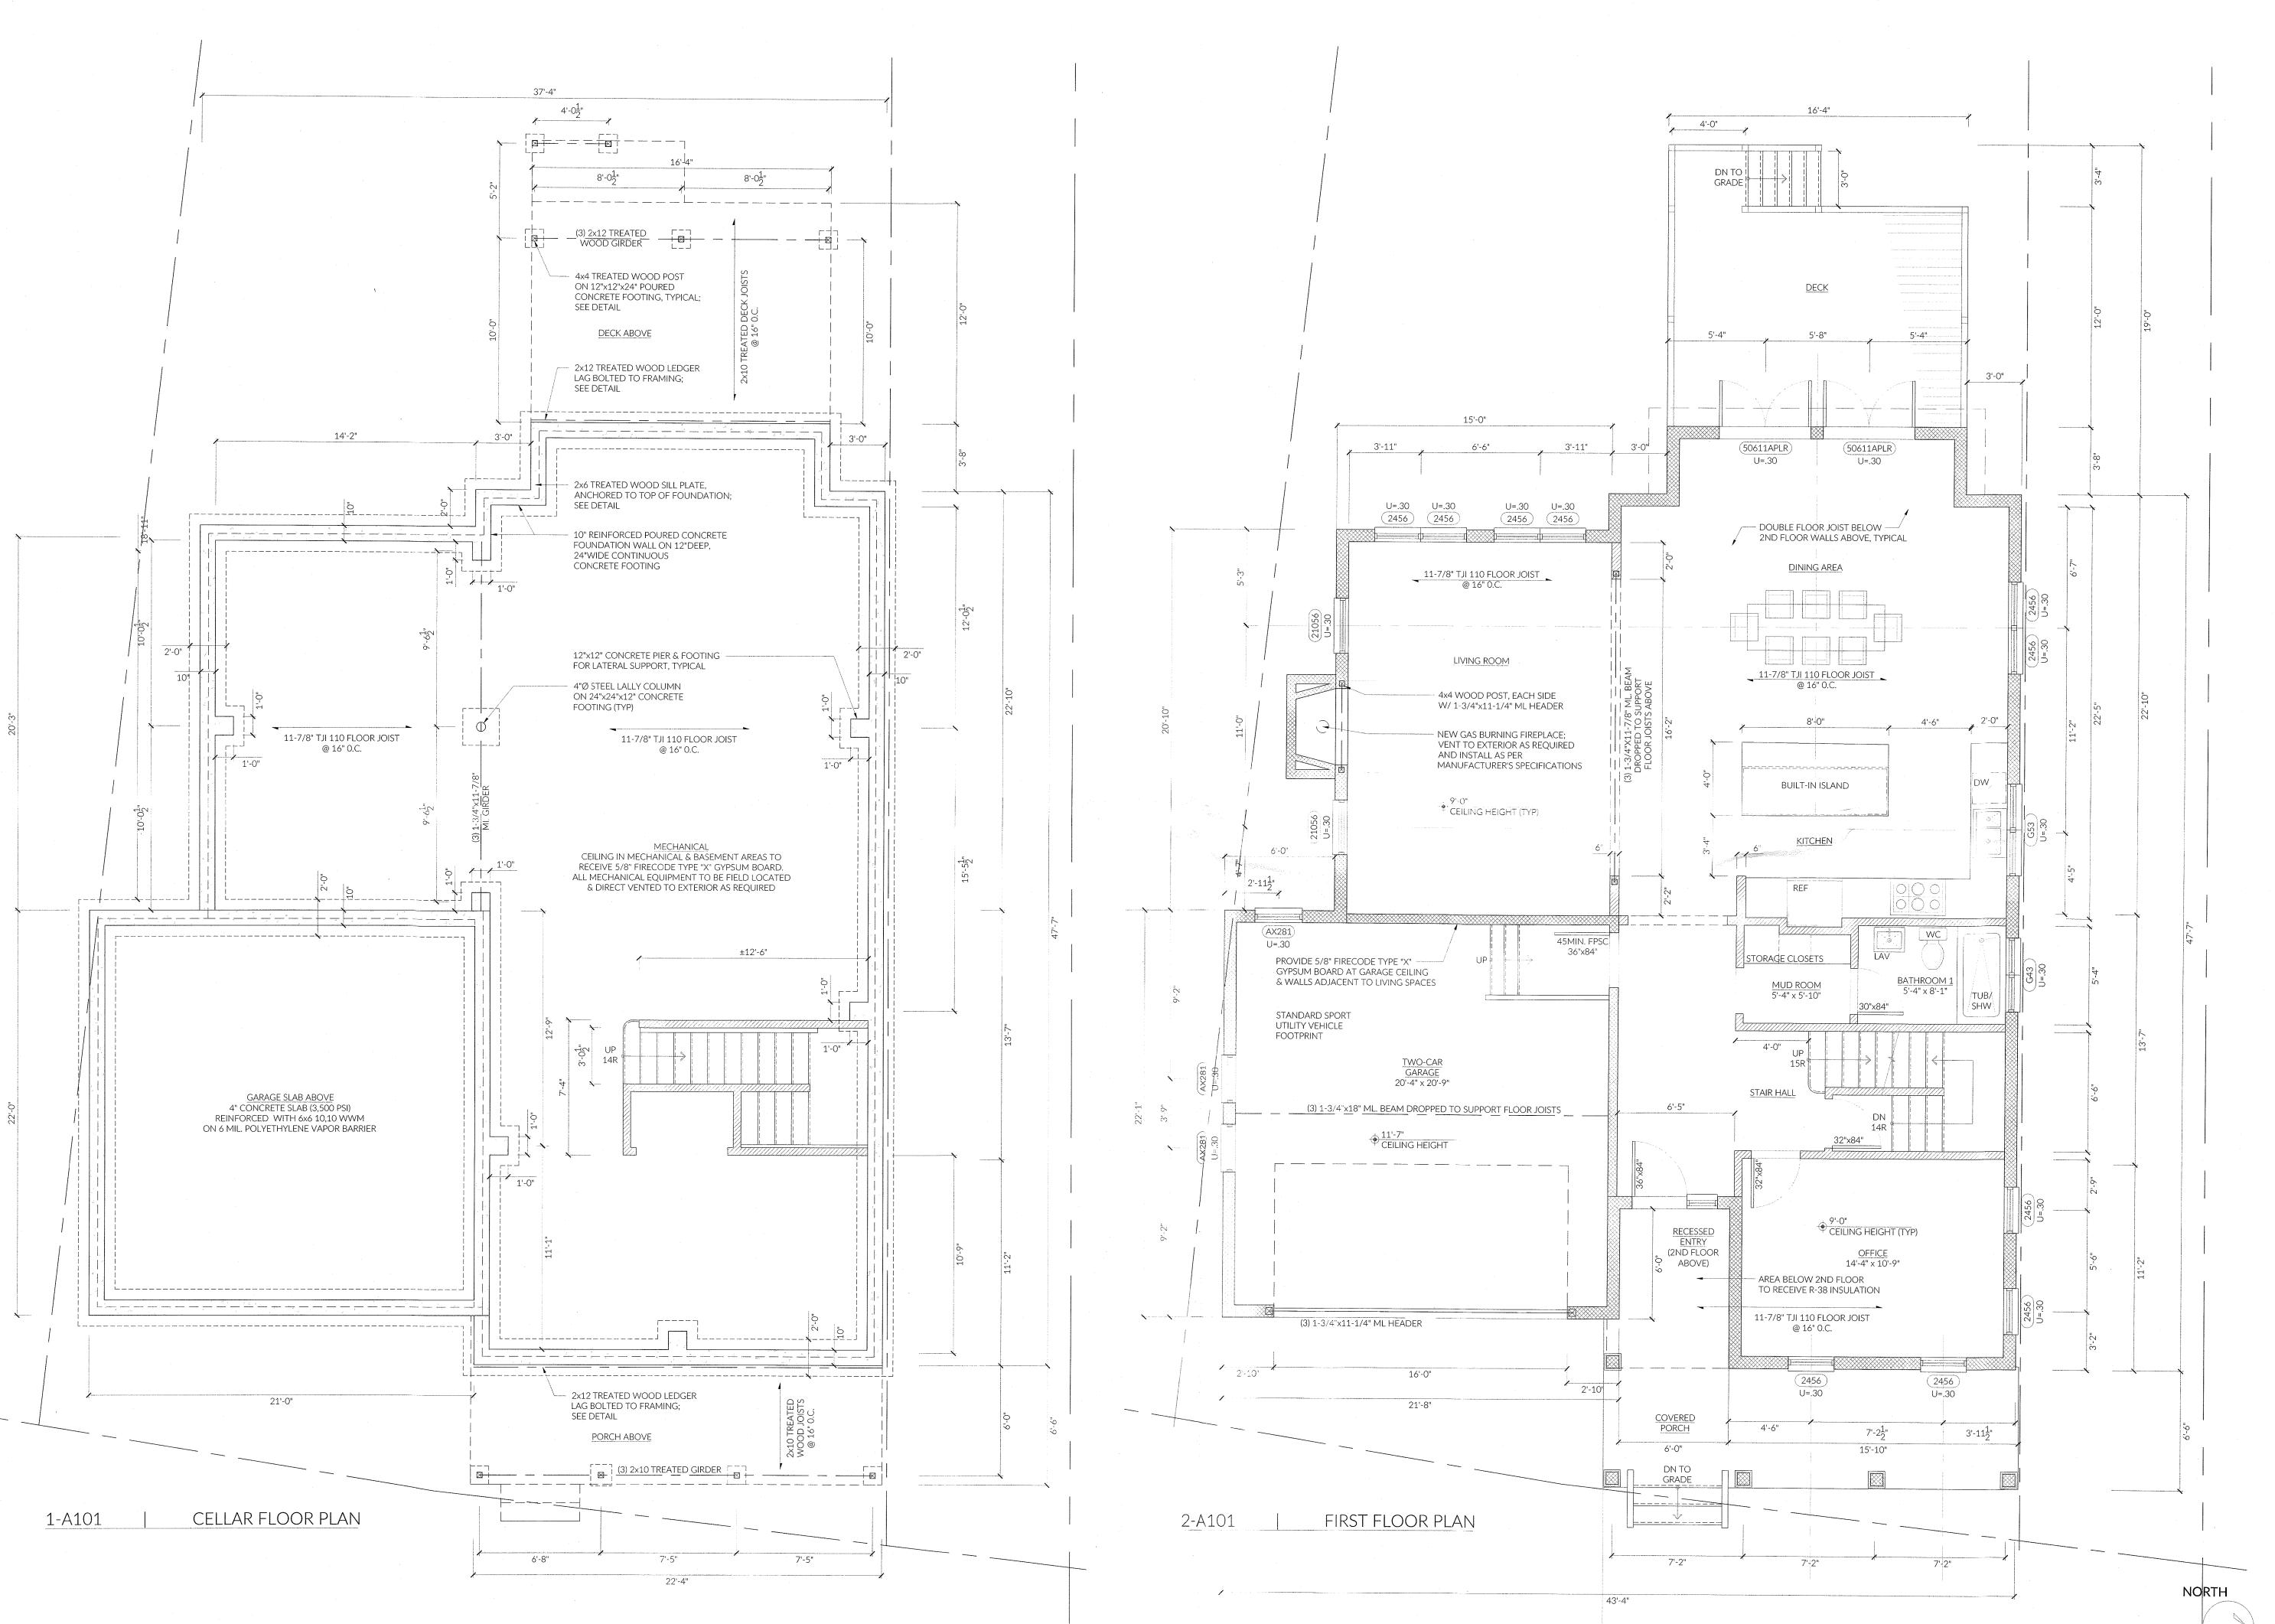

09/29/2020 ISSUE FOR PRELIMINARY REVIEW

10/06/2020 ISSUED FOR FINAL REVIEW PRIOR TO FILING

05/27/2021 ISSUED FOR REVIEW

10/08/2021 ISSUED FOR REVIEW ISSUANCE RECORD

OWNER:
GRIFF CONSTRUCTION, LLC
1 ROUNDHOUSE ROAD
PIERMONT, NY 10968


ARCHITECT:
LUKE PETROCELLI, RA
51 STRATFORD RD, APT C3
BROOKLYN, NY 11218

PROJECT ADDRESS:
LOT #4
HARING DRIVE
SPARKILL, NY 10983

DRAWING TITLE:

CELLAR & FIRST
FLOOR PLAN

SCALE: 1/4"

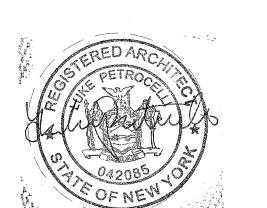

1/4" = 1'-0"

DWG. NO.

A 101.00

8'-0"
CEILING HEIGHT (TYP) 2x12 ROOF RAFTERS @ 16" O.C. 2x8 CEILING JOIST @ 16" O.C. MASTER BATHROOM 10'-1" x 7'-8" ATTIC / ACCESS ABOVE 6'-0" LAUNDRY ROOM 5'-7" x 8'-5" 4'-6" HOLD DRYER WASHER 8'-0" CEILING HEIGHT (TYP) BEDROOM 2 20'-4" x 11-0" (1) 3-1/2"x14 ML RIDGE FRAME DORMER WITH 2x8 RAFTERS @ 16"O.C.; PROVIDE 2x10 RIDGE LINEN CL BEDROOM 3 <u>WIC</u> | 5'-7" x 8'-3" A281 U=.30 9'-4¹/₂" 2442 U=.30 (2442) U=.30 3'-11<u>1</u>" 7'-2<u>1</u>" 22'-4"

09/29/2020 ISSUE FOR PRELIMINARY REVIEW

10/06/2020 ISSUED FOR FINAL REVIEW PRIOR TO FILING

05/27/2021 ISSUED FOR REVIEW

10/08/2021 ISSUED FOR REVIEW ISSUANCE RECORD

OWNER:

GRIFF CONSTRUCTION, LLC 1 ROUNDHOUSE ROAD PIERMONT, NY 10968

ARCHITECT: LUKE PETROCELLI, RA 51 STRATFORD RD, APT C3 BROOKLYN, NY 11218

PROJECT ADDRESS: LOT #4 HARING DRIVE SPARKILL, NY 10983


DRAWING TITLE:


SECOND FLOOR PLAN SCALE: 1/4" = 1/4" = 1'-0"



DWG. NO.

03 OF 05 A 102.00

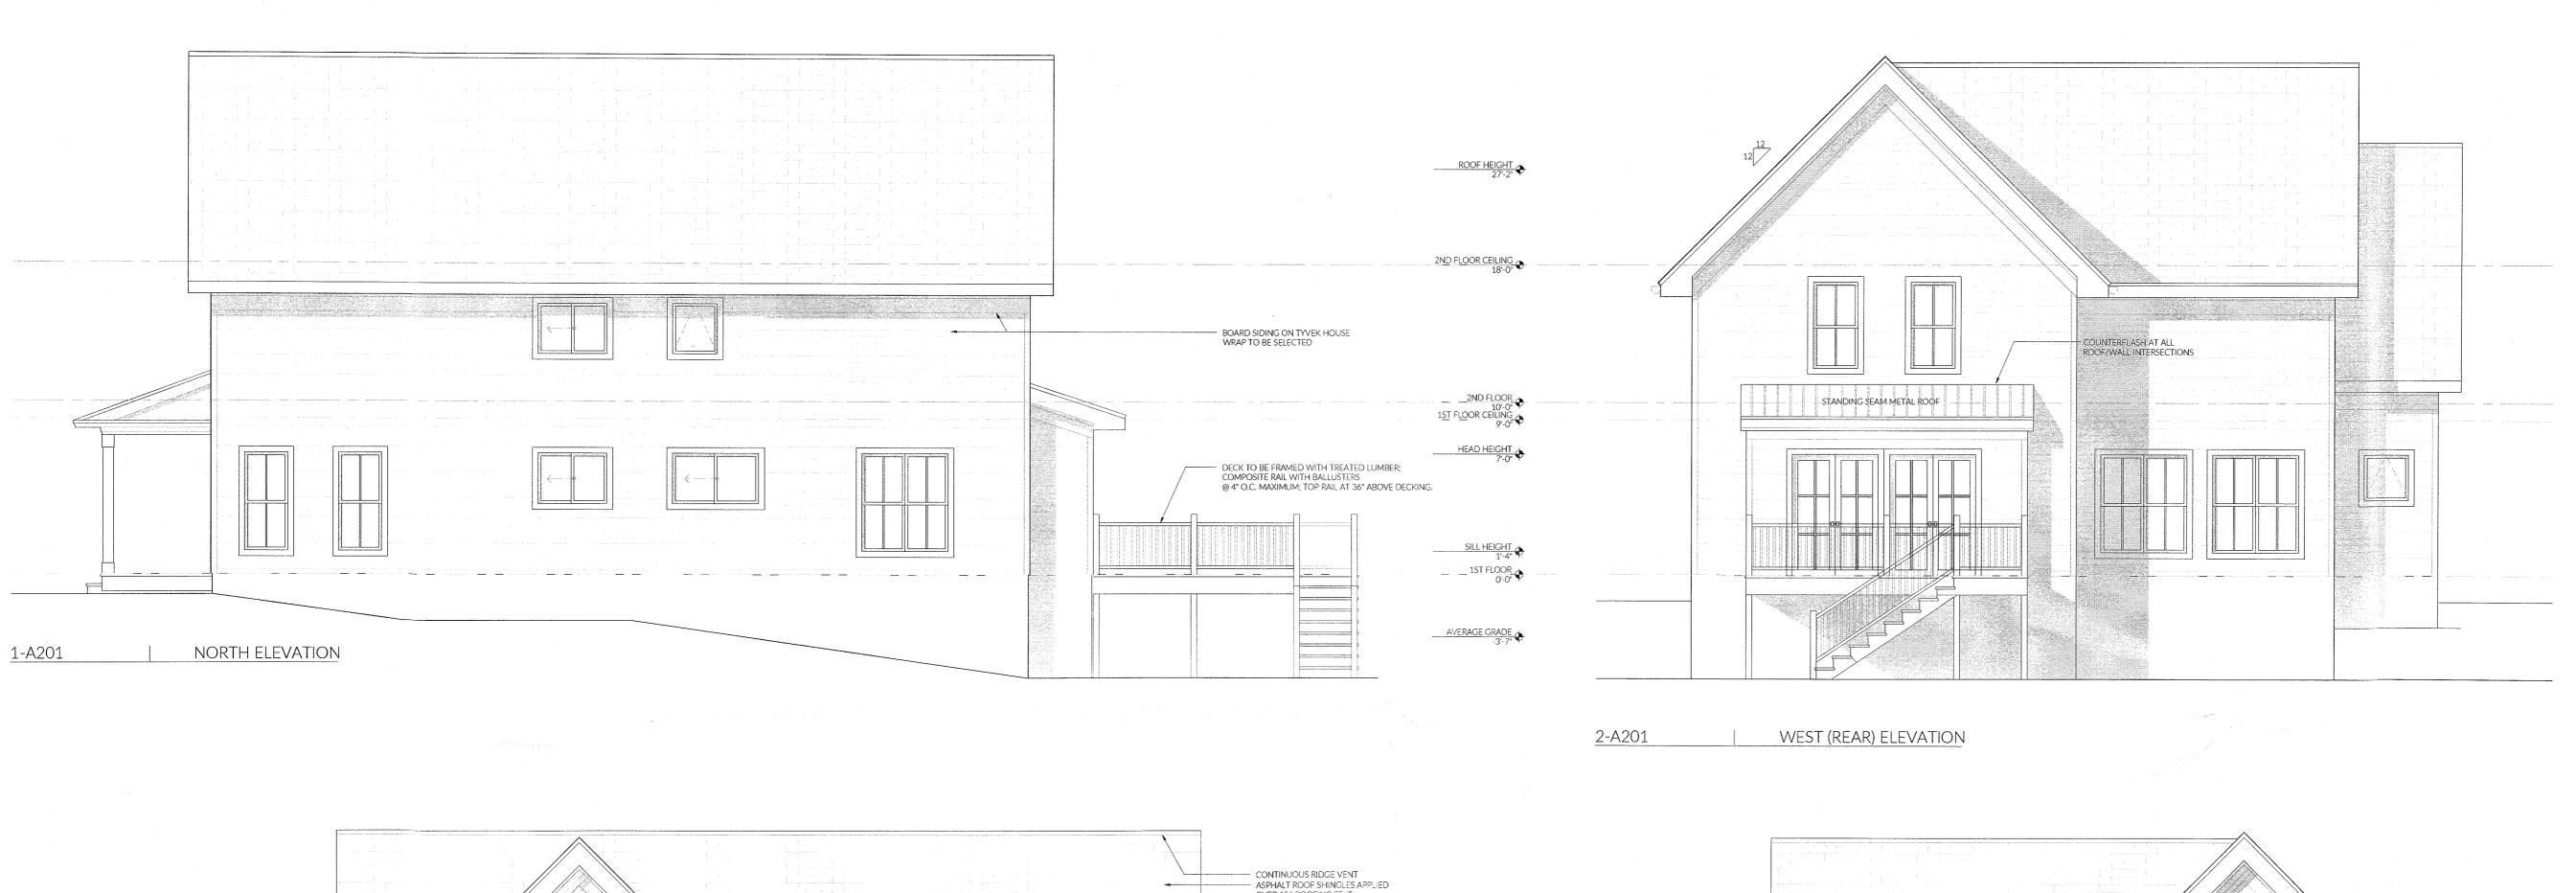

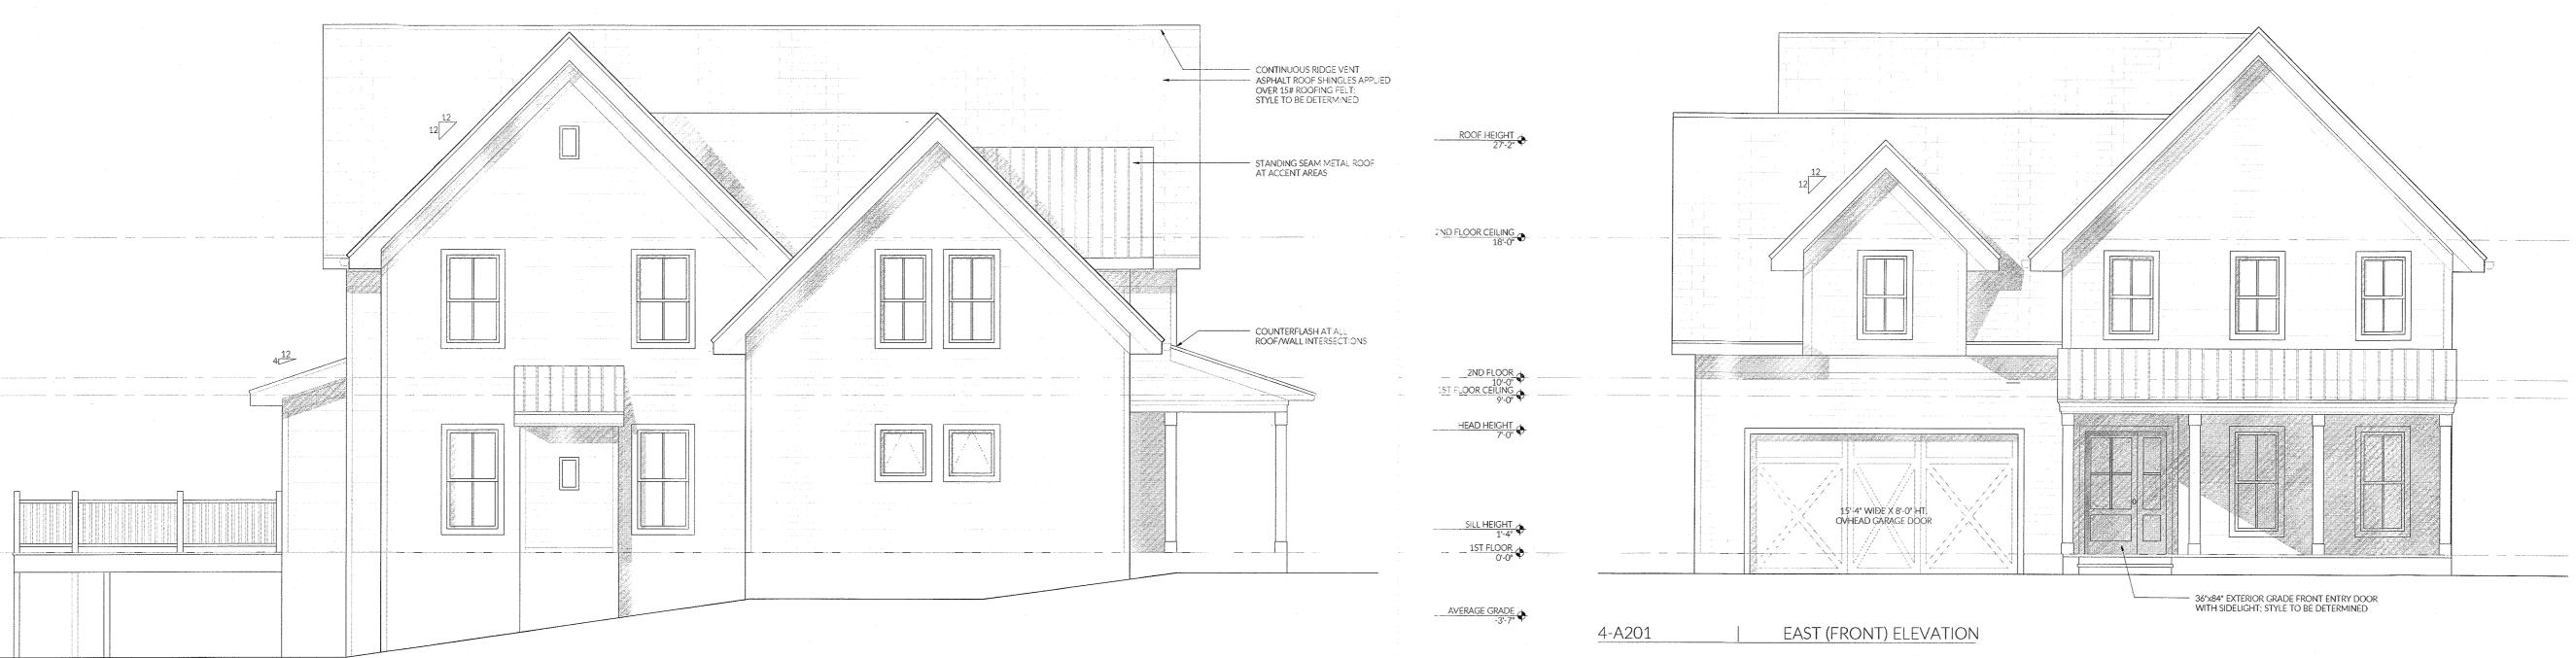

3-A201

SOUTH ELEVATION

02/15/2021 ISSUED FOR REVIEW

05/27/2021 ISSUED FOR REVIEW

10/08/2021 ISSUED FOR REVIEW ISSUANCE RECORD

OWNER:

GRIFF CONSTRUCTION, LLC 1 ROUNDHOUSE ROAD PIERMONT, NY 10968

ARCHITECT:

LUKE PETROCELLI, RA 51 STRATFORD RD, APT C3 BROOKLYN, NY 11218

PROJECT ADDRESS:


LOT #4 KINGS HIGHWAY SPARKILL, NY 10983

DRAWING TITLE: EXTERIOR ELEVATIONS SCALE: 3/16" = 1'-0"



DWG. NO.

04 OF 05 A 201.00

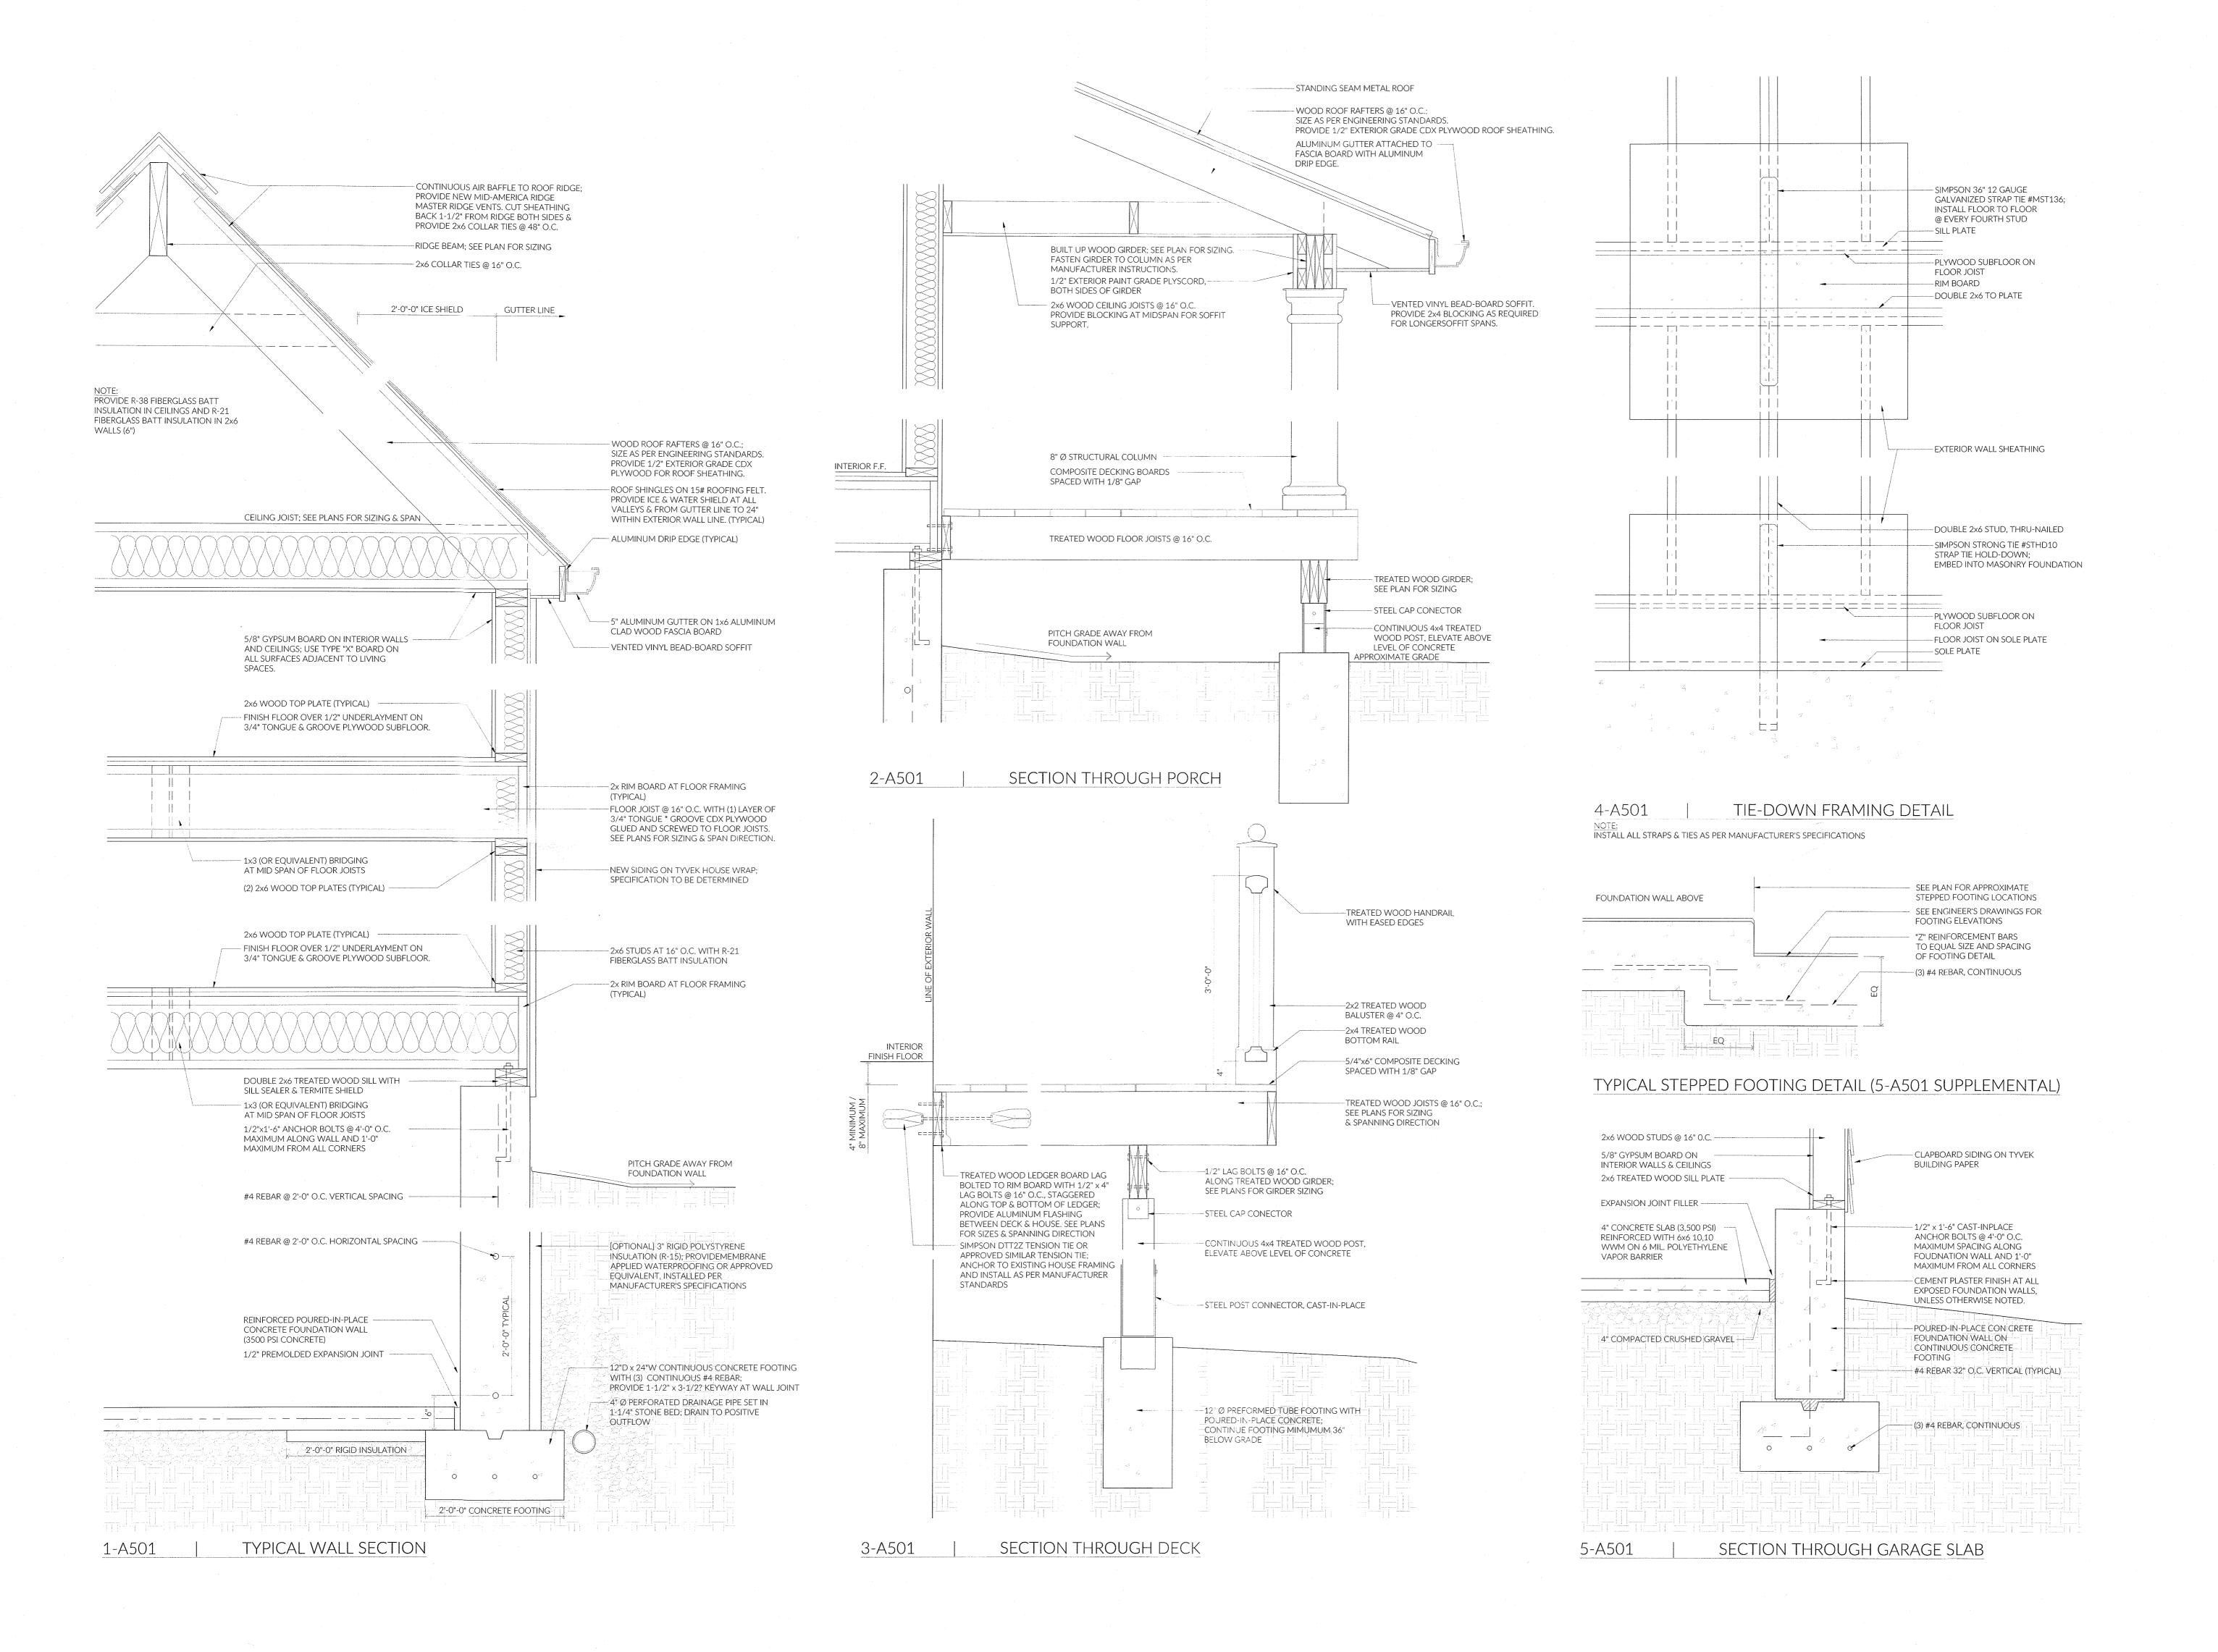

09/29/2020 **ISSUE FOR PRELIMINARY**

10/06/2020 ISSUED FOR FINAL REVIEW PRIOR TO FILING

05/27/2021 ISSUED FOR REVIEW

10/08/2021 ISSUED FOR REVIEW ISSUANCE RECORD

OWNER:

REVIEW

GRIFF CONSTRUCTION, LLC 1 ROUNDHOUSE ROAD PIERMONT, NY 10968

> ARCHITECT: LUKE PETROCELLI, RA

51 STRATFORD RD, APT C3 BROOKLYN, NY 11218

LOT #4 HARING DRIVE SPARKILL, NY 10983

PROJECT ADDRESS:

DRAWING TITLE:

TYPICAL DETAILS



1'' = 1' - 0''

05 OF 05

DWG. NO.

SCALE: