Name of Municipality: <u>TOWN OF ORANGETOWN</u>

Date Submitted: 3/10/2022

### 2022 LAND USE BOARD APPLICATION

	Please check all theCommercial Planning Board  Zoning Board of Appeals  Subdivision Number of Lots Site Plan Conditional Use  Special Permit Variance Performance Standards Review Use Variance Other (specify):	Residential  — Historical Board — Architectural Board — Consultation — Pre-Preliminary/Sketch — Preliminary — Final — Interpretation  PERMIT#: BLDR - 594 - 22  ASSIGNED INSPECTOR: Glend  Referred from Planning Board: YES / NO If yes provide date of Planning Board meeting:
Project	Name: Badillo	
Street A	Address: 67 chestnut	0 Val NY 10962
Tax Ma <sub>l</sub>	Section: Block: Block: Block:	Lot(s):
Directio	onal Location:	
10	side of CNESTOWN feet NOTH of the intersection ORANGETOWN in the hamlet/village of	of <u>cypress Lane</u> , in the
S	creage of Parcel 400 chool District 500th orange town mbulance District 0range town Vater District 506Z	Zoning District RG  Postal District Orange burg  Fire District Orange burg  Sewer District Orange to SA
Project Two	Description: (If additional space required, ple	Floor - Master  - Master book
The unde	rsigned agrees to an extension of the statutory time	,

### **APPLICATION REVIEW FORM**

## FILL IN WHERE APPLICABLE. (IF THE FOLLOWING DOES NOT APPLY PLEASE MOVE ON TO THE NEXT PAGE)

If subdivis	sion:
1)	Is any variance from the subdivision regulations required?
2)	Is any open space being offered? If so, what amount?
3)	Is this a standard or average density subdivision?
If site plan	ı <b>:</b>
1)	Existing square footage
2)	Total square footage
3)	Number of dwelling units
If special ( —	permit, list special permit use and what the property will be used for.
	ental Constraints:
Are there slo and net area	pes greater than 25%? If yes, please indicate the amount and show the gross
Are there stre	eams on the site? If yes, please provide the names
Are there we	lands on the site? If yes, please provide the names and type:
Project Hi	storv:
•	ect ever been reviewed before?
	a narrative, including the list case number, name, date, and the board(s) you appeared
•	ne status of any previous approvals.
	section, block & lot numbers for all other abutting properties in the same ownership as
-	



## OFFICE OF BUILDING, ZONING, PLANNING, ADMINISTRATION AND ENFORCEMENT TOWN OF ORANGETOWN

20 Greenbush Road Orangeburg, N.Y. 10962

Jane Slavin, R.A. Director

(845)359-8410

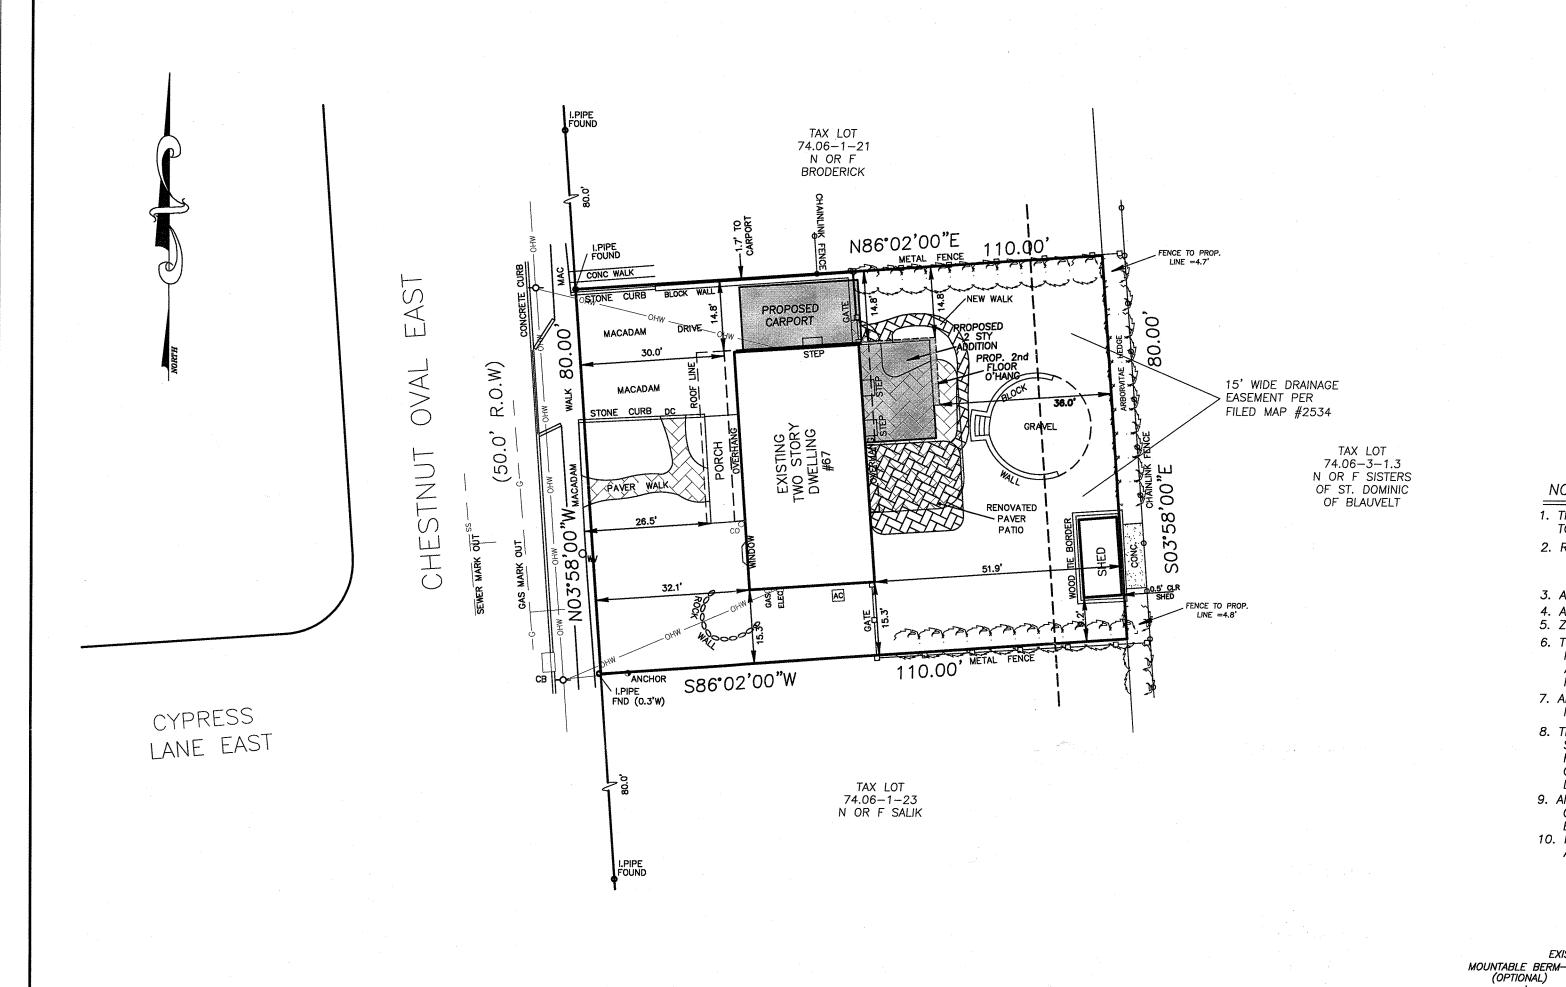
Fax: (845) 359-8526

## **DENIAL TO THE ZONING BOARD OF APPEALS**

Date: February 17, 2022	
Applicant: Badillo	
Address: 67 Chestnut Oval, Orangeburg, NY	
RE: Application Made at: same	
Chapter 43, Table 3.12, Column 1 RG District, Column 2 30% with 39.1% proposed, Column 9 Side Yard10' with proposed.  3 variances required	Group Q, Column 3 SFR, Column 4 Max FAR .7" proposed, Col 10 Total Side Yd 30' w/ 17'
Section:   74.06   Block:   1	Lot:22
	12 Lancing Landson
Please be advised that the Building Permit Application, w	nich you submitted on
February 10, 2022 , has been denied. I have enclosed a Xe at the bottom the reason for denial.	rox copy of your application, where you will find
In Accordance with Zoning, Chapter 43 Section 10.32	2 the time to appeal a determination of a
Building Inspector or Similar administrative office is	hirty (30) days from the filing of such a
determination with the Town Clerk.	
The Clerk to the Zoning Board of Appeals, Debbie Arbol	ino, will assist you in the preparation necessary to
appear before the board.	
Sincerely, 2 17-2	2
Richard Oliver Deputy Building Inspector	
( ) / / / / / / / / / / / / / / / / / /	2.71.00
	P
Signature of Director NOTE: PLEASE KEEP FOR YOUR RECORDS	Date CC: Rosanna Sfraga
12-31-18-CCC	Liz Decort

Debbie Arbolino

/IS	PRINT KEY	NAME	ADDRESS
2489	74.06-1-6	Marisa A Perez	34 Chestnut Oval, Orangeburg, NY 10962
?489	74.06-1-7	James Dunphy IV	38 Chestnut Oval, Orangeburg, NY 10962
2489	74.06-1-8	James S Phelan	42 Chestnut Oval, Orangeburg, NY 10962
:489	74.06-1-9	Lorraine Mc Grath	13 Catawba Dr,W Nyack, NY 10994
<b>?489</b>	74.06-1-10	Robert Smith	50 Chestnut Oval, Orangeburg, NY 10962
2489	74.06-1-11	Dimitrios Xanthopoulos	2 Cypress Ln, Orangeburg, NY 10962
<b>?489</b>	74.06-1-12	Heinz Litz	3 Cypress La,Orangeburg, NY 10962
2489	74.06-1-13	Carmini F Palermo	54 Chestnut Oval, Orangeburg, NY 10962
<b>?489</b>	74.06-1-14	Maria C Scolaro	58 Chestnut Oval, Orangeburg, NY 10962
<b>?489</b>	74.06-1-15	Howard L Goldenberg	62 Chestnut Oval, Orangeburg, NY 10962
<b>?489</b>	74.06-1-16	Philip Di Venere	43 Chestnut Oval, Orangeburg, NY 10962
<b>?489</b>	74.06-1-17	Joseph L Walsh	47 Chestnut Oval, Orangeburg, NY 10962
<b>?489</b>	74.06-1-18	Elvir Gacevic	51 Chestnut Oval E, Orangeburg, NY 10962
<b>?489</b>	74.06-1-19	Marie Ribaudo	55 Chestnut Oval, Orangeburg, NY 10962
:489	74.06-1-20	Salvatore Alfano	59 Chestnut Oval, Orangeburg, NY 10962
<b>?489</b>	74.06-1-21	Mathew J Broderick	63 Chestnut Oval, Orangeburg, NY 10962
2489	74.06-1-22	Daniel Badillo	67 Chestnut Oval, Orangeburg, NY 10962
:489	74.06-1-23	Parveen Salik	71 Chestnut Oval, Orangeburg, NY 10962
<b>?489</b>	74.06-1-24	Michael Mc Namee	75 Chestnut Oval, Orangeburg, NY 10962-0000
2489	74.06-1-25	Daniel Lee	79 Chestnut Oval, Orangeburg, NY 10962
2489	74.06-1-26	Kenneth J Mc Closkey	83 Chestnut Oval, Orangeburg, NY 10962
?489	74.06-1-27	Saverio Addino	87 Chestnut Oval, Orangeburg, NY 10962
<b>?489</b>	74.06-1-46	Christopher M Farrell	70 Chestnut Oval, Orangeburg, NY 10962
2489	74.06-1-47	Dominick A Russo Jr	74 Chestnut Oval E, Orangeburg, NY 10962
<b>?489</b>	74.06-1-48	Anthony Fugazzotto	119 Chestnut Oval, Orangeburg, NY 10962
<b>?489</b>	74.06-1-59	Samantha M Alpert	15 Cypress Ln, Orangeburg, NY 10962
<b>?489</b>	74.06-1-60	Toni A Farr	11 Cypress Ln, Orangeburg, NY 10962
<b>?489</b>	74.06-1-61	John Dellacava	7 Cypress Ln, Orangeburg, NY 10962
2489	74.06-1-62	David Mendell	6 Cypress Ln, Orangeburg, NY 10962
<b>?489</b>	74.06-1-63	Matthew Garzia	10 Cypress Ln,Orangeburg, NY 10962
2489	74.06-1-64	William S Egan	14 Cypress La, Orangeburg, NY 10962
?489	74.06-1-65	Fred Del Rosso	18 Cypress Ln, Orangeburg, NY 10962
2489	74.06-3-1.2	Dominican College	470 Western Hwy, Blauvelt, NY 10913
<u>?489</u>	74.06-3-1.3	Dominican College of Blauvelt	470 Western Hwy, Orangeburg, NY 10913



EAST 61 12 겂 25 4 39 VICINITY MAP NOTES:

1. THIS IS A SITE PLAN OF TAX LOT 74.06-1-22 AS SHOWN ON THE TOWN OF ORANGETOWN TAX MAPS.

2. RECORD OWNER:

3. APPLICANT: SAME

4. AREA = 10,171 SF

EXISTING PAVEMENT-

EXISTING PAVEMENT

5. ZONE: R-15

- 6. THIS PLAT DOES NOT CONFLICT WITH THE COUNTY OFFICIAL MAP, AND 8. THIS PLAT DOES NOT CONFLICT WITH THE COUNTY OFFICIAL MAP, AND HAS BEEN APPROVED IN THE MANNER SPECIFIED BY SECTION 239 L&M OF THE GENERAL MUNICIPAL LAW OF THE STATE OF NEW YORK.
- 7. ALL UTILITIES, INCLUDING ELECTRIC AND TELEPHONE SERVICE SHALL BE INSTALLED UNDERGROUND.
- 8. THIS PLAT IS SUBJECT TO DETAILS OF GRADING, ROADS AND UTILITIES AS SHOWN ON CONSTRUCTION PLANS APPROVED BY THE PLANNING BOARD AND FILED WITH THE TOWN CLERK. LOT DRAINAGE SHOWN ON SUCH PLANS SHALL CONSTITUTE EASEMENTS RUNNING WITH THE LAND & SHALL NOT BE DISTURBED.
- 9. ANY EXISTING UTILITIES ( POLES, HYDRANTS, ETC.) AFFECTED BY CONSTRUCTION OF THIS SITE PLAN SHALL BE RÉLOCATED AT THE DEVELOPERS EXPENSE PRIOR TO THE ISSUANCE OF ANY CERTIFICATE OF OCCUPANCY.

10. NO BUILDING PERMIT SHALL BE ISSUED UNTIL SITE PLANS HAVE BEEN APPROVED BY ACABOR.

## VOVEN WIRE FENCE (MIN. 14 1/2 GAUGE VAX. 6" MESH SPACING) 2. FILTER CLOTH TO BE FASTENED SECURELY FLOW PERSPECTIVE VIEW

SECTION

### CONSTRUCTION NOTES FOR FABRICATED SILT FENCE

1. WOVEN WIRE FENCE TO BE FASTENED SECURELY TO FENCE POSTS WITH WIRE TIES OR STAPLES.

POSTS: STEEL EITHER "T" OR "U" TYPE OR 2" HARDWOOD. FENCE: WOVEN WIRE 14 1/2 GA. 6" MAX. MESH OPENING.

TO WOVEN WIRE FENCE WITH TIES SPACED EVERY 24" AT TOP AND MID SECTION. 3. WHEN TWO SECTIONS OF FILTER CLOTH ADJOIN EACH OTHER THEY SHALL BE OVERLAPPED BY SIX INCHES AND FOLDED.

FILTER CLOTH: FILTER X, MIRAFI 100X, STABILINKA T140N, OR APPROVED EQUAL. PREFABRICATED GEOFAB, ENVIROFENCE, UNIT: OR APPROVED EQUAL.

4. MAINTENANCE SHALL BE PERFORMED AS NEEDED AND MATERIAL REMOVED WHEN "BULGES" DEVELOP IN THE SILT FENCE.

WIRE REINFORCED SILT FENCE NTS

## WOVEN WIRE FENCE (14 1/2 GA. MIN. MAX. 6" MESH SPACING) WITH FILTER CLOTH OVER – 36" MIN. FENCE POST - 20" MIN. - UNDISTURBED GROUND REFERENCE: BEING LOT #21 AS SHOWN ON A FILED MAP ENTITLED "MAP OF ROCKLAND, SECTION II; SANDRA CONSTRUCTION CO, INC" FILED APR. 26, 1957 AS MAP

## 19, 1957 AS MAP #2534. **LEGEND**

#2496 AND "MAP OF ROCKLAND, SECTION II" FILED NOV.

□ CB	□₽	CATCH BASIN/FIELD INLET
		DRAIN LINE
-s	<del>IH</del> S	SANITARY MANHOLE / PIPE
didi	_//	EDGE OF PAVEMENT
	<del></del>	CONCRETE CURB
G	-⇔ <del>GV</del> G	GAS LINE
W	O <mark>W/-</mark> -W	WATER LINE
-0-	•••	UTILITY POLE
*		LIGHT POLE
ОНW		OVERHEAD WIRES
	-UE	UNDERGROUND ELECTRIC

	BULK REGU	JLATIONS	- RG -	- SINGLE	<b>FAMILY</b>	RESIDEN	CE GRO	UP "Q"	
	MIN LOT AREA	MIN LOT WIDTH	MIN STREET FRONTAGE	MIN FRONT YARD	MIN SIDE YARD	TOTAL SIDE YARDS	MIN REAR YARD	MAX BLDG HEIGHT	MAX F.A.R.
REQUIRED	10,000 SF	75 Ft	50 Ft	25 FT	10 Ft	30 Ft	25 Ft	1'4"/FT	0.30
EXISTING	8800 SF 🕇	80.0'	80.0	26.5'	14.8'	30.1	51.9'	25 <b>'</b> ±	0.295
PROPOSED	NO CHANGE +	NO CHANGE	NO CHANGE	NO CHANGE	1.7' *	17.5' 🛊	36.0'	NO CHANGE	0.391 🖈

\* VARIANCE REQUIRED

TNOTE: PARCEL WAS DEVELOPED IN ACCORDANCE WITH FILED MAP #2496, AND IS A PRE-EXISTING NON-CONFORMING LOT.

## CONSTRUCTION SPECIFICATIONS

- 1. STONE SIZE USE 2" STONE, OR RECLAIMED OR RECYCLED CONCRETE EQUIVALENT.
- 2. LENGTH NOT LESS THAN 50 FEET (EXCEPT ON A SINGLE RESIDENCE LOT WHERE A 30 FOOT MINIMUM LENGTH WOULD APPLY.)
- 3. THICKNESS NOT LESS THAN (6) INCHES.
- 4. WIDTH TWELVE (12) FOOT MINIMUM. BUT NOT LESS THAN THE FULL WIDTH AT POINTS WHERE INGRESS OR EGRESS OCCURS. TWENTY—FOUR (24) FOOT IF SINGLE ENTRANCE TO SITE.
- 5. FILTER CLOTH WILL BE PLACED OVER THE ENTIRE AREA PRIOR TO PLACING OF STONE. 6. SURFACE WATER — ALL SURFACE WATER FLOWING OR DIVERTED TOWARD CONSTRUCTION ENTRANCES SHALL BE PIPED ACROSS THE ENTRANCE. IF PIPING IS IMPRACTICAL, A MOUNTING BERM WITH STANDARD WILL BE PROMITTED.
- 7. MAINTENANCE THE ENTRANCE SHALL BE MAINTAINED IN A CONDITION WHICH WILL PREVENT TRACKING OR FLOWING OF SEDIMENT ONTO PUBLIC RIGHTS—OF—WAY. ALL SEDIMENT SPILLED, DROPPED, WASHED OR TRACKED ONTO PUBLIC RIGHTS—OF—WAY MUST BE REMOVED IMMEDIATELY.
- 8. WHEN WASHING IS REQUIRED, IT SHALL BE DONE ON AN AREA STABILIZED WITH STONE AND WHICH DRAINS INTO AN APPROVED SEDIMENT TRAPPING DEVICE.
- 9. PERIODIC INSPECTION AND NEEDED MAINTENANCE SHALL BE PROVIDED AFTER EACH RAIN,

## STABILIZED CONSTRUCTION ENTRANCE

PHONE

NTS

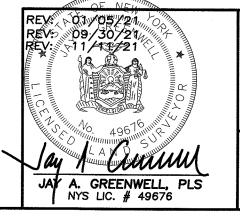
50' MINIMUM

PLAN VIEW

12' MIN.

PROFILE

APR 2 0 2022



FILTER CLOTH- 6" MIN.

-EXISTING GROUND

EXISTING GROUND

STANDARD SYMBOL

F	2L	<u>O</u>	Τ	PL	A٨	1 1	FO	R

**BADILLO** TOWN OF ORANGETOWN

ROCKLAND COUNTY, NEW YORK

JAY A. GREENWELL, PLS, LLC LAND SURVEYING - LAND PLANNING 85 LAFAYETTE AVENUE, SUFFERN, NEW YORK, 10901 PHONE 845-357-0830 FAX 845-357-0756 © 2020 JAY A GREENWELL, PLS, LLC

DATE 01/04/21 JOB NO. 22063

TAX LOT #

74.06-1-22

8800 SF FILE 22063PP

SCALE

1"= 20'

#### **GENERAL NOTES:**

- 1. ALL CONSTRUCTION METHODS SHALL CONFORM TO THE TOWN OF ORANGETOWN BUILDING CODE. THE 2020 NEW YORK STATE RESIDENTIAL BUILDING CODE AND REGULATIONS OF ALL OTHER AGENCIES HAVING JURISDICTION.
- 2. ALL EXISTING CONDITIONS TO BE VERIFIED IN FIELD. CONTRACTOR TO NOTIFY OWNER/ ARCHITECT OF ANY DISCREPANCY PRIOR TO CONSTRUCTION OR IMMEDIATELY **UPON DISCOVERY.**
- 3. UPGRADE EXISTING ELECTRICAL AS REQ'D, INCLUDING SERVICE, DEDICATED CIRCUITS, GFIC OUTLETS IN KITCHEN & BATHS, AS REQ'D TO MEET ALL APPLICABLE CODES AND SAFETY STANDARDS. ALL WORK TO BE PERFORMED BY A CONTRACTOR LICENSED IN ROCKLAND COUNTY.
- 4. UPGRADE ALL PLUMBING SUPPLY LINES, PROVIDE VENTING AND MAINTAIN CONSTANT SLOPE IN ALL WASTE LINES. UPGRADE HEATING SYSTEM TO PROVIDE ADEQUATE HEATING THROUGHOUT. PROVIDE NEW HOT-WATER BASEBOARD RADIATORS TIED INTO EXISTING SYSTEM TO MEET STANDARD HEATING REQUIREMENTS. ALL PLUMBING WORK TO BE PERFORMED TO MEET ALL APPLICABLE CODES BY A PLUMBING CONTRACTOR LICENSED IN ROCKLAND COUNTY.

#### **DEMOLITION NOTES:**

- 1. ALL EXISTING CONSTRUCTION TO REMAIN TO BE SHORED ADEQUATELY WITH TEMPORARY BRACING PRIOR TO ANY REMOVALS. 2. CONTRACTOR TO TAKE EXTREME CAUTION NOT TO DAMAGE ANY WORK TO REMAIN.
- 3. CONTRACTOR TO BE RESPONSIBLE FOR REMOVAL AND DISPOSAL OF ALL DEMOLISHED MATERIAL AND CONSTRUCTION DEBRIS. DEBRIS, DUST AND DIRT TO BE KEPT TO A MINIMUM, AND TO BE CLEARED FROM SITE PERIODICALLY TO PREVENT EXCESSIVE ACCUMULATION.
- 4. AT AREAS TO RECEIVE NEW FINISH FLOORING, REMOVE ALL EXISTING FLOORING. REPAIR, LEVEL AND PREPARE SURFACE TO RECEIVE NEW FINISHES - TYPICAL
- 5. CONTRACTOR TO NOTIFY ARCHITECT IMMEDIATELY UPON DISCOVERY OF ANY UNFORESEEN STRUCTURAL CONDITIONS, THESE CONDITIONS TO BE REVIEWED BY ARCHITECT AND A STRUCTURAL ENGINEER IF NECESSARY TO DETERMINE ANY FURTHER ACTION REQUIRED.

#### **DESIGN LOADS (Micucci Engineering):**

FLOOR LOADS per ASCE 7-10

DEAD LOAD: 12 PSF - 2X10 JOIST AT 16" O.C., 3/4" SUBFLOOR & MISC. LIVE LOAD: 30 PSF - HABITABLE ATTICS & SLEEPING AREA 40 PSF - ALL OTHER AREAS EXCEPT STAIRS

UNOCCUPIED ATTIC SPACE: 5 PSF DL + 20 PSF LL = 25 PSF **ROOF LOADS:** 

DEAD LOAD: 20 PSF - 2x10S AT 16"oc 5/8" SHEATHING & SHINGLE ROOFING LIVE LOAD: 30 PSF

## **ASCE 7-10 DESIGN CRITERIA**

**ROOF SNOW LOADS:** 

GROUND SNOW LOAD (Pg): 30 PSF FLAT ROOF SNOW LOAD (Pf): 21.0 PSF SNOW EXPOSURE FACTOR (Ce): 1.0 SNOW LOAD IMPORTANCE FACTOR (Is): 1.0 THERMAL FACTOR (Ct): 1.0

**WIND LOADS:** 

ULTIMATE DESIGN WIND SPEED (Vult): 115 MPH RISK CATEGORY: II WIND EXPOSURE CATEGORY: B INTERNAL PRESSURE COEFFICIENT: +/- 0.18

**CONSTRUCTION NOTES:** 

- 1. ALL DIMENSIONS GIVEN ARE TO FACE OF GYPSUM BOARD UNLESS OTHERWISE NOTED.
- 2. PARTITIONS SHOWN ALIGNED WITH EXISTING CONSTRUCTION SHALL BE FLUSH AND SMOOTH WITH EXISTING SURFACES U.O.N.
- 3. DO NOT SCALE DRAWINGS, DIMENSIONS GOVERN.
- 4. ALL FRAMING MEMBERS SHALL BE DOUGLAS FIR NO. 2 OR BETTER, SURFACE DRY WITH 19% MAX MOISTURE CONTENT. FB = 850 PSI MIN., FV- = 95 PSI, FC = 625 PSI, E = 1,600,000 PSI.
- 5. ALL FRAMING MEMBERS (LEDGERS, SILL PLATES, ETC.) THAT TIE NEW CONSTRUCTION INTO EXISTING ARE TO BE SECURED WITH 3/8" x 5" (MIN.) LAG BOLTS @ 16" O.C. MIN. INTO EXISTING HOUSE STRUCTURAL FRAMING (NOT SHEATHING ONLY).
- 6. INSTALL FIRE-BLOCKING WHEREEVER POSSIBLE IF EXISTING STRUCTURE IS BALLOON FRAMING THAT BECOMES EXPOSED AT SECOND FLOOR LEVEL.
- 7. ALL ENGINEERED FRAMING MEMBERS ARE TO BE BY TRUS JOIST WEYERHAEUSER OR APPROVED EQUAL.
- 8. STRUCTURAL MEMBERS SHALL NOT BE CUT FOR PIPES, ETC. UNLESS SPECIFICALLY NOTED OR APPROVED BY THE ARCHITECT OR STRUCTURAL ENGINEER IN ADVANCE.
- 9. ALL STRUCTURAL LUMBER AND FASTENINGS SHALL CONFORM TO THE MINIMUM REQUIREMENTS OF TABLE 2304.9.1 OF THE IBC, LATEST EDITION.
- 10. ROOF SHEATHING SHALL BE 19/32" MIN. A.P.A. RATED SHEATHING 32/16 EXPOSURE I. LAY FACE GRAIN AT RIGHT ANGLE TO SUPPORTS. PROVIDE 1/8" SPACE BETWEEN SHEETS AT END AND SIDE JOINTS. SHEATHING SHALL BE CONTINUOUS OVER A MIN. OF TWO SPANS. PROVIDED 10D COMMMON NAILS AT 6" OC ALONG SUPPORTED EDGES AND 12" OC ALONG INTERMEDIATE SUPPORTS. PROTECT ROOF SHEATHING FROM MOISTURE UNTIL ROOFING IS INSTALLED.
- 11. INSTALL NEW WINDOWS & DOORS AT NEW LOCATIONS AS SHOWN ON PLANS; PATCH & REPAIR EXISTING WALLS & EXTERIOR CLADDING AS REQ'D.
- 12. INSTALL NEW 5/8" G.W.B. @ ALL NEW INTERIOR WALLS & CEILINGS, U.O.N. PATCH, REPAIR AND/OR PREPARE ALL EXISTING CONSTRUCTION AT AREAS TO ACCEPT NEW, AND WHERE AFFECTED BY DEMOLITION AND CONSTRUCTION.
- 13. INSTALL FINISH FLOORING OVER 3/4" T&G PLYWOOD SUBFLOOR -TYP UON.
- 14. ALL NEW INTERIOR DOORS TO BE SOLID WOOD PANELED DOORS TO MATCH EXISTING AS CLOSELY AS POSSIBLE. HARDWARE TO MATCH EXISTING, REVIEW WITH OWNER.
- 15. ALL INSTALLATION OF MATERIALS, DEVICES, APPLIANCES, FIXTURES, ETC. TO BE AS PER MANUFACTURER'S SPECIFICATIONS AND RECOMMENDATIONS AND AS PER ALL APPLICABLE CODES.
- 16. PROVIDE VAPOR BARRIER AT EXTERIOR SIDE OF ALL NEW CONCRETE FOUNDATION WALLS CONTINUOUSLY FROM FOOTING TO TOP OF GRADE.

#### **TABLE R301.2(1)** CLIMATIC AND GEOGRAPHIC DÉSIGN CRITERIA

GROUND	·	WIND	DESIGN		SEISMIC	SUBJECT	TO DAMAGE	FROM	WINTER	ICE BARRIER	FLOOD	AIR	MEAN
SNOW LOAD°	Speed <sup>d</sup> (mph)	Topographic effects <sup>k</sup>	Special wind region <sup>t</sup>	Windborne debris zone <sup>m</sup>	DESIGN CATEGORY	Weathering	Frost line depth <sup>b</sup>	Termite <sup>c</sup>	DESIGN TEMP°	UNDERLAYMENT REQUIRED <sup>h</sup>	HAZARDS <sup>9</sup>	FREEZING INDEX <sup>i</sup>	ANNUAL TEMP <sup>i</sup>
		, , , , , , , , , , , , , , , , , , ,		and the state of t									

### **LIST OF DRAWINGS**

**GENERAL NOTES** A-0.1

FIRST FLOOR WITH SITE A-1.0

A-1.1 FIRST FLOOR CONSTRUCTION PLAN FIRST FLOOR - POWER & LIGHTING

A-1.2 SECOND FLOOR PLAN A-2.1

SECOND FLOOR - POWER & LIGHTING A-2.2

**ROOF PLAN** A-3.1

NORTH ELEVATION (FRONT) A-4.1

WEST ELEVATION (SIDE) & FTG DETAIL A-4.2

SOUTH ELEVATION (REAR) A-4.3

A-4.4 EAST ELEVATION (SIDE)

SECTION @ 2-story ADDITION A-5.1

A-5.2 FRAMING DETAILS

INTERIOR ELEVATIONS - FAMILY ROOM A-6.1

INTERIOR ELEVATIONS - MASTER BATH A-6.2

#### **ENERGY NOTES:**

- 1. THIS BUILDING DESIGN IS BY ACCEPTABLE PRACTICE AND SHALL COMPLY WITH THE CURRENT NEW YORK STATE ENERGY CONSERVATION CONSTRUCTION CODE.
- 2. ALL INSTALLATIONS AND MATERIALS SHALL BE IN CONFORMANCE WITH THE NEW YORK STATE ENERGY CODE.
- 3. ALL NEW CONSTRUCTION TO ACHIEVE THE FOLLOWING MIN. INSULATION VALUES: HIGH DENSITY BATT IN WALLS = R-21 AND FLOORS = R-30; CLOSED CELL SPRAY FOAM IN ROOF FRAMING = R-49.
- 4. WHEREEVER EXISTING FRAMING IS EXPOSED, INSTALL HIGH-DENSITY BATT INSULATION OR SPRAYED IN FOAM TO ACHIEVE HIGHEST R-VALUE POSSIBLE WITHIN EXISTING SPACE. FULLY SEAL ALL AIR PENETRATIONS
- 5. ALL EXTERIOR OPENINGS SHALL BE PROPERLY FLASHED AND WEATHER-STRIPPED. ALL WINDOWS TO BE .32 U-VALUE OR LOWER WITH LOW E 2 ARGON INSULATED GLASS. ALL DOORS AND WINDOWS TO BE MARVIN, OR APPROVED EQUAL.
- 6. PROVED THERMAL ENVELOP WITH CONTINUOUS INSULATION AND AIR BARRIER AND SEAL ALL JOINTS, CORNERS, SILL PLATES, TOP PLATES AND PENETRATIONS PER SECTION R402 OF THE ENERGY CODE.

### **SMOKE DETECTOR NOTES:**

- 1. PROVIDE SMOKE DETECTORS IN BEDROOMS AND HALLWAYS (TO EXTENT POSSIBLE WITHIN SCOPE OF CONSTRUCTION). SMOKE DETECTORS TO BE HARD-WIRED WITH BATTERY BACKUP, INTERCONNECTED AND INSTALLED PER MFR'S SPECIFICATIONS AND TO MEET ALL APPLICABLE CODES.
- 2. UNITS SHALL BE LOCATED ON OR NEAR THE CEILING. CEILING MOUNT - CLOSEST EDGE OF UNIT SHALL BE A MINIMUM OF 4" AWAY FROM ANY WALLS. WALL MOUNT -CLOSEST EDGE SHALL BE A MINIMUM OF 4" AWAY FROM THE CEILING.
- 3. PROVIDE (1) COMBINATION CARBON MONOXIDE & SMOKE DETECTOR PER DWELLING

## Badillo Residence

## 67 Chestnut Oval Orangeburg, NY

**County of Rockland** 

architect

## Margaret Fowler Architect LLC

NYS license #024528-1 500 North Broadway Upper Nyack, NY 10960 t: (845) 680-9475 megfowlerarchitect@gmail.com



previously issued

issue

date 11/12/2021 scale

drawing title

**General Notes** 

# 67 Chestnut Oval Orangeburg, NY

## **County of Rockland**

architect

Margaret Fowler Architect LLC

NYS license #024528-1
500 North Broadway
Upper Nyack, NY 10960
t: (845) 680-9475
megfowlerarchitect@gmail.com



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date 11/12/2021 scale

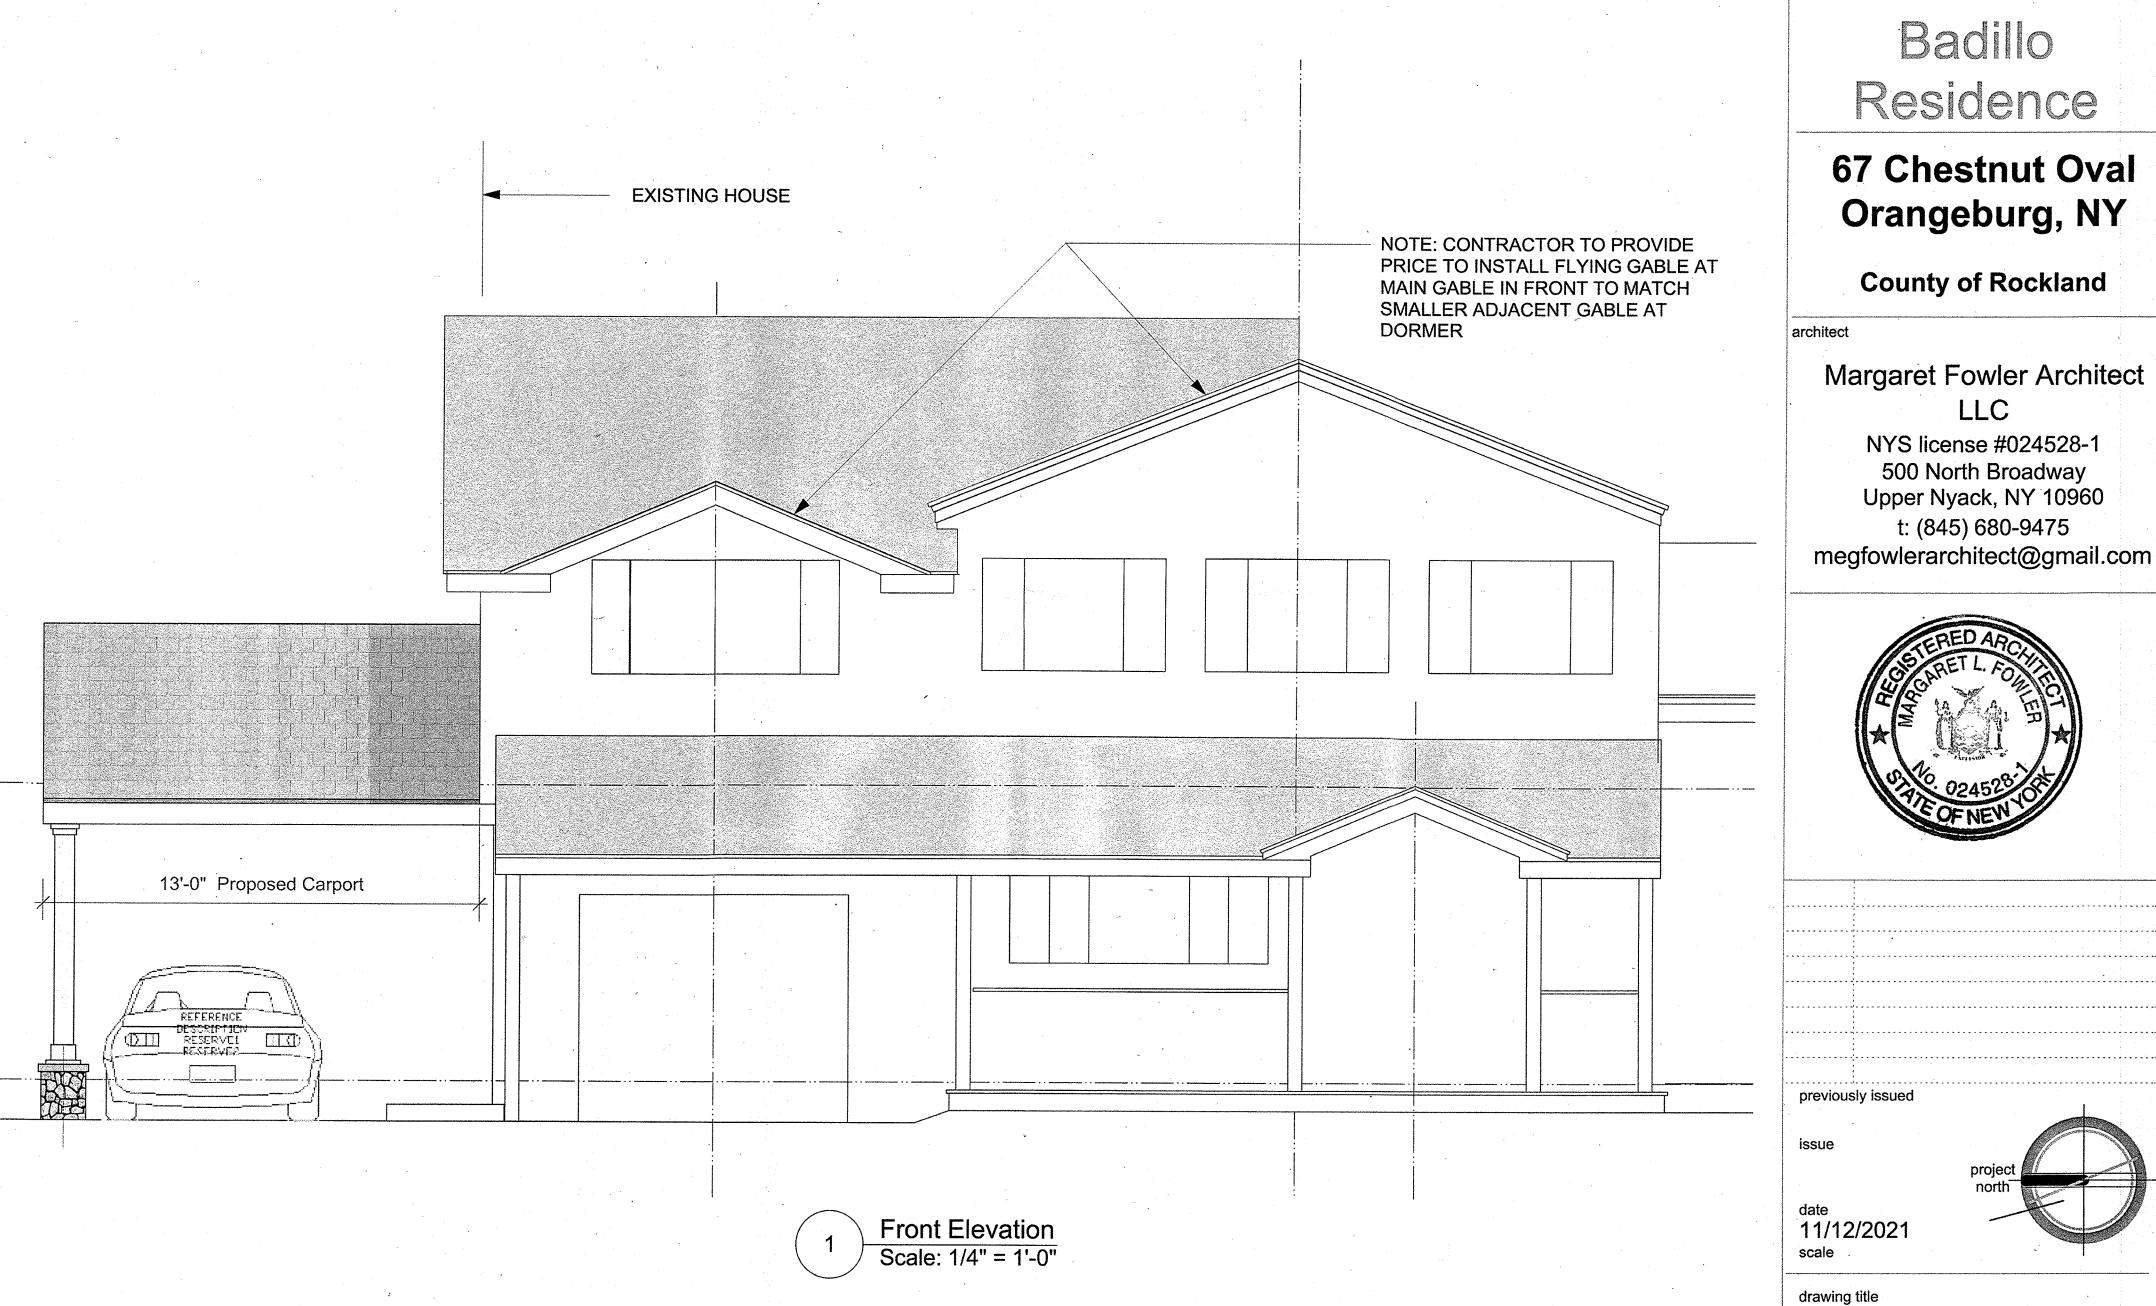
drawing title

Roof Plan

A-3.1

2x10 ridge

x8 RR @ 16" OC



## **67 Chestnut Oval** Orangeburg, NY

**County of Rockland** 

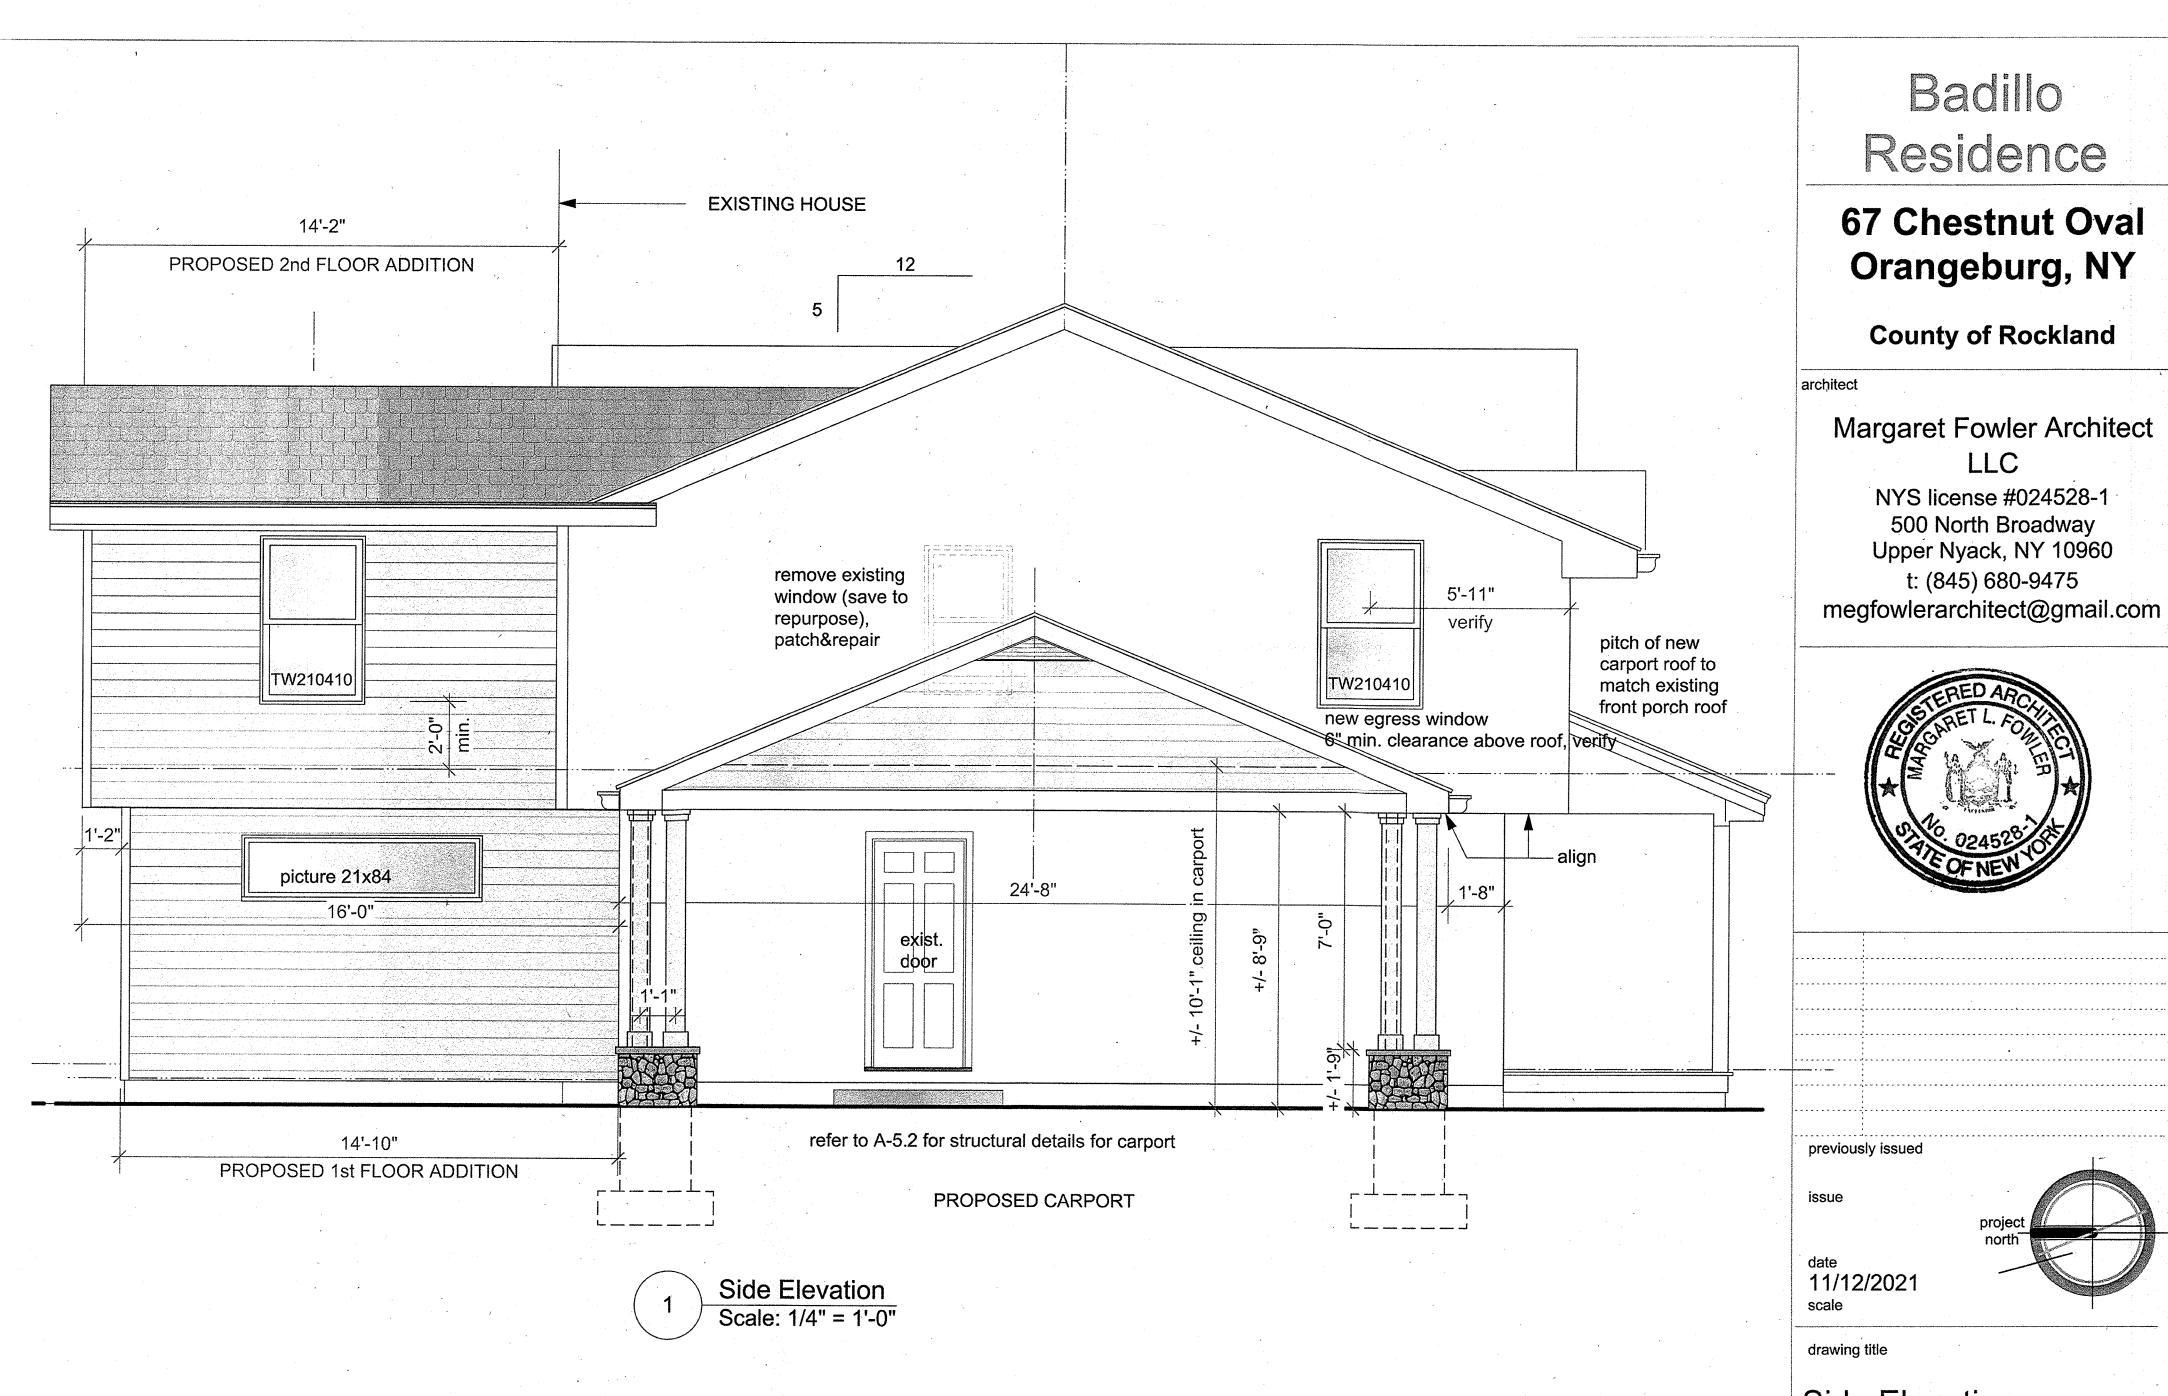
# Margaret Fowler Architect

NYS license #024528-1 500 North Broadway Upper Nyack, NY 10960 t: (845) 680-9475




30		
	(*************************************	

Front Elevation



Side Elevation

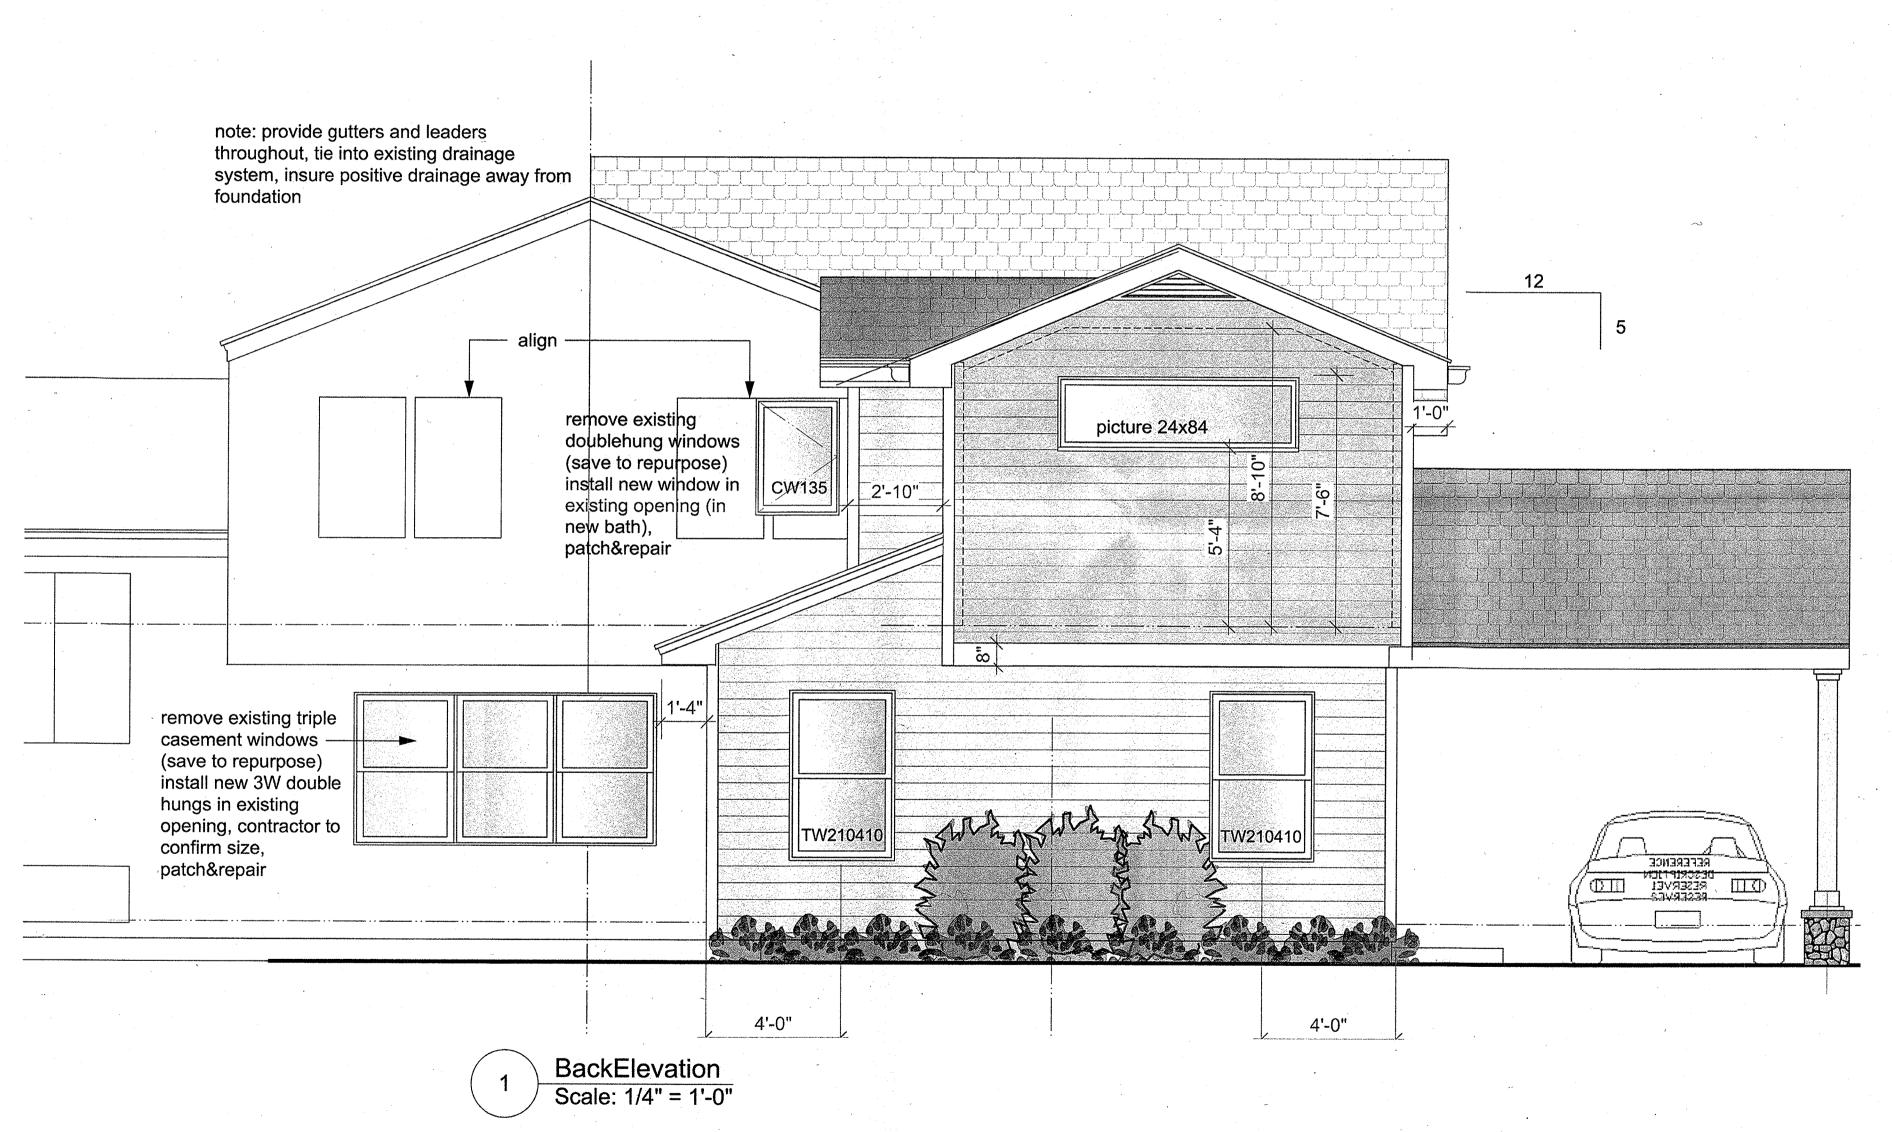A-4 2



# 67 Chestnut Oval Orangeburg, NY

**County of Rockland** 

archite

# Margaret Fowler Architect LLC

NYS license #024528-1
500 North Broadway
Upper Nyack, NY 10960
t: (845) 680-9475
megfowlerarchitect@gmail.com



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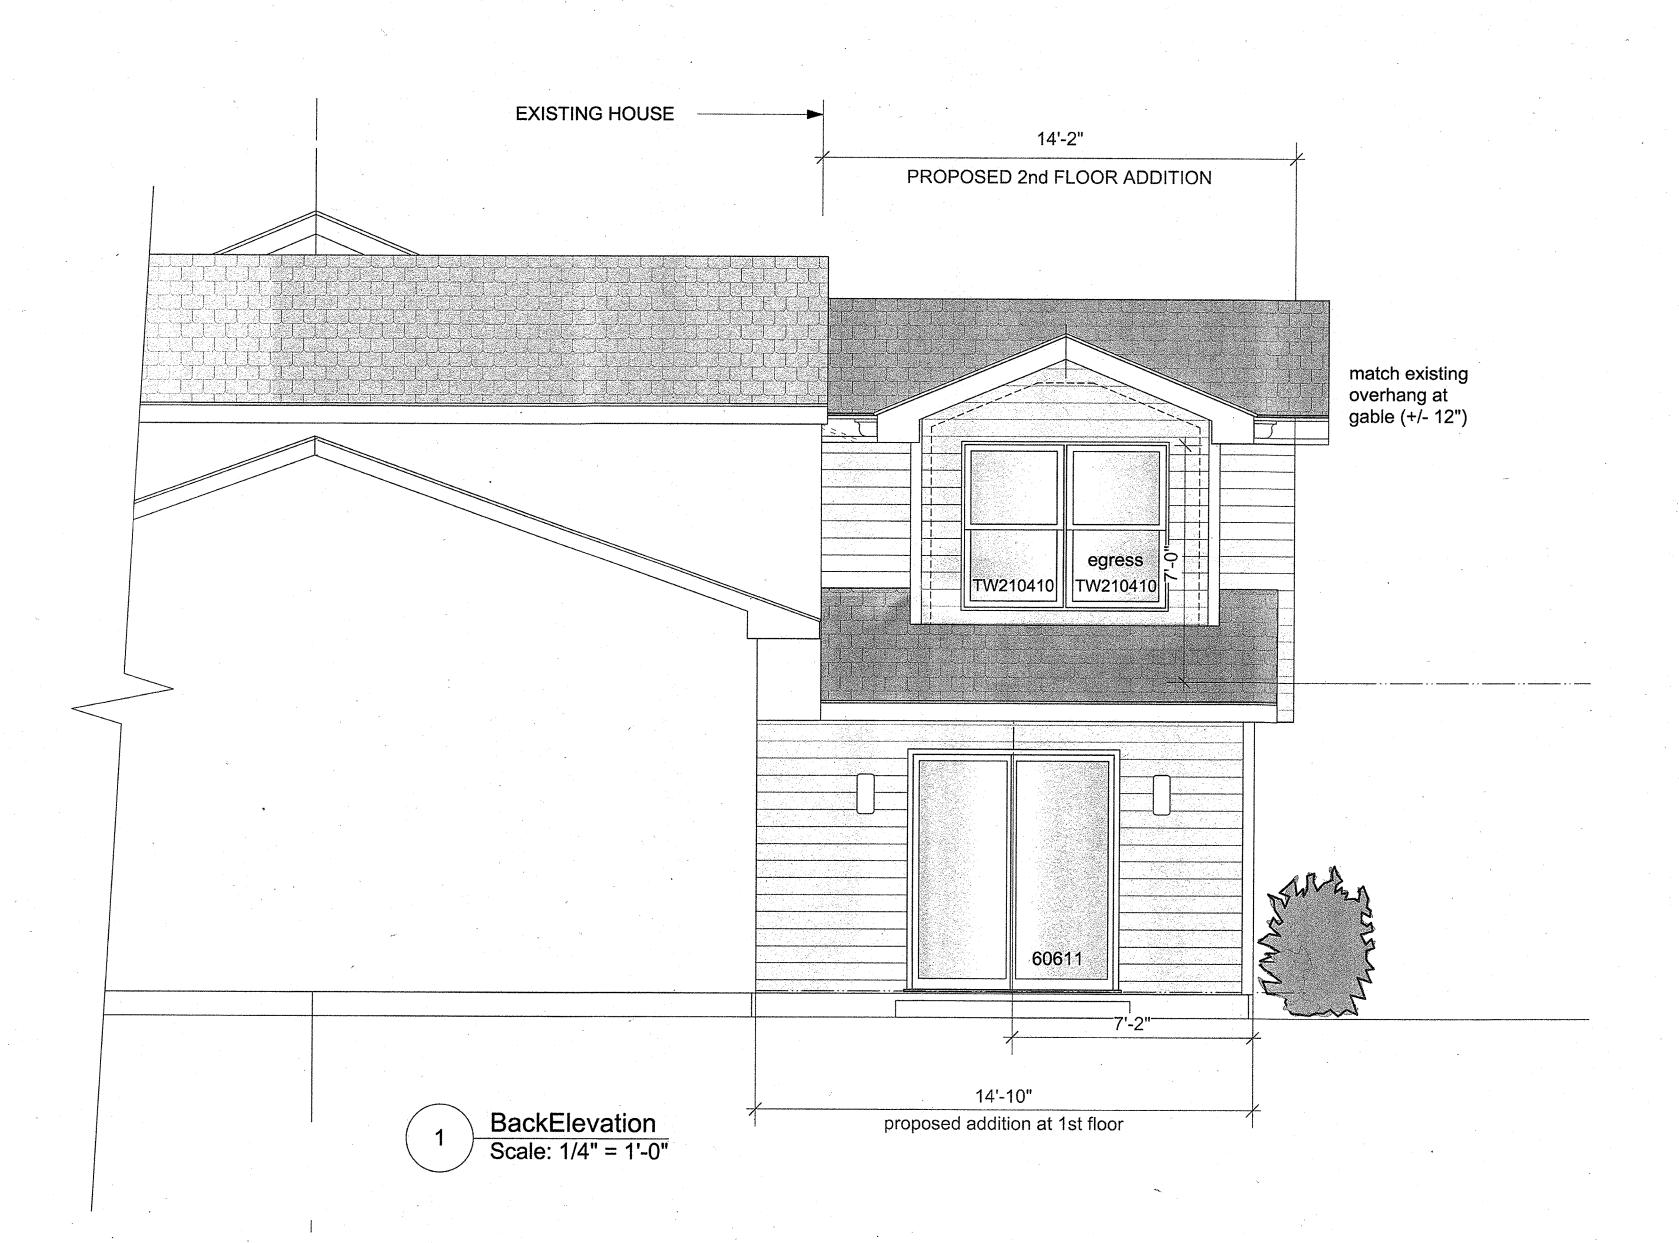
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date 11/12/2021 scale

drawing title

Back Elevation

A-4.3



## **67 Chestnut Oval** Orangeburg, NY

**County of Rockland** 

## Margaret Fowler Architect LLC

NYS license #024528-1 500 North Broadway Upper Nyack, NY 10960 t: (845) 680-9475

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date 11/12/2021

drawing title

Side Elevation

roof rafters @ 16" oc with Simpson ties to code w/closed cell foam insulation to achieve required R-38 in roof space, completely cover plate.

roofing to be timberline lifetime asphalt shingles (color to match existing house) over ZipSystem 5/8" roof sheathing - install/tape/seal as per mfr's specifications.

fascia & eaves to match existing house with gutters & leaders to provide positive drainage away from foundation

cantilever floor joists as shown (see detail), provide continuous insulation and weather-tight seal

2x4 wd studs @ 16"OC w/ R-15 high density batt insulation within bays and continuous ZipSystem R-6 sheathing (1.5") to achieve R-21. Install construction adhesive under rim joist and install/tape/seal panels as per mfr's specifications

siding to match existing house

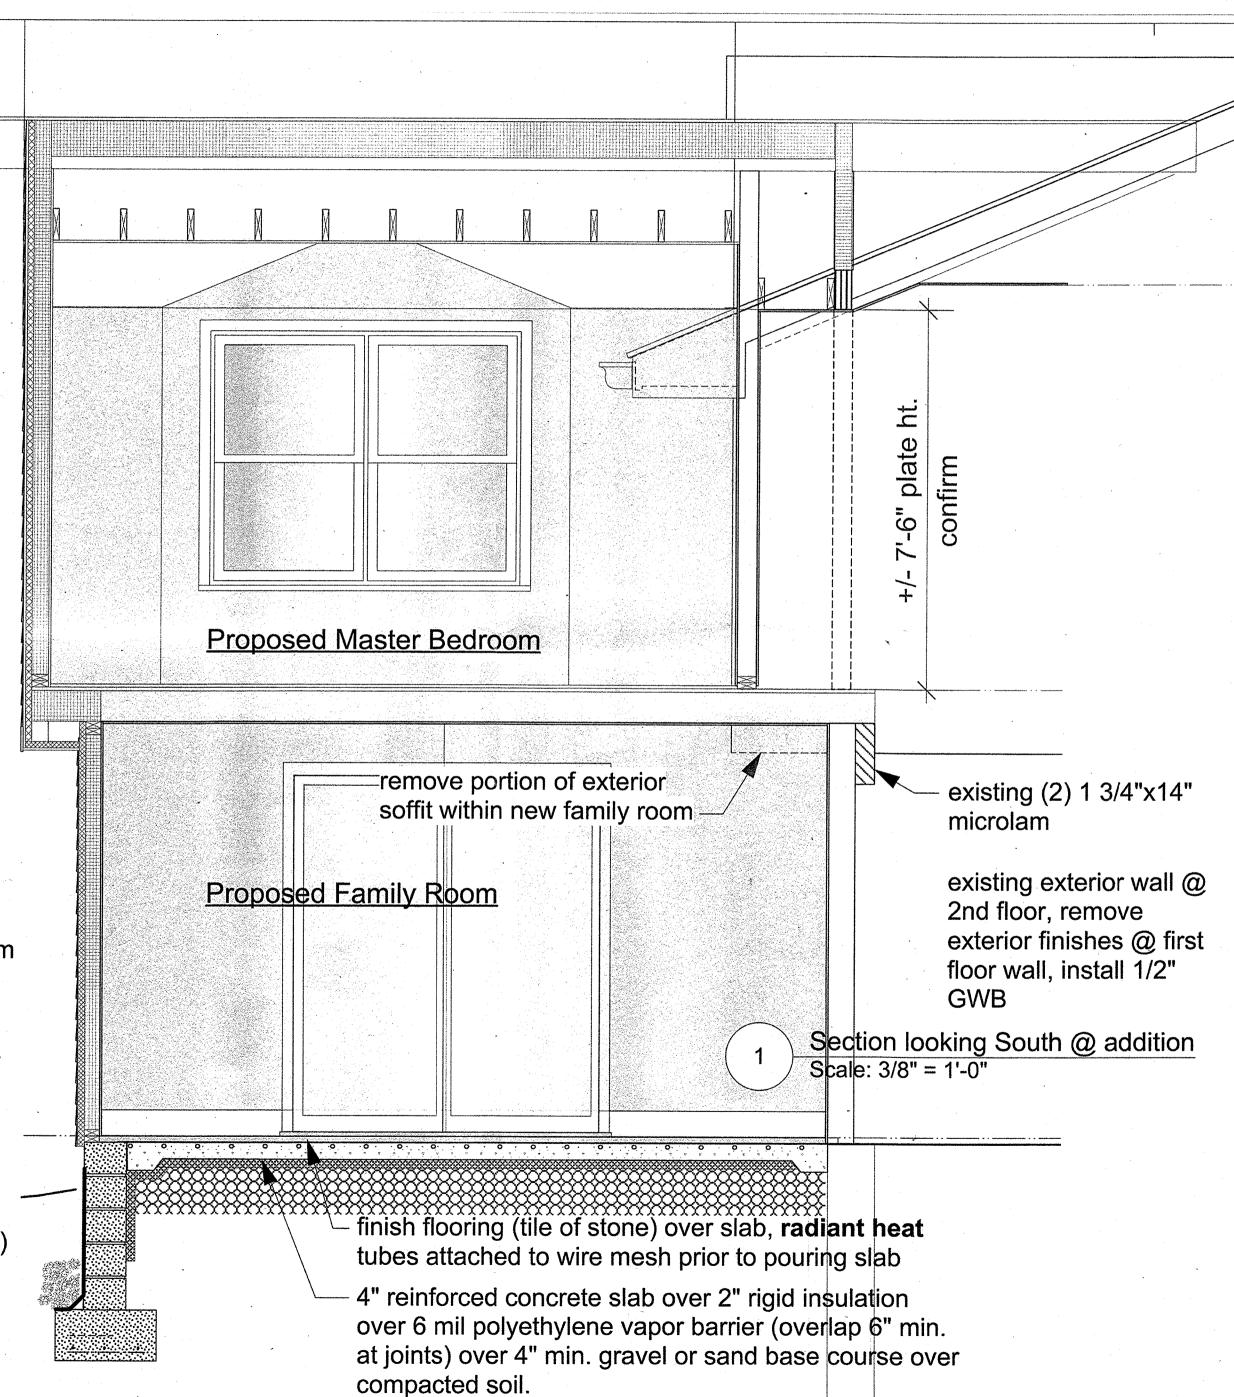
all detailing, windows and trim to match existing

waterproofing membrane at conc block walls from top of footing to level of finished grade

8" cmu w/#5s @ 32" OC foundation grout solid w/2" rigid insulation and damproofing from top of footing to underside of slab, stucco finish

no footing drain required, slope grade away from foundation

12" x 24" continuous concrete ftg. (3000 psi min.) at 3'-6" below grade min.



# Badillo Residence

# 67 Chestnut Oval Orangeburg, NY

**County of Rockland** 

architect

# Margaret Fowler Architect LLC

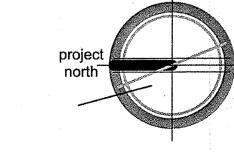
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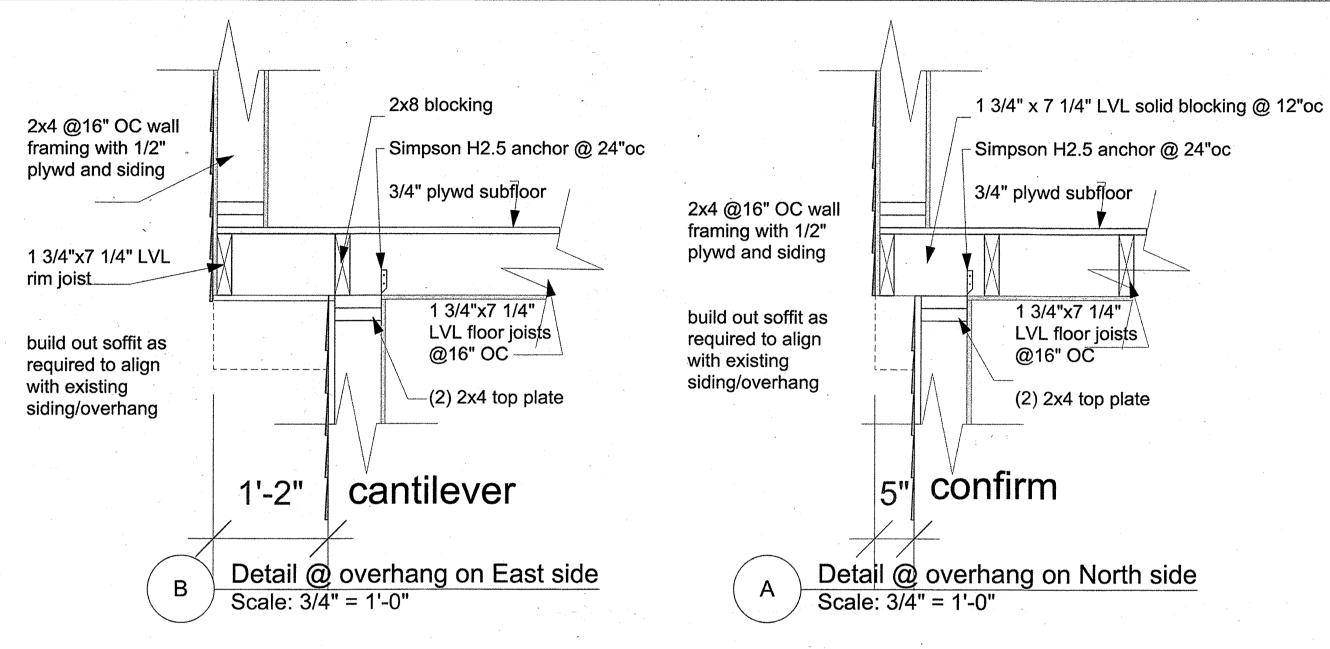
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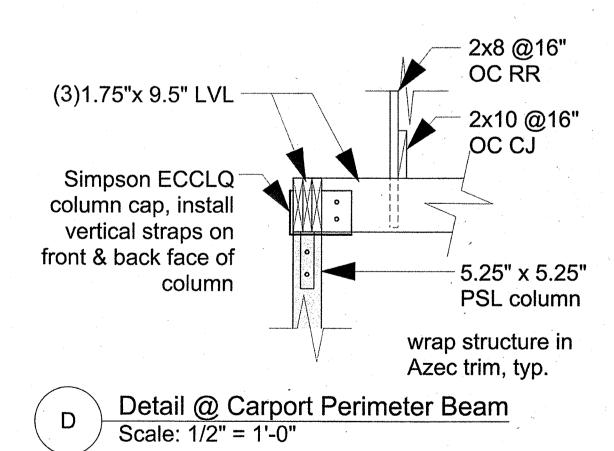



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Section

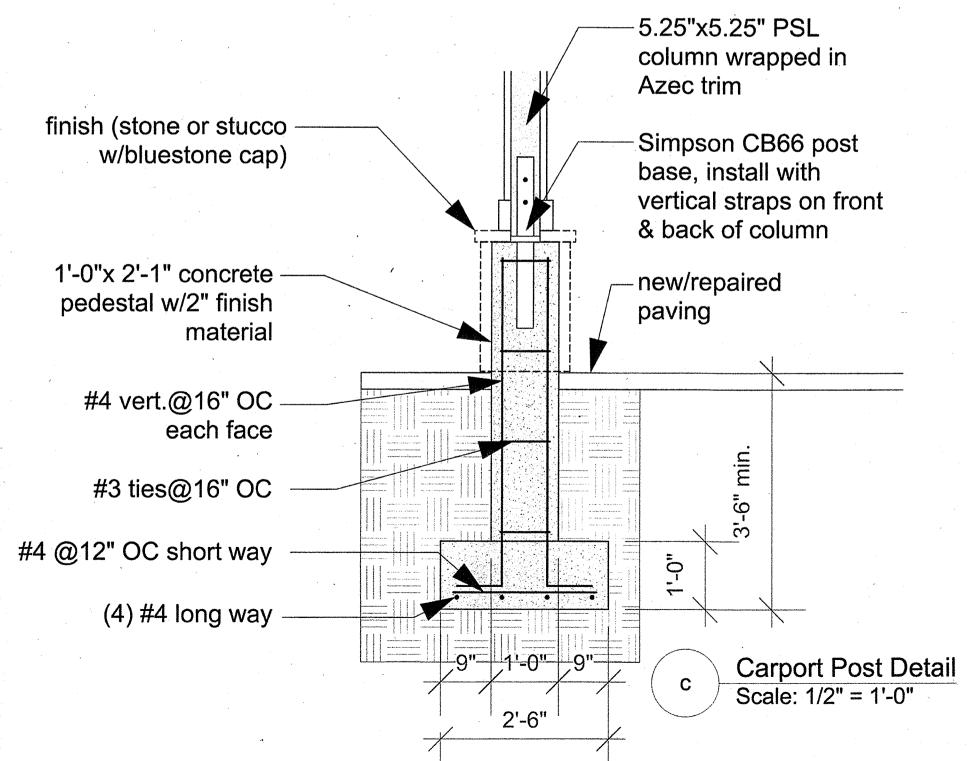A-5.1








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Framing Details

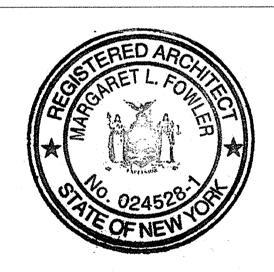A-5.2