


LEGEND	
DRAINAGE INLET W/PIPES	
DRAIN MANHOLE/ WITH PIPES	
TOP CURB @ CATCH BASIN	тссв
TOP GRATE FIELD INLET	TGFI
REINFORCED CONCRETE PIPE	RCP
CORRUGATED PLASTIC PIPE	CPP
UTILITY POLE	UP Q
UTILITY POLE WITH LIGHT	* `\
WATER VALVE	w o
HYDRANT	HYD 众
GAS VALVE	GV 🛆
IRRIGATION CONTROL VALVE	ICV O
OVERHEAD WIRES	
GAS LINE	G
GAS, ELEC, TEL, CATV	——— GETC
WATER LINE	
CONTOUR LINE	<u> </u>
SPOT GRADE	+ 520.5

PRELIMINARY

		,
	200' RADIUS EXHIBIT	TAX LOT # 68.12–3–27
	SAFE 'N' SOUND CHILD CARE	AREA 116,960 SF
DATE OF NEW PAISIONS GREENING AND THE STREET OF THE STREE		FILE 06–21908 200 FT
	ROCKLAND COUNTY, STATE OF NEW YORK	SCALE 1"= 40'
	JAY A. GREENWELL, PLS, LLC	DATE 1/05/22
LAND BOULD	SURVEYING — LAND PLANNING 85 LAFAYETTE AVENUE, SUFFERN, NEW YORK, 10901	JOB NO.
JAY A. GREENWELL, PLS NYS LIC. # 49676	PHONE 845-357-0830 FAX 845-357-0756	21908
		SHEET 6

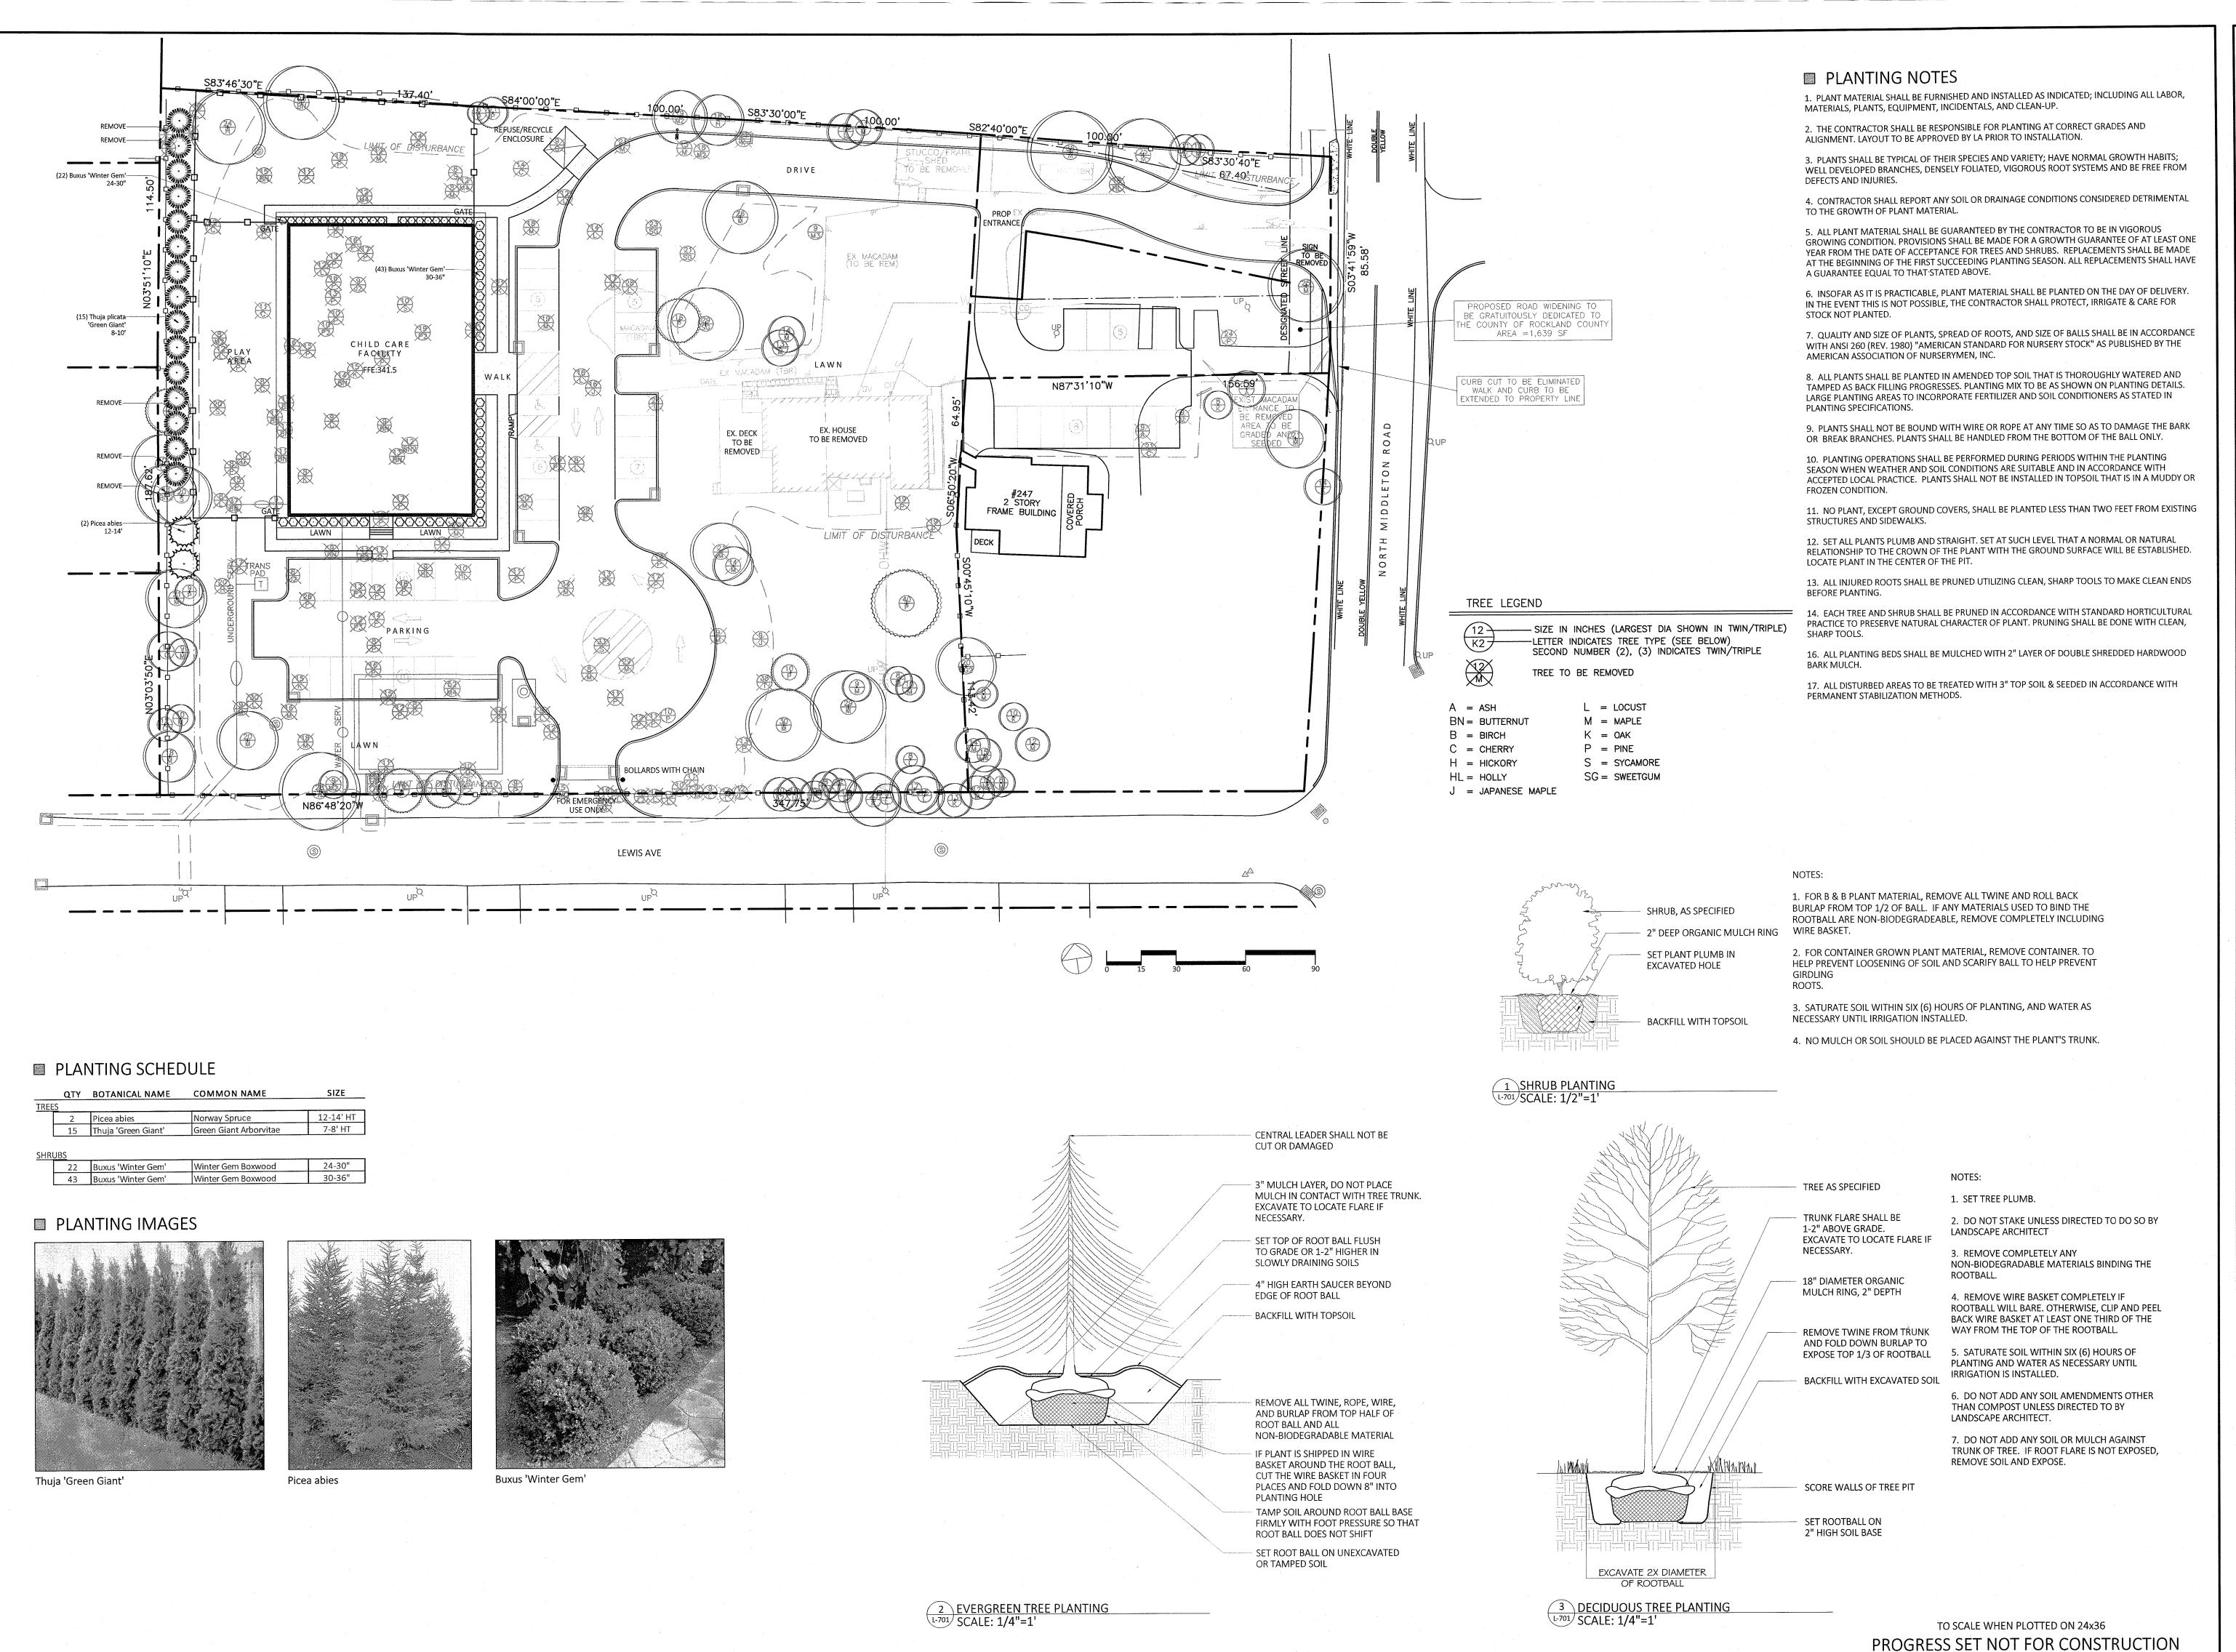

Y O S T DESIGN LANDSCAPE ARCHITECTURE

178 elizabeth st pearl river, ny 10965 p 845.365.4595 | f 914.361.4473 yostdesign.com

SURVEYOR:

EARL RIVER COUNTY, NEW YORK

DATE: AUGUST 16, 2019
DRAWN BY: BMY
JOB NO: 100117
SCALE: 1"=30'-0"
FILENAME: 2022_0124_Safe_n_Sound

REVISIONS: 4/28/2021

1/25/2022


Blythe M Yost ASLA | Registered Landscape Architect

CONCEPTUAL PLANTING PLAN


SHEET NO.

L-701

SHEET: I of

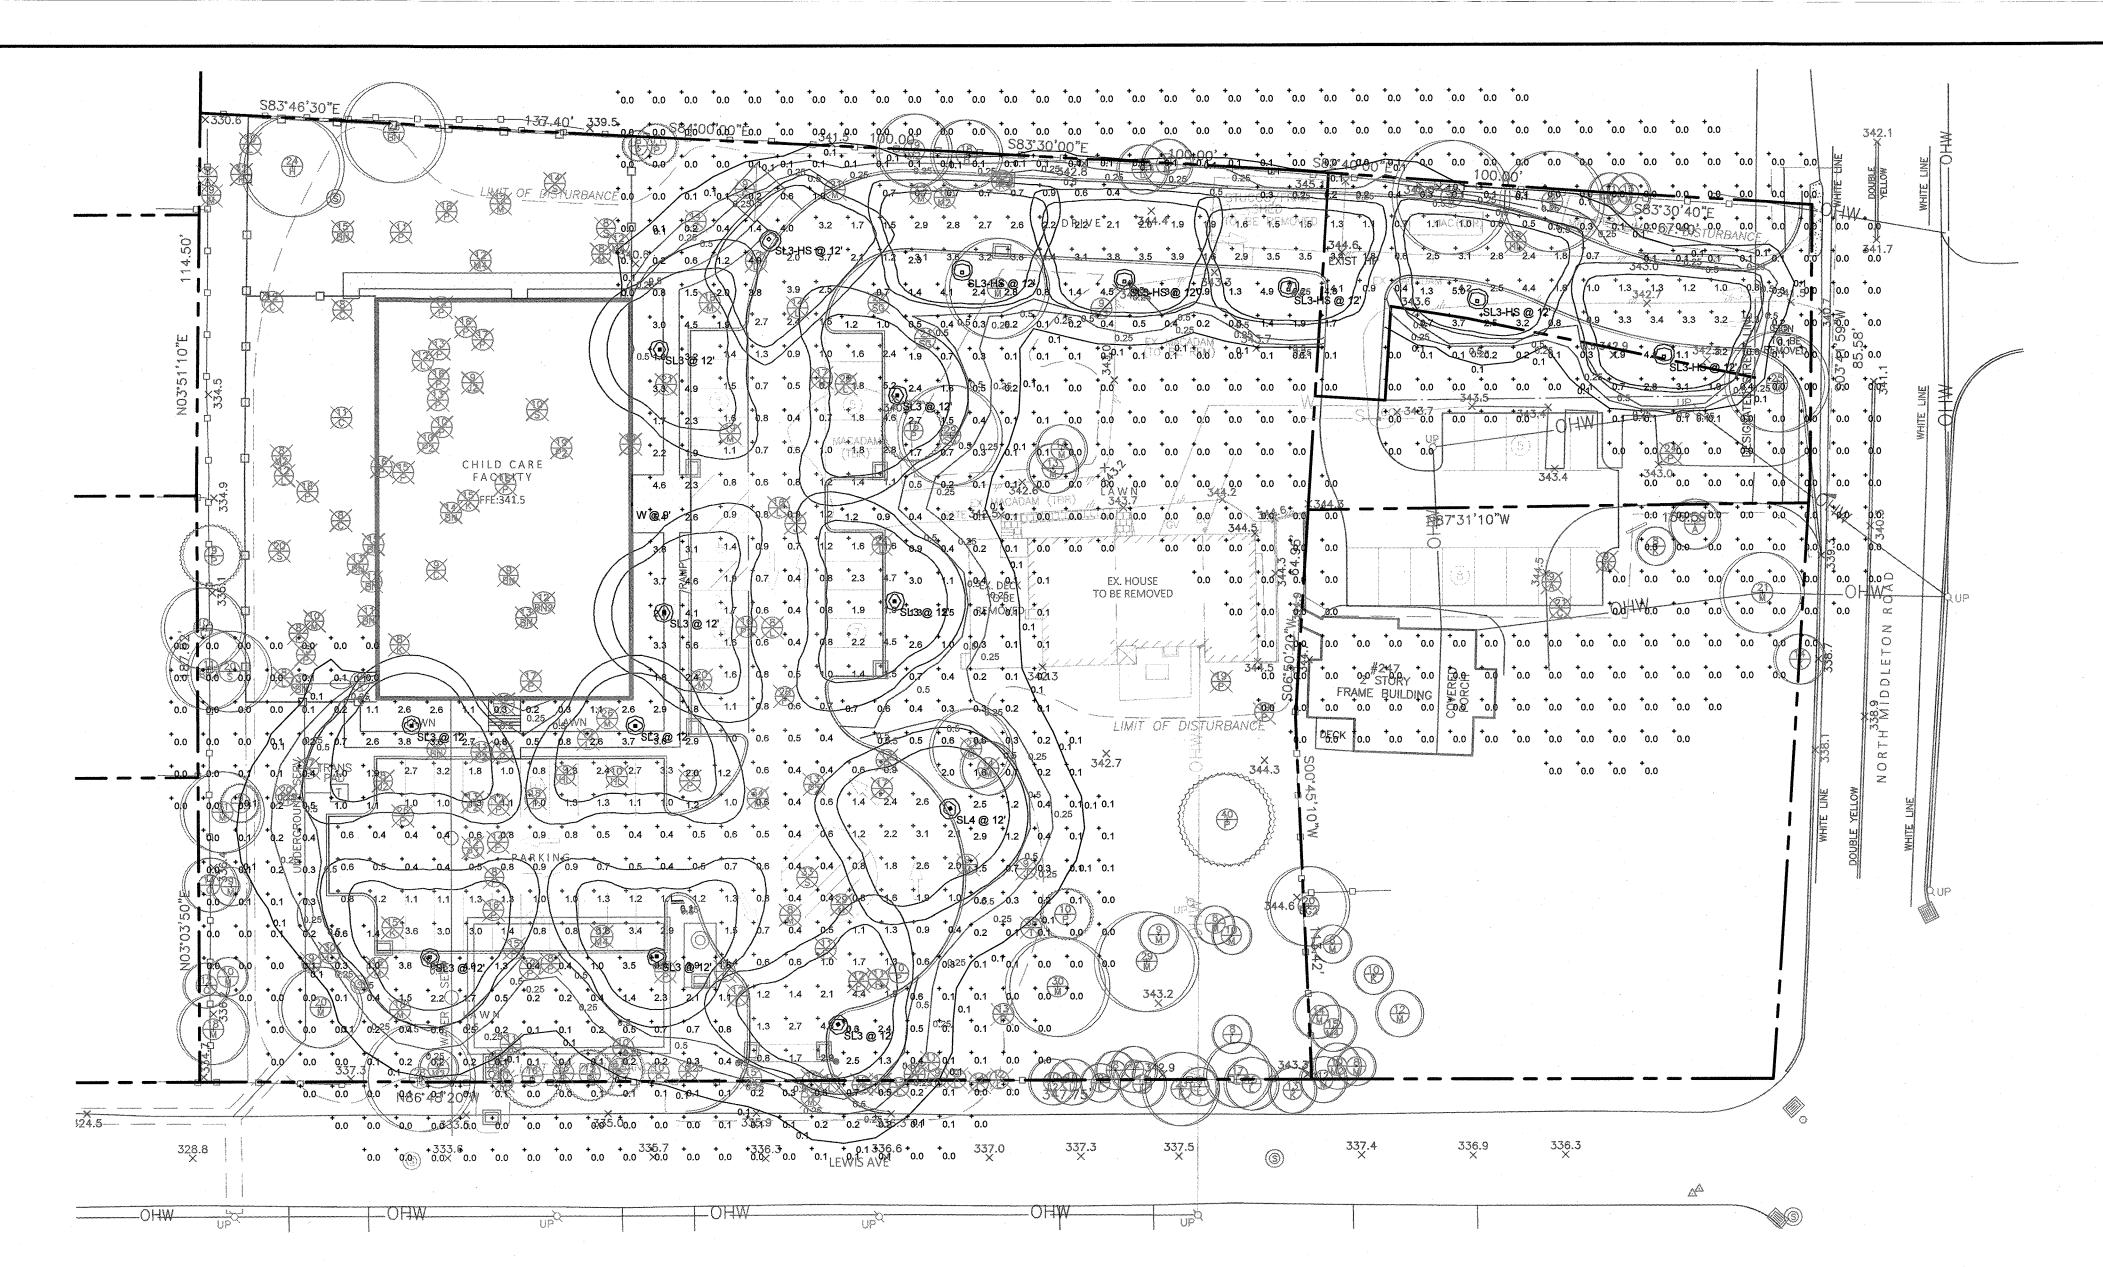

LIGHTING SCHEDULE

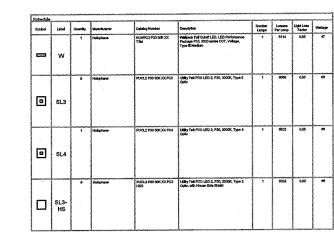

2								
Statistics	Statistics							
Description	Symbol	Avg	Max	Min	Max/Min	Avg/Min		
Parking and Drive Area	+	1.5 fc	5,2 fc	0.4 fc	13.0:1	3,8:1		
Trespass	+	0.5 fc	5.6 fc	0.0 fc	N/A	N/A		

LIGHTING NOTES

- 1. PROVIDE SWITCHING, TRANSFORMER LAYOUT AND WIRE SIZE FOR REVIEW BY LANDSCAPE ARCHITECT.
- 2. SIZE LOW VOLTAGE WIRE BASED ON A MAX. ALLOWABLE VOLTAGE DROP BY 50%
- 3. TRANSFORMERS SIZED TO MAXIMUM CAPACITY OF LIGHT FIXTURE.
- 4. DESIGN LOAD IS NOT TO EXCEED 80% OF TRANSFORMER CAPACITY.
- 5. THE WORK IS TO COMPLY WITH ALL APPLICABLE CODES AND STANDARDS AND MEET ALL TESTING REQUIREMENTS.
- 6. FIXTURE LOCATIONS AND WIRE LAYOUTS ARE DIAGRAMMATIC AND APPROXIMATE: BEFORE INSTALLATION, REVIEW ADJACENT CONTROLLERS IN AN ORDERLY FASHION TO ALLOW ACCESS AS NECESSARY.
- 7. REFER TO THE PLAN FOR LIGHT FIXTURE LOCATION. UTILIZE CONDUIT (E) TIRE TO THE (E) SWITCHING WHERE POSSIBLE.
- 8. BALANCE LOADS TO THE TRANSFORMERS, IDENTIFY CENTER OF LOAD, CONNECT WIRE FROM TRANSFORMER TO CENTER OF LOAD.
- 9. PROVIDE 120 VOLT POWER TO EACH REMOTE TRANSFORMER CONNECT TO SWITCH IN HOUSE PER DIRECTION AND ACCEPTANCE OF CLIENT.
- 10. INSTALL FIXTURES PER MANUFACTURER'S INSTRUCTIONS.

Y O S T DESIGN LANDSCAPE ARCHITECTURE

178 elizabeth st pearl river, ny 10965 p 845.365.4595 | f 914.361.4473 yostdesign.com

SURVEYOR:

SAFE IN SOUND
PEARL RIVER
ROCKLAND COUNTY, NEW YORK

DATE: AUGUST 16, 2019
DRAWN BY: BMY
JOB NO: 100117
SCALE: 1"=30'-0"
FILENAME: 2022_0126_Safe_n_Sound

REVISIONS: 4/28/2021 1/25/2021

Blythe M Yost ASLA | Registered Landscape Architect

LIGHTING PLAN

SHEET NO.

L-601

TO SCALE WHEN PLOTTED ON 24x36

PROGRESS SET NOT FOR CONSTRUCTION