

EXISTING	LEGEND "B" INLET	PROPOSED
	"A" INLET	
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3	SANITARY MANHOLE	
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SOIL EROSION LEGEND

PROPOSED FILTER FABRIC SILT FENCE	
PROPOSED LIMIT OF DISTURBANCE	100
PROPOSED STABILIZED CONSTRUCTION ENTRANCE	
PROPOSED FILTER FABRIC DROP INLET PROTECTION	The second secon

TEMPORARY SEEDING SPECIFICATIONS

AREAS REMAINING DISTURBED FOR 14 DAYS OR MORE SHALL BE STABILIZED AS FOLLOWS:

SCARIFY SOILS IF COMPACTED, LIME TO PH OF 6.0 IF REQUIRED, FERTILIZE WITH

600 LBS/ACRE 5-10-10 FERTILIZER IF REQ., SEED WITH SPECIES AND RATE SHOWN BELOW,

MULCH WITH HAY OR STRAW AT A RATE OF 2 TONS/ACRE, ANCHOR MULCH WITH

NETTING OF WOOD FIBER OR JUTE IF STEEP SLOPE OR HIGH POTENTIAL FOR EROSION.

SPECIES

APPLICATION RATE

RYEGRASS (ANNUAL OR PERENNIAL)
(USE WINTER RYE IF SEEDING IN OCT./NOV.)

APPLICATION RATE

(0.7 LBS/1000 SF)

SITE PREPARATION

A. INSTALL NEEDED WATER AND EROSION CONTROL MEASURES AND BRING AREA TO BE SEEDED TO DESIRED GRADES USING A MINIMUM OF 4" OF TOPSOIL.

- B. PREPARE SEED BED BY LOOSENING SOIL TO A DEPTH OF 4-6 INCHES
 C. LIME TO A PH OF 6.5
- D. FERTILIZE PER SOIL TESTS, OR, IF FERTILIZER IS TO BE APPLIED BEFORE SOIL TESTS, APPLY 850 POUNDS

 OF 5-10-10 OR EQUIVALENT PER ACRE (20 LBS. / 1000 SQ. FT.)
- E. INCORPORATE LIME AND FERTILIZER IN TOP 2-4 INCHES OF SOIL.
 F. SMOOTH. REMOVE ALL STONES OVER I" IN DIAMETER, STICKS AND FOREIGN MATTER. FIRM SEED BED.
 G. APPLY SEED PER PERMANENT SEEDING SCHEDULE.

PERMANENT SEEDING MIXTURES

MODERATE TO STEEP SLOPES AND LOW MAINTENANCE AREAS

SPECIES

EMPIRE BIRDSFOOT TREFOIL

TALL FESCUE

RYEGRASS

MAPPLICATION RATE

8 LBS/ACRE

20 LBS/ACRE

5 LBS/ACRE

SPECIES

SUNNY SITES (WELL, MODERATELY WELL AND SOMEWHAT POORLY DRAINED SOILS)

65% KENTUCKY BLUEGRASS BLEND

85-II4 LBS/ACRE
20% PERENNIAL RYEGRASS

26-35 LBS/ACRE

15% FINE FESCUE

19-26 LBS/ACRE

SUNNY DROUGHTY SITES (SOMEWHAT TO EXCESSIVELY DRAINED SOILS)
65% FINE FESCUE

114-143 LBS/ACRE

15% PERENNIAL RYEGRASS26-33 LBS/ACRE20% KENTUCKY BLUEGRASS BLEND35-44 LBS/ACRE

SHADY DRY SITES (WELL TO SOMEWHAT POORLY DRAINED SOILS) 80% SHADE TOLERANT KENTUCKY

BLUEGRASS BLEND 105-138 LBS/ACRE
20% PERENNIAL RYEGRASS 25-37 LBS/ACRE

SHADY WET SITES (SOMEWHAT POOR TO POORLY DRAINED SOILS)

70% ROUGH BLUEGRASS 60-91 LBS/ACRE
80% SHADE TOLERANT KENTUCKY 25-39 LBS/ACRE
BLUEGRASS BLEND

SLOPE STABILIZATION, SEEDING METHOD & MULCHING


SLOPES OF 4:1 OR GREATER (HORIZONTAL:VERTICAL)

SLOPES SHALL BE HYDROSEEDED WITH THE MIXTURES AND RATES INDICATED IN THE PERMANENT SEEDING MIXTURE SCHEDULE. STRAW OR HAY MULCH SHALL BE APPLIED AT A RATE OF 2 TONS/ACRE. STRAW OR HAY MULCH SHALL BE ANCHORED WITH GEO-JUTE EROSION CONTROL NETTING AS MANUFACTURED BY MIRAFI OR APPROVED EQUIVALENT. NETTING TO BE INSTALLED PER MANUFACTURER SPECIFICATIONS.

GENTLE SLOPES AND FLAT AREAS

AREAS SHALL BE SEEDED BY HYDROSEEDING OR BROADCASTING WITH THE MIXTURES AND RATES INDICATED ON THE PERMANENT SEEDING MIXTURE SCHEDULE. HYDROSEEDED AREAS SHALL BE MULCHED WITH A WOOD FIBER MULCH APPLIED AT A RATE OF 500 LBS/ACRE. BROADCAST AREAS SHALL MULCHED WITH HAY OR STRAW AT A RATE OF 2 TONS/ACRE. AREAS SEEDED BY BROADCASTING SHALL BE LIGHTLY RAKED AND PACKED PRIOR TO PLACING MULCH.

GRAPHIC SCALE

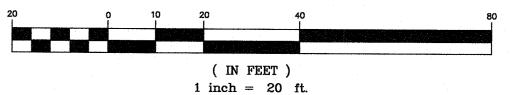

2/1/22	4	FOR TOWN PLANNING BOARD SUBMISSION	PEF
11/23/21	3	ADDITION OF A/C UNITS	PEF
11/5/21	2	PER TOWN ENGINEER	PEF
5/7/21	1	PER TOWN PLANNING BOARD ENGINEER	PEF
DATE	NO.	REVISION	CHK'D

ROSION & SEDIMENT CONTROL PLAN

PREPARED FOR

VICTAEL J. VAURO

TOWN OF ORANGETOWN
ROCKLAND COUNTY - NEW YORK




Engineering and Land Surveying, P.C.

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30 Madison Avenue, Paramus, NJ 07652


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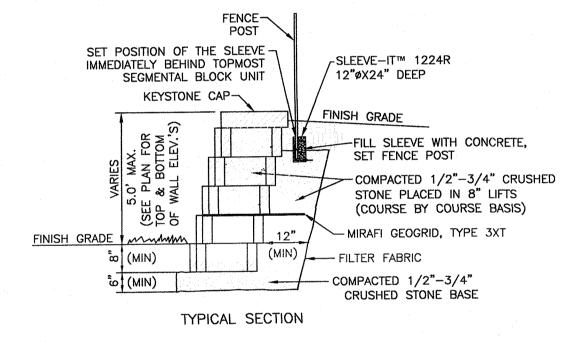
Craig D. Dominick, P.E.
N.Y. Lie. No. 095947

DATE: DECEMBER 18, 2020 DRAWN BY: CDD SCALE: 1" = 20' JOB No.: 12011

JOB No.: 12011 SHEET:

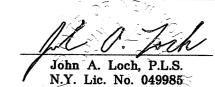


FILTER FABRIC SILT FENCE WITH STRAW BALES SECTION

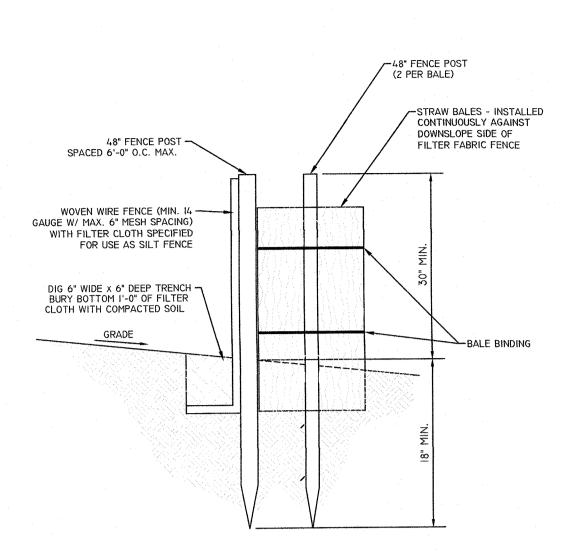


KEYSTONE WALLS DETAIL N.T.S.

1. MINIMUM WALL EMBEDMENT IS 8".


- 2. KEYSTONE BLOCKS TO BE INSTALLED PER MANUFACTURER'S SPECIFICATIONS. 3. EXACT FINISHED GRADES AT RETAINING WALL TO BE ADJUSTED TO MEET
- FIELD CONDITIONS. 4. 1" MIN. SETBACK PER UNIT.

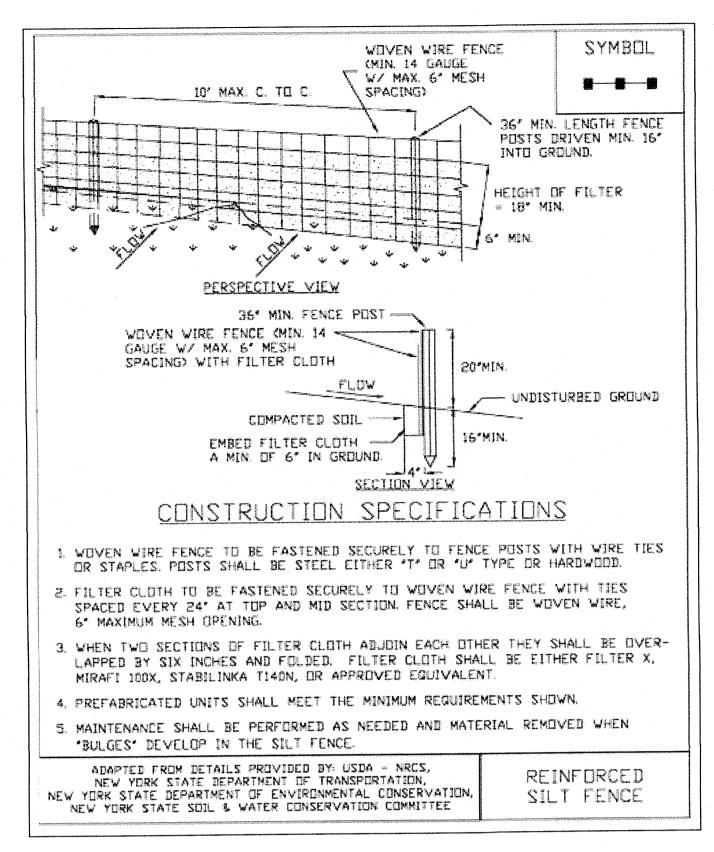

REINFORCED SILT FENCE DETAIL

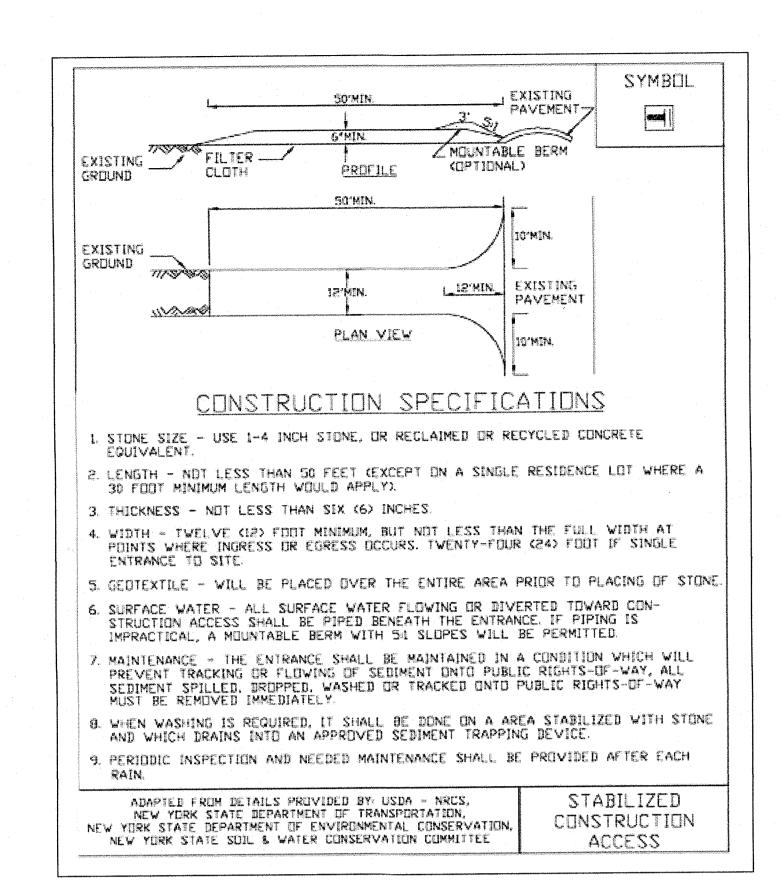


STABILIZED CONSTRUCTION ACCESS DETAIL

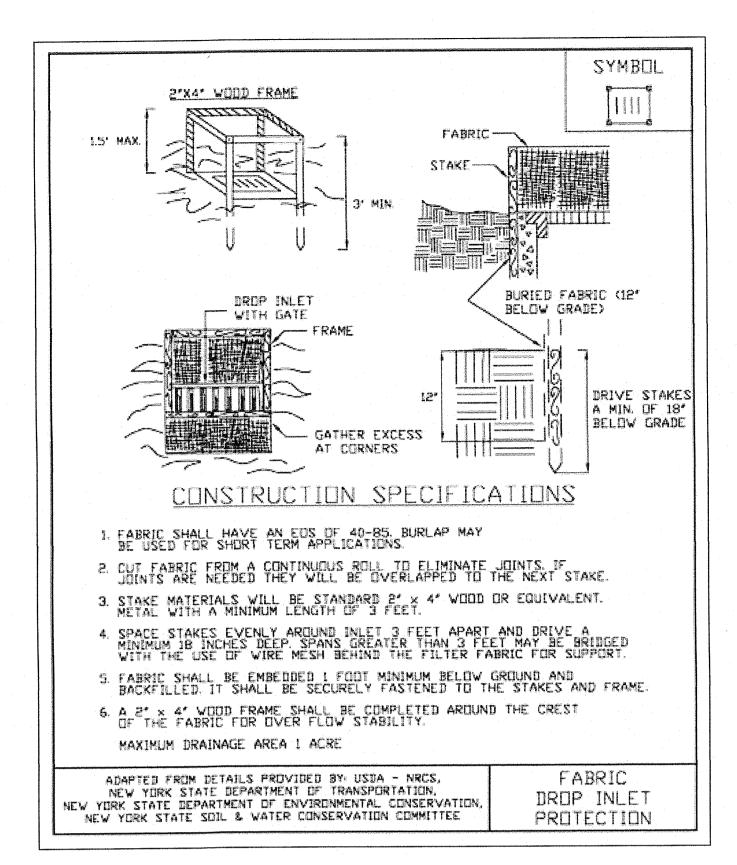



FILTER FABRIC DROP INLET PROTECTION DETAIL


SILT FENCE & FILTER

FABRIC (TYP.)

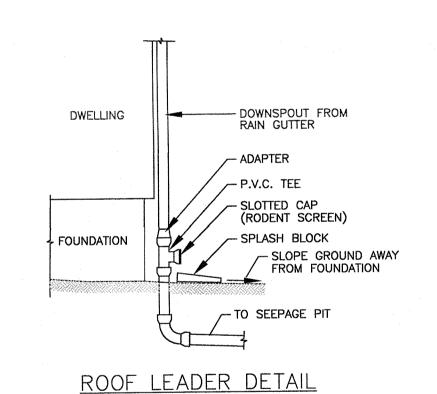

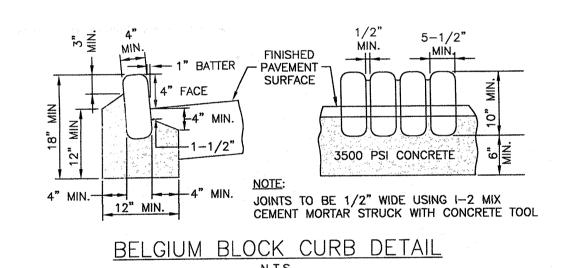

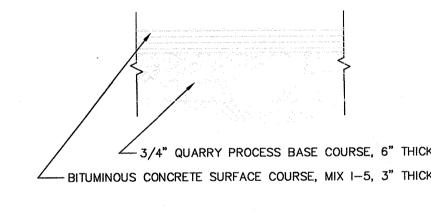

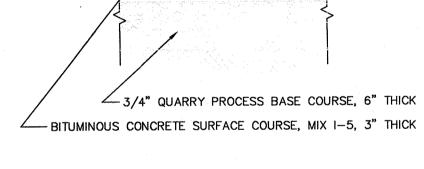

ASPHALT PAVEMENT DRIVEWAY DETAIL

N.T.S.

1. REFER TO NEW YORK STATE STANDARDS AND SPECIFICATIONS FOR EROSION AND SEDIMENT CONTROL. 2. SILT FENCE PROTECTION INSTALLED AROUND STOCKPILE AS PER "REINFORCED SILT FENCE DETAIL".


EXISTING GROUND


TOPSOIL STOCKPILE

5-0" HIGH MAX.


TO BE SEEDED &

TOPSOIL STOCKPILE DETAIL

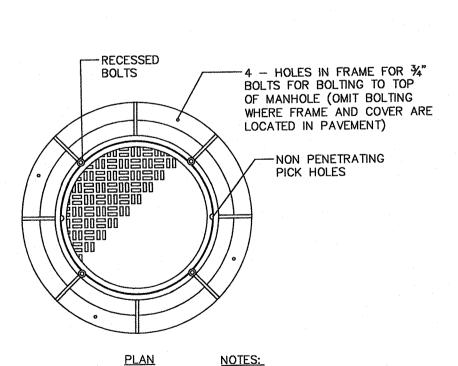


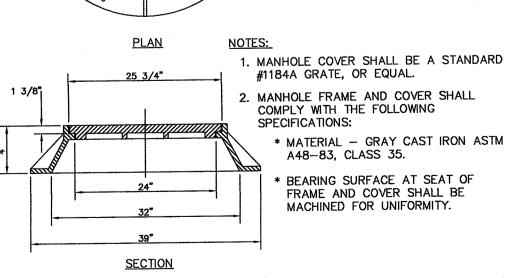

DETAIL OF STANDARD MANHOLE FRAME AND GRATE MODEL 1184A N.T.S.

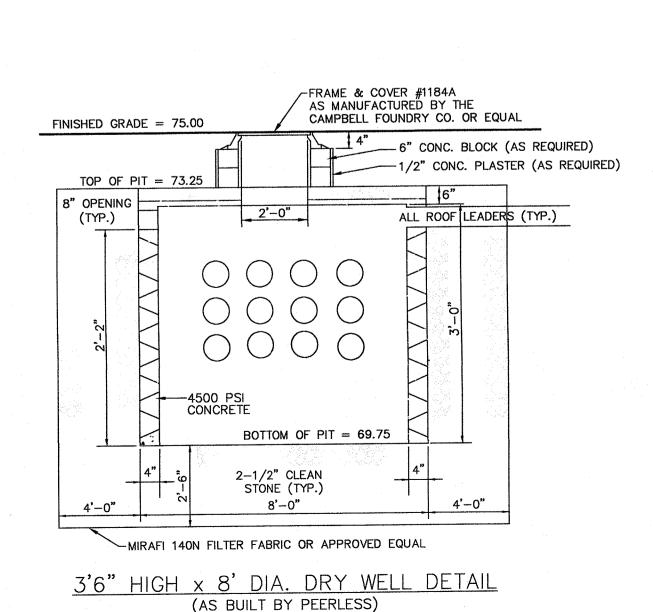

N.T.S.

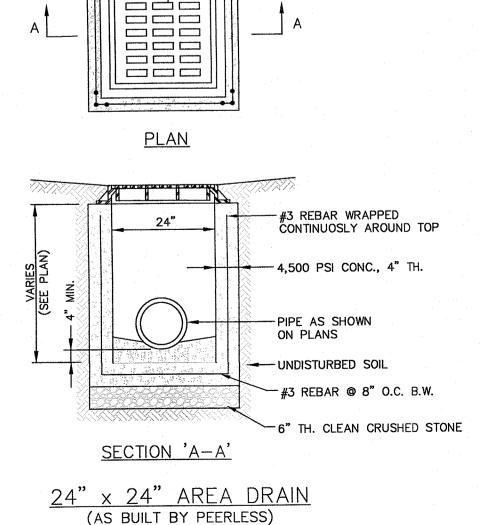

N.T.S.


FRAME & GRATE PATTERN #2815 CAMPBELL FOUNDRY COMPANY


#3 REBAR PLACED

VERTICALLY IN


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OR APPROVED EQUAL




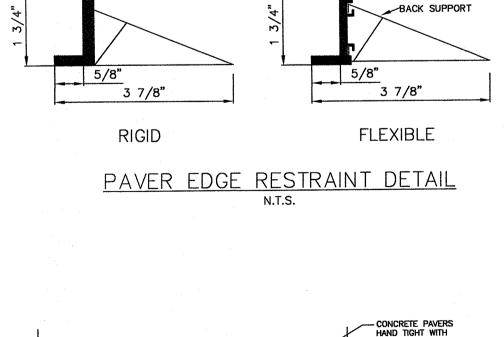

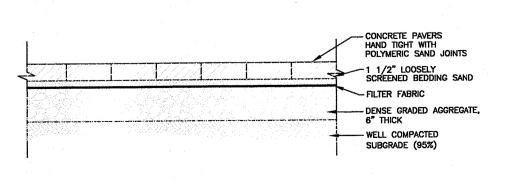PAVER BLOCK DRIVEWAY & WALK DETAIL

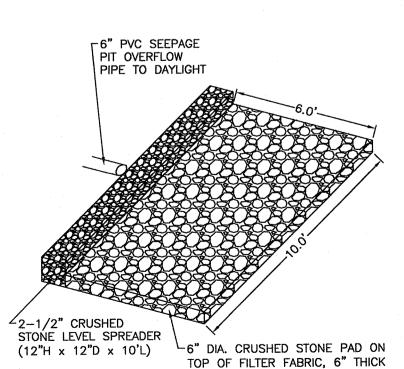


LEVEL SPREADER DETAIL

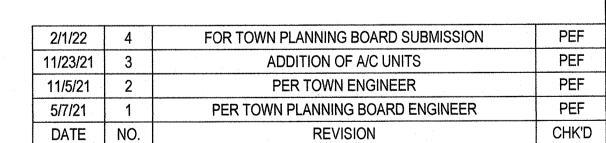



TOWN OF ORANGETOWN ROCKLAND COUNTY - NEW YORK

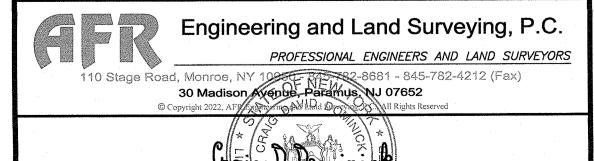


	N.Y. Lico No. 195947	
DATE: DECEMBER 18, 2020	DRAWN BY COD	CHECKED BY: P
SCALE: NOT TO SCALE	JOB No.: 12011	SHEET: 3 OF
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(11) Thuja 'Green Giant' 7-8' HT (11) Thuja 'Green Giant' (17) Buxus 'Winter Gem' (1) Cercis canadensis 'Forest Pansy' 2-2.5" Caliper (17) Deutzia gracilis (10) Picea abies (400) Pachysandra terminalis Bare Root 12" o.c.

PLANTING IMAGES





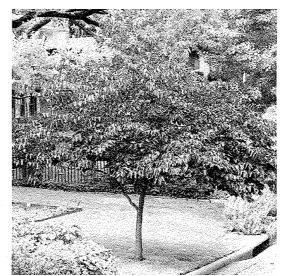

Thuja 'Green Giant'

Cercis canadensis 'Forest Pansy'

0 10 20 40







PLANTING SCHEDULE

QTY	BOTANICAL NAME	COMMON NAME	SIZE COMMENTS
REES			
1	Cercis canadensis 'Forest Pansy'	Forest Pansy Redbud	2-2.5" Cal
10	Picea abies	Norway Spruce	7-8' HT
22	Thuja plicata 'Green Giant'	Green Giant Arborvitae	7-8' HT
HRUBS			
HRUBS			
HRUBS 17	Buxus 'Winter Gem'	Winter Gem Boxwood	24-30"
- Proposition of the Party of t	Buxus 'Winter Gem' Deutzia gracilis	Winter Gem Boxwood Slender Deutzia	24-30" 3 Gallon
17	Deutzia gracilis		
17	Deutzia gracilis		

PLANTING NOTES

1. PLANT MATERIAL SHALL BE FURNISHED AND INSTALLED AS INDICATED; INCLUDING ALL LABOR, MATERIALS, PLANTS, EQUIPMENT, INCIDENTALS, AND CLEAN-UP.

2. THE CONTRACTOR SHALL BE RESPONSIBLE FOR PLANTING AT CORRECT GRADES AND ALIGNMENT. LAYOUT TO BE APPROVED BY LA PRIOR TO INSTALLATION.

3. PLANTS SHALL BE TYPICAL OF THEIR SPECIES AND VARIETY; HAVE NORMAL GROWTH HABITS; WELL DEVELOPED BRANCHES, DENSELY FOLIATED, VIGOROUS ROOT SYSTEMS AND BE FREE FROM DEFECTS AND INJURIES.

4. CONTRACTOR SHALL REPORT ANY SOIL OR DRAINAGE CONDITIONS CONSIDERED DETRIMENTAL TO THE GROWTH OF PLANT

5. ALL PLANT MATERIAL SHALL BE GUARANTEED BY THE CONTRACTOR TO BE IN VIGOROUS GROWING CONDITION, PROVISIONS SHALL BE MADE FOR A GROWTH GUARANTEE OF AT LEAST ONE YEAR FROM THE DATE OF ACCEPTANCE FOR TREES AND SHRUBS. REPLACEMENTS SHALL BE MADE AT THE BEGINNING OF THE FIRST SUCCEEDING PLANTING SEASON. ALL REPLACEMENTS SHALL HAVE A GUARANTEE EQUAL TO THAT STATED ABOVE.

6. INSOFAR AS IT IS PRACTICABLE, PLANT MATERIAL SHALL BE PLANTED ON THE DAY OF DELIVERY. IN THE EVENT THIS IS NOT POSSIBLE, THE CONTRACTOR SHALL PROTECT, IRRIGATE & CARE FOR STOCK NOT PLANTED.

7. QUALITY AND SIZE OF PLANTS, SPREAD OF ROOTS, AND SIZE OF BALLS SHALL BE IN ACCORDANCE WITH ANSI 260 (REV. 1980) "AMERICAN STANDARD FOR NURSERY STOCK" AS PUBLISHED BY THE AMERICAN ASSOCIATION OF NURSERYMEN, INC.

8. ALL PLANTS SHALL BE PLANTED IN AMENDED TOP SOIL THAT IS THOROUGHLY WATERED AND TAMPED AS BACK FILLING PROGRESSES. PLANTING MIX TO BE AS SHOWN ON PLANTING DETAILS. LARGE PLANTING AREAS TO INCORPORATE FERTILIZER AND SOIL CONDITIONERS AS STATED IN PLANTING SPECIFICATIONS.

9. PLANTS SHALL NOT BE BOUND WITH WIRE OR ROPE AT ANY TIME SO AS TO DAMAGE THE BARK OR BREAK BRANCHES. PLANTS SHALL BE HANDLED FROM THE BOTTOM OF THE BALL ONLY.

10. PLANTING OPERATIONS SHALL BE PERFORMED DURING PERIODS WITHIN THE PLANTING SEASON WHEN WEATHER AND SOIL CONDITIONS ARE SUITABLE AND IN ACCORDANCE WITH ACCEPTED LOCAL PRACTICE. PLANTS SHALL NOT BE INSTALLED IN TOPSOIL THAT IS IN A MUDDY OR FROZEN CONDITION.

11. NO PLANT, EXCEPT GROUND COVERS, SHALL BE PLANTED LESS THAN TWO FEET FROM EXISTING STRUCTURES AND

12. SET ALL PLANTS PLUMB AND STRAIGHT. SET AT SUCH LEVEL THAT A NORMAL OR NATURAL RELATIONSHIP TO THE CROWN OF THE PLANT WITH THE GROUND SURFACE WILL BE ESTABLISHED. LOCATE PLANT IN THE CENTER OF THE PIT.

13. ALL INJURED ROOTS SHALL BE PRUNED UTILIZING CLEAN, SHARP TOOLS TO MAKE CLEAN ENDS BEFORE PLANTING. 14. EACH TREE AND SHRUB SHALL BE PRUNED IN ACCORDANCE WITH STANDARD HORTICULTURAL PRACTICE TO PRESERVE

NATURAL CHARACTER OF PLANT. PRUNING SHALL BE DONE WITH CLEAN, SHARP TOOLS.

16. ALL PLANTING BEDS SHALL BE MULCHED WITH 2" LAYER OF DOUBLE SHREDDED HARDWOOD BARK MULCH. 17. ALL DISTURBED AREAS TO BE TREATED WITH 3" TOP SOIL & SEEDED IN ACCORDANCE WITH PERMANENT STABILIZATION

178 elizabeth st pearl river, ny 10965 p 845.365.4595 | f 914.361.4473 yostdesign.com

NACK, NY 10960

DATE: NOVEMBER 12, 2021 DRAWN BY: AVM JOB NO: 090721 SCALE: 1"-20' FILENAME: 12011-Site

REVISIONS:

Blythe M Yost ASLA | Registered Landscape Architect

SHEET NO.

SHEET: 1 of 2

2/1/22	4	FOR TOWN PLANNING BOARD SUBMISSION	PEF
11/23/21	. 3	ADDITION OF A/C UNITS	PEF
11/5/21	2	PER TOWN ENGINEER	PEF
5/7/21	1	PER TOWN PLANNING BOARD ENGINEER	PEF
DATE	NO.	REVISION	CHK'D




TOWN OF ORANGETOWN ROCKLAND COUNTY - NEW YORK



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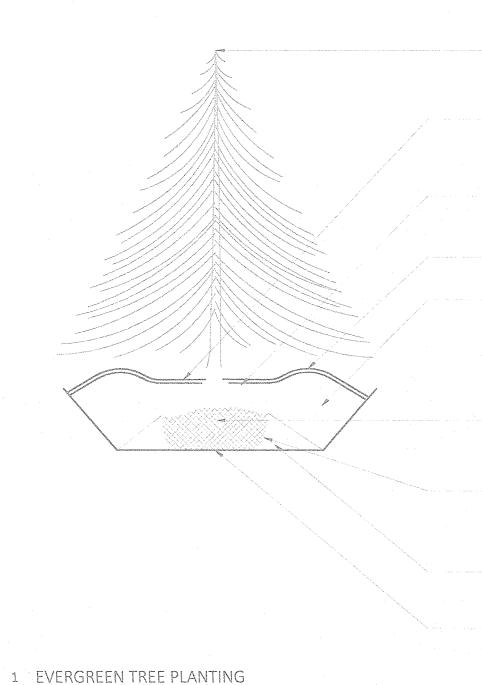
PROFESSIONAL ENGINEERS AND LAND SURVEYORS 110 Stage Road, Monroe, NY 10950 - 845-782-8681 - 845-782-4212 (Fax) 30 Madison Avenue, Paramus, NJ 07652) F NEW



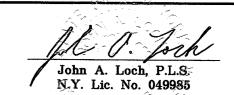

DATE: DECEMBER 18, 2020 DRAWN BY: CDD SCALE: 1" = 20' JOB No.: 12011

ESCHECKED BY: PEF SHEET: 4 OF 5



CENTRAL LEADER SHALL NOT BE CUT OR DAMAGED

3" MULCH LAYER, DO NOT PLACE MULCH IN CONTACT WITH TREE TRUNK. EXCAVATE TO LOCATE FLARE IF NECESSARY.

SET TOP OF ROOT BALL FLUSH TO GRADE OR 1-2" HIGHER IN SLOWLY DRAINING SOILS

- 4" HIGH EARTH SAUCER BEYOND EDGE OF ROOT BALL


BACKFILL WITH TOPSOIL

- REMOVE ALL TWINE, ROPE, WIRE, AND BURLAP FROM TOP HALF OF ROOT BALL AND ALL NON-BIODEGRADABLE MATERIAL

IF PLANT IS SHIPPED IN WIRE BASKET AROUND THE ROOT BALL, CUT THE WIRE BASKET IN FOUR PLACES AND FOLD DOWN 8" INTO PLANTING HOLE

TAMP SOIL AROUND ROOT BALL BASE FIRMLY WITH FOOT PRESSURE SO THAT ROOT BALL DOES NOT SHIFT SET ROOT BALL ON UNEXCAVATED OR TAMPED SOIL

> 2 DECIDUOUS TREE PLANTING L-801 SCALE: 1/4"=1'

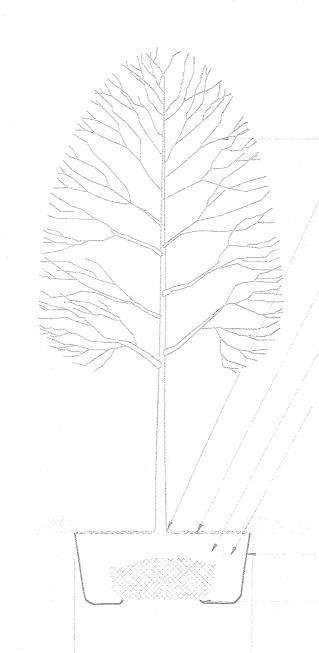

EXCAVATE 2X DIAMETER

OF ROOTBALL

18" DIAMETER ORGANIC MULCH RING, 2" DEPTH

TREE AS SPECIFIED

TRUNK FLARE SHALL BE

1-2" ABOVE GRADE.

EXCAVATE TO LOCATE

FLARE IF NECESSARY.

NOTES:

ROOTBALL.

SET TREE PLUMB.

TOP OF THE ROOTBALL.

NECESSARY UNTIL IRRIGATION IS INSTALLED.

DIRECTED TO BY LANDSCAPE ARCHITECT.

REMOVE TWINE FROM TRUNK AND FOLD DOWN BURLAP TO

EXPOSE TOP 1/3 OF ROOTBALL

SCORE WALLS OF TREE PIT

SET ROOTBALL ON

2" HIGH SOIL BASE

BACKFILL WITH EXCAVATED SOIL

IS NOT EXPOSED, REMOVE SOIL AND EXPOSE.

2. DO NOT STAKE UNLESS DIRECTED TO DO SO BY LANDSCAPE ARCHITECT

5. SATURATE SOIL WITHIN SIX (6) HOURS OF PLANTING AND WATER AS

6. DO NOT ADD ANY SOIL AMENDMENTS OTHER THAN COMPOST UNLESS

7. DO NOT ADD ANY SOIL OR MULCH AGAINST TRUNK OF TREE. IF ROOT FLARE

3. REMOVE COMPLETELY ANY NON-BIODEGRADABLE MATERIALS BINDING THE

4. REMOVE WIRE BASKET COMPLETELY IF ROOTBALL WILL BARE. OTHERWISE,

CLIP AND PEEL BACK WIRE BASKET AT LEAST ONE THIRD OF THE WAY FROM THE



SHRUB, AS SPECIFIED 2" DEEP ORGANIC MULCH RING

BACKFILL WITH TOPSOIL

SET PLANT PLUMB IN EXCAVATED HOLE

1. FOR B & B PLANT MATERIAL, REMOVE ALL TWINE AND ROLL BACK BURLAP FROM TOP 1/2 OF BALL. IF ANY MATERIALS USED TO BIND THE ROOTBALL ARE NON-BIODEGRADEABLE, REMOVE COMPLETELY INCLUDING WIRE BASKET.

2. FOR CONTAINER GROWN PLANT MATERIAL, REMOVE CONTAINER. TO HELP PREVENT LOOSENING OF SOIL AND SCARIFY BALL TO HELP PREVENT GIRDLING

3. SATURATE SOIL WITHIN SIX (6) HOURS OF PLANTING, AND WATER AS NECESSARY UNTIL IRRIGATION INSTALLED.


4. NO MULCH OR SOIL SHOULD BE PLACED AGAINST THE PLANT'S TRUNK.

3 SHRUB PLANTING L-801 SCALE: 1/2"=1'

> POSITION ROOT CROWN AT FINISHED GRADE 2" MULCH

NOTES:

REMOVE CONTAINER AND GENTLY LOOSEN ROOTS ROTOTILL 2" TOPSOIL AND 2" OF COMPOST INTO NATIVE SOIL UNLESS LANDSCAPE ARCHITECT SPECIFIES OTHERWISE

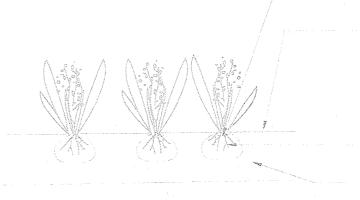

4 GROUNDCOVER PLANTING L-801 SCALE:1/2"=1'

200

178 elizabeth st

pearl river, ny 10965

p 845.365.4595 | f 914.361.4473

yostdesign.com

DATE: NOVEMBER 12, 2021 DRAWN BY: AVM JOB NO: 090721 SCALE: 1"-20' FILENAME: 12011-Site

REVISIONS:

Blythe M Yost ASLA | Registered Landscape Architect

PLANTING DETAILS

SHEET NO.

2/1/22	4	FOR TOWN PLANNING BOARD SUBMISSION	PEF
11/23/21	3	ADDITION OF A/C UNITS	PEF
11/5/21	2	PER TOWN ENGINEER	PEF
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DATE	NO.	REVISION	CHK'D
	11/23/21 11/5/21 5/7/21	11/23/21 3 11/5/21 2 5/7/21 1	11/23/21 3 ADDITION OF A/C UNITS 11/5/21 2 PER TOWN ENGINEER 5/7/21 1 PER TOWN PLANNING BOARD ENGINEER



ROCKLAND COUNTY - NEW YORK



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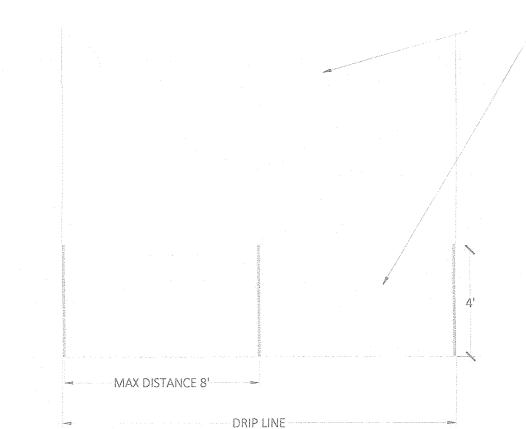
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DATE: DECEMBER 18, 2020 DRAWN BY COD SCALE: NOT TO SCALE JOB No.: 12011

CHECKED BY: PEF SHEET: 5 OF 5



5 TREE PROTECTION L-801 SCALE: 1/4"=1"

L-801 SCALE: 1/4"=1"

- ORANGE PLASTIC BARRIER FENCE WITH STEEL POSTS INSTALLED AT 8' O.C. NOTES: 1. ORANGE BARRIER FENCING SHALL BE USED TO


EXISTING TREE TO BE PROCTECTED

PROTECT ALL EXISTING TREES AND ROOT ZONES. 2. FENCING SHALL CREATE A ZONE OF PROTECTION WITH A MINIMUM RADIUS OF 1' FROM TREE TRUNK FOR EVERY

1" OF OF TRUNK DIAMETER (I.E. 12"DBH TREE=12' RADIUS ROOT ZONE PROTECTION) 3. NO CONSTRUCTION MATERIALS OR DEBRIS SHALL BE STORED INSIDE OF THE FENCING.

4. THE FENCING SHALL BE INSTALLED PRIOR TO THE COMMENCEMENT OF CONSTRUCTION ACTIVITIES, AND SHALL BE REMOVED WHEN CONTRUCTION IS COMPLETE.


5. THE OWNER SHALL BE INFORMED IMMEDIATELY OF ANY DAMAGE TO EXISTING TREES TO BE PRESERVED, INCLUDING BARK AND BRANCH DAMAGE.

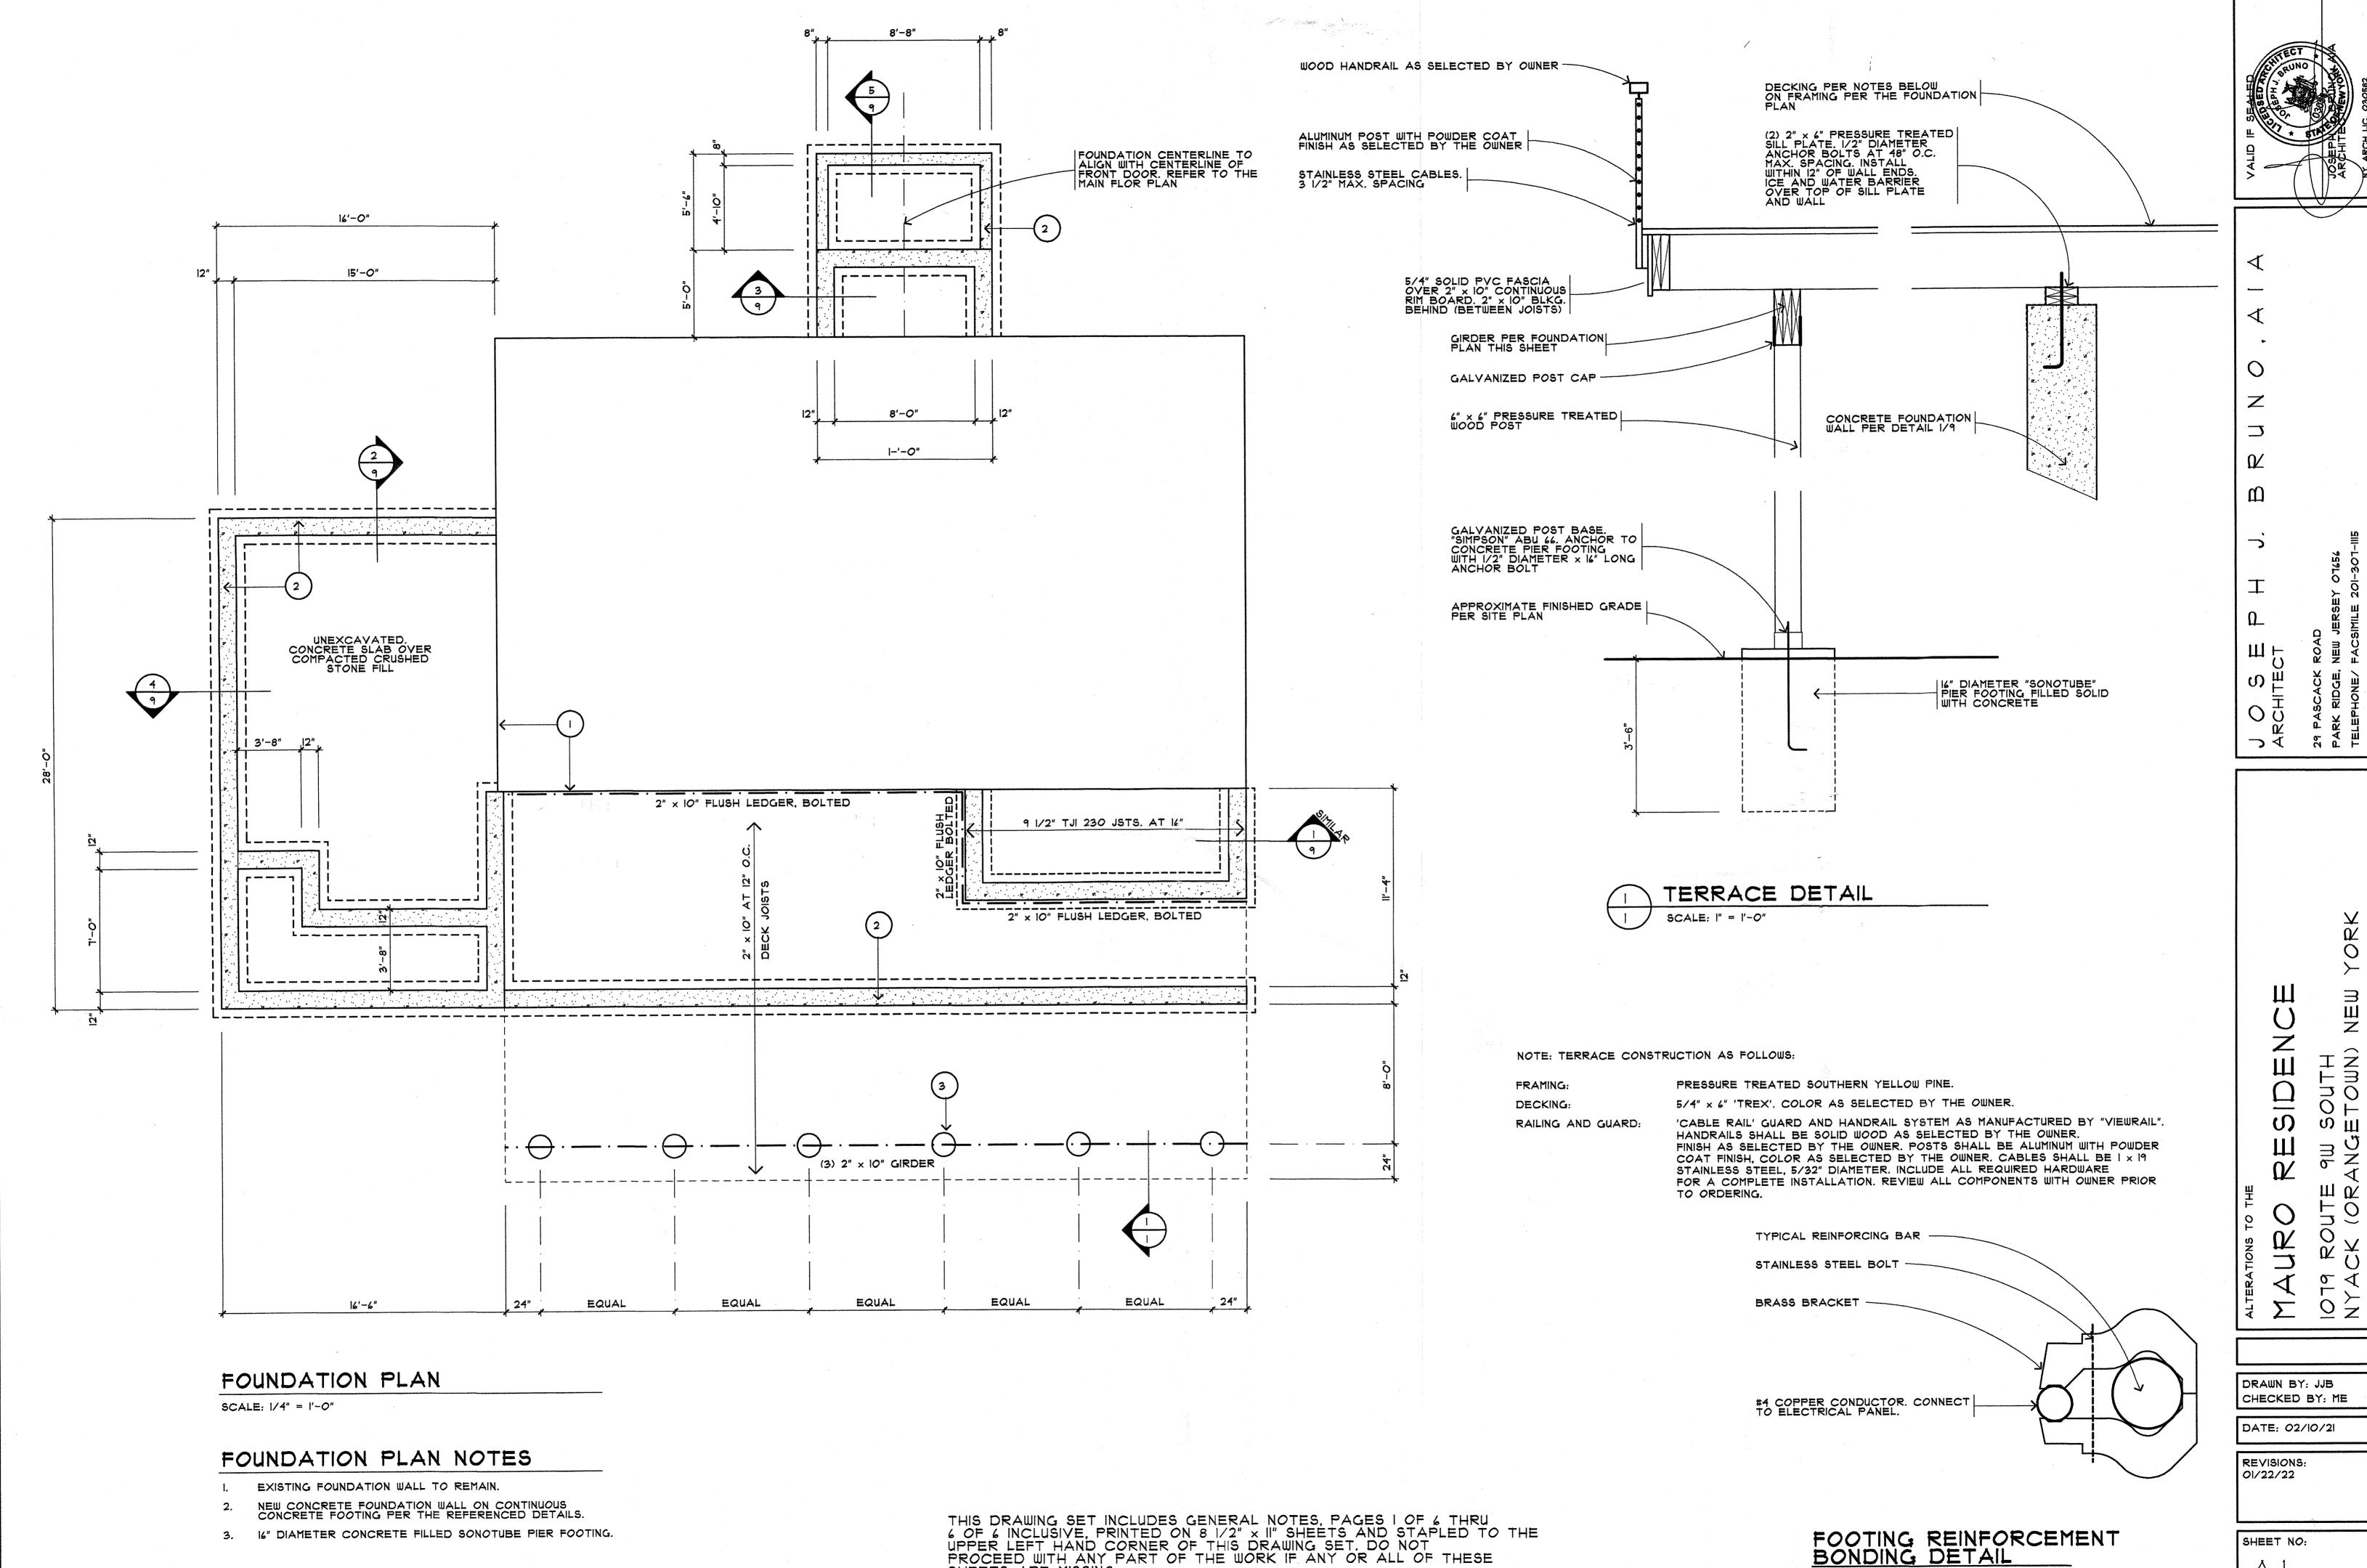

SHEETS ARE MISSING.

of 13

NOT TO SCALE

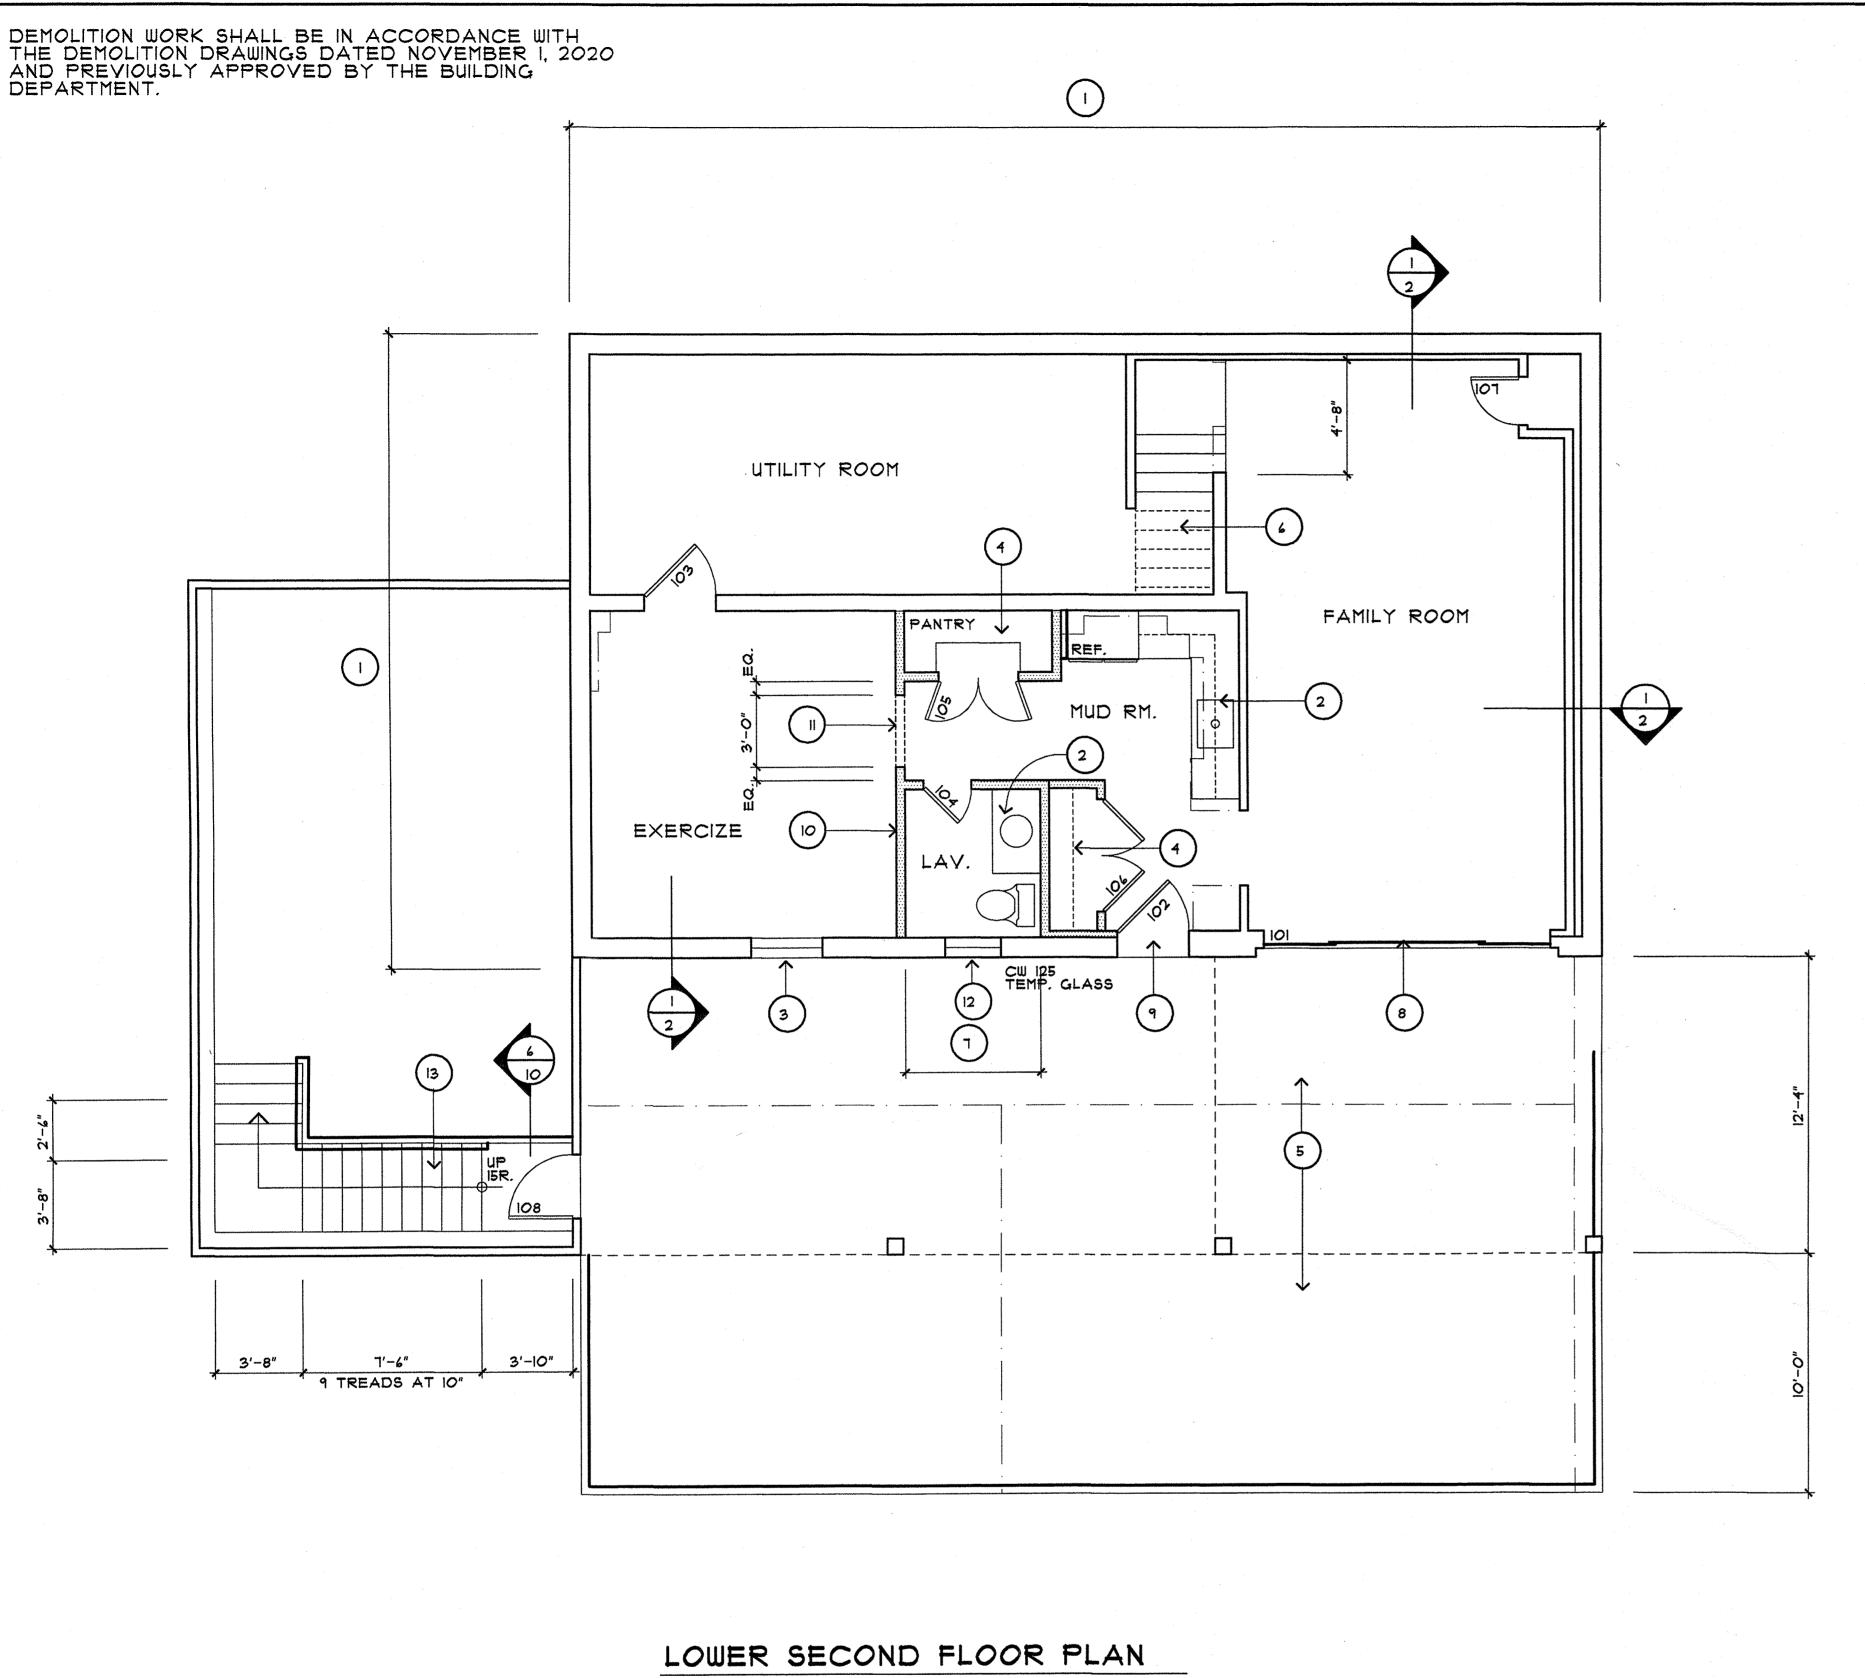

SCALE: 1/4" = 1'-0"

ALL WINDOW AND DOOR HEADER SHALL BE (2) $2" \times 12"$ UNLESS NOTED OTHERWISE.

PAIR 1'-8" × 6'-8" × 1 3/8"

LOWER SECOND FLOOR DOOR SCHEDULE

ANDERSEN FRENCHWOOD GLIDING DOOR UNIT. FWG 120611-4 FWH 31611 ANDERSEN FRENCHWOOD HINGED DOOR UNIT. PASSAGE LOCKSET. 3'-0" × 6'-8" × 1 3/4" PRIVACY LOCKSET. 2'-4" × 6'-8" × 1 3/8"

FLOOR PLAN LEGEND

PAIR 2'-4" x 6'-8" x 1 3/8" 2'-0" × 6'-8" × 1 3/8"

2'-8" × 6'-8" × 1 3/4"

PASSAGE LOCKSET.

DUMMY TRIM. BALL CATCHES.

DUMMY TRIM. BALL CATCHES.

ENTRANCE UNIT AS SELECTED BY THE OWNER. ALLOW \$2,500,00 FOR PURCHASE

EXISTING CONSTRUCTION TO BE REMOVED.

EXISTING CONSTRUCTION TO REMAIN.

NEW CONSTRUCTION.

LOWER SECOND FLOOR PLAN NOTES

RE-CONFIGURE PLUMBING AND ELECTRICAL WORK TO SUIT THE NEW LAYOUT. REFER TO OTHER ASPECTS OF THESE DRAWINGS AND GENERAL NOTES FOR ADDITIONAL INFORMATION.

FINISH PERIMETER EXTERIOR MASONRY WALLS PER THE REFERENCED DETAILS.

INSULATE INTERIOR PERIMETER LAVATORY WALLS WITH 3 1/2" BATT SOUND INSULATION.

FINISH WALLS AND CEILINGS WITH 1/2" GYPSUM BOARD. SHIM CEILINGS LEVEL AS MAY BE REQUIRED BY FIELD CONDITIONS. REFER TO BATH FINISH NOTES FOR ADDITIONAL INFORMATION.

FLOOR FINISHES AS DIRECTED BY THE OWNER. FOR BIDDING PURPOSES ASSUME 4" SELECT RED OAK. STAIN AS SELECTED BY THE OWNER. TWO COATS SATIN POLYURETHANE OVER.

MOULDINGS AS SELECTED BY THE OWNER.

CABINETRY PER THE GENERAL NOTES.

REMOVE EXISTING WINDOW UNIT IN ENTIRETY. FURNISH AND INSTALL NEW WINDOW SIZED TO FIT EXISTING MASONRY OPENING.

CLOSET ORGANIZER AS SELECTED BY THE OWNER.

EXISTING DECK AND GROUND SLAB TO BE REMOVED.

REMOVE EXISTING WOOD STAIR, GUARD AND HANDRAILS IN ENTIRETY. PROVIDE NEW WOOD STAIR PER DETAIL I/IO. GUARD AND HANDRAIL AS SELECTED BY THE OWNER.

7. LAVATORY INTERIOR FINISHES AS FOLLOWS:

WALLS: TILE WAINSCOT AS DIRECTED BY THE OWNER OVER 1/2" MOISTURE AND MOLD RESISTANT GYPSUM BOARD. CEILING: 5/8" MOISTURE AND MOLD RESISTANT GYPSUM BOARD.

FLOOR: TILE AS SELECTED BY THE OWNER THIN SET OVER ! 1/2" THK. CURED MUD BASE REINFORCED WITH GALVANIZED EXPANDED METAL LATH FASTENED TO THE CONCRETE FLOOR SLAB.

REMOVE THE EXISTING DOOR UNIT. MODIFY MASONRY WALL TO ACCOMMODATE THE NEW DOOR UNIT.

CUT OPENING IN EXISTING MASONRY WALL TO ACCOMMODATE NEW DOOR UNIT. RESTORE ADJACENT AFFECTED CONSTRUCTION TO REMAIN.

10. NEW FRAME PARTITION PER DETAIL 1/3.

6'-8" HIGH TRIMMED OPENING.

CUT OPENING IN EXISTING MASONRY WALL TO ACCOMMODATE NEW WINDOW UNIT. RESTORE ADJACENT AFFECTED CONSTRUCTION TO REMAIN.

WOOD STAIR SIMILAR TO DETAIL I/IO. YELLOW PINE TREADS AND RISERS.
GUARD AND HANDRAIL PER THE REFERENCED DETAIL. WALL MOUNTED STEEL PIPE
HANDRAIL ALONG STAIR RUN.

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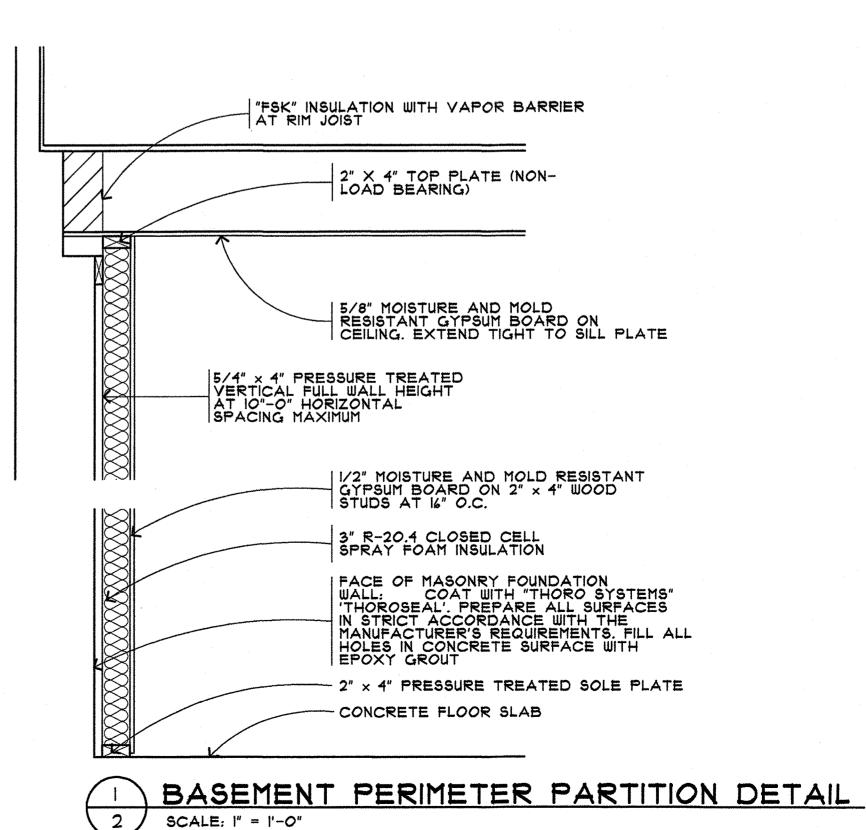
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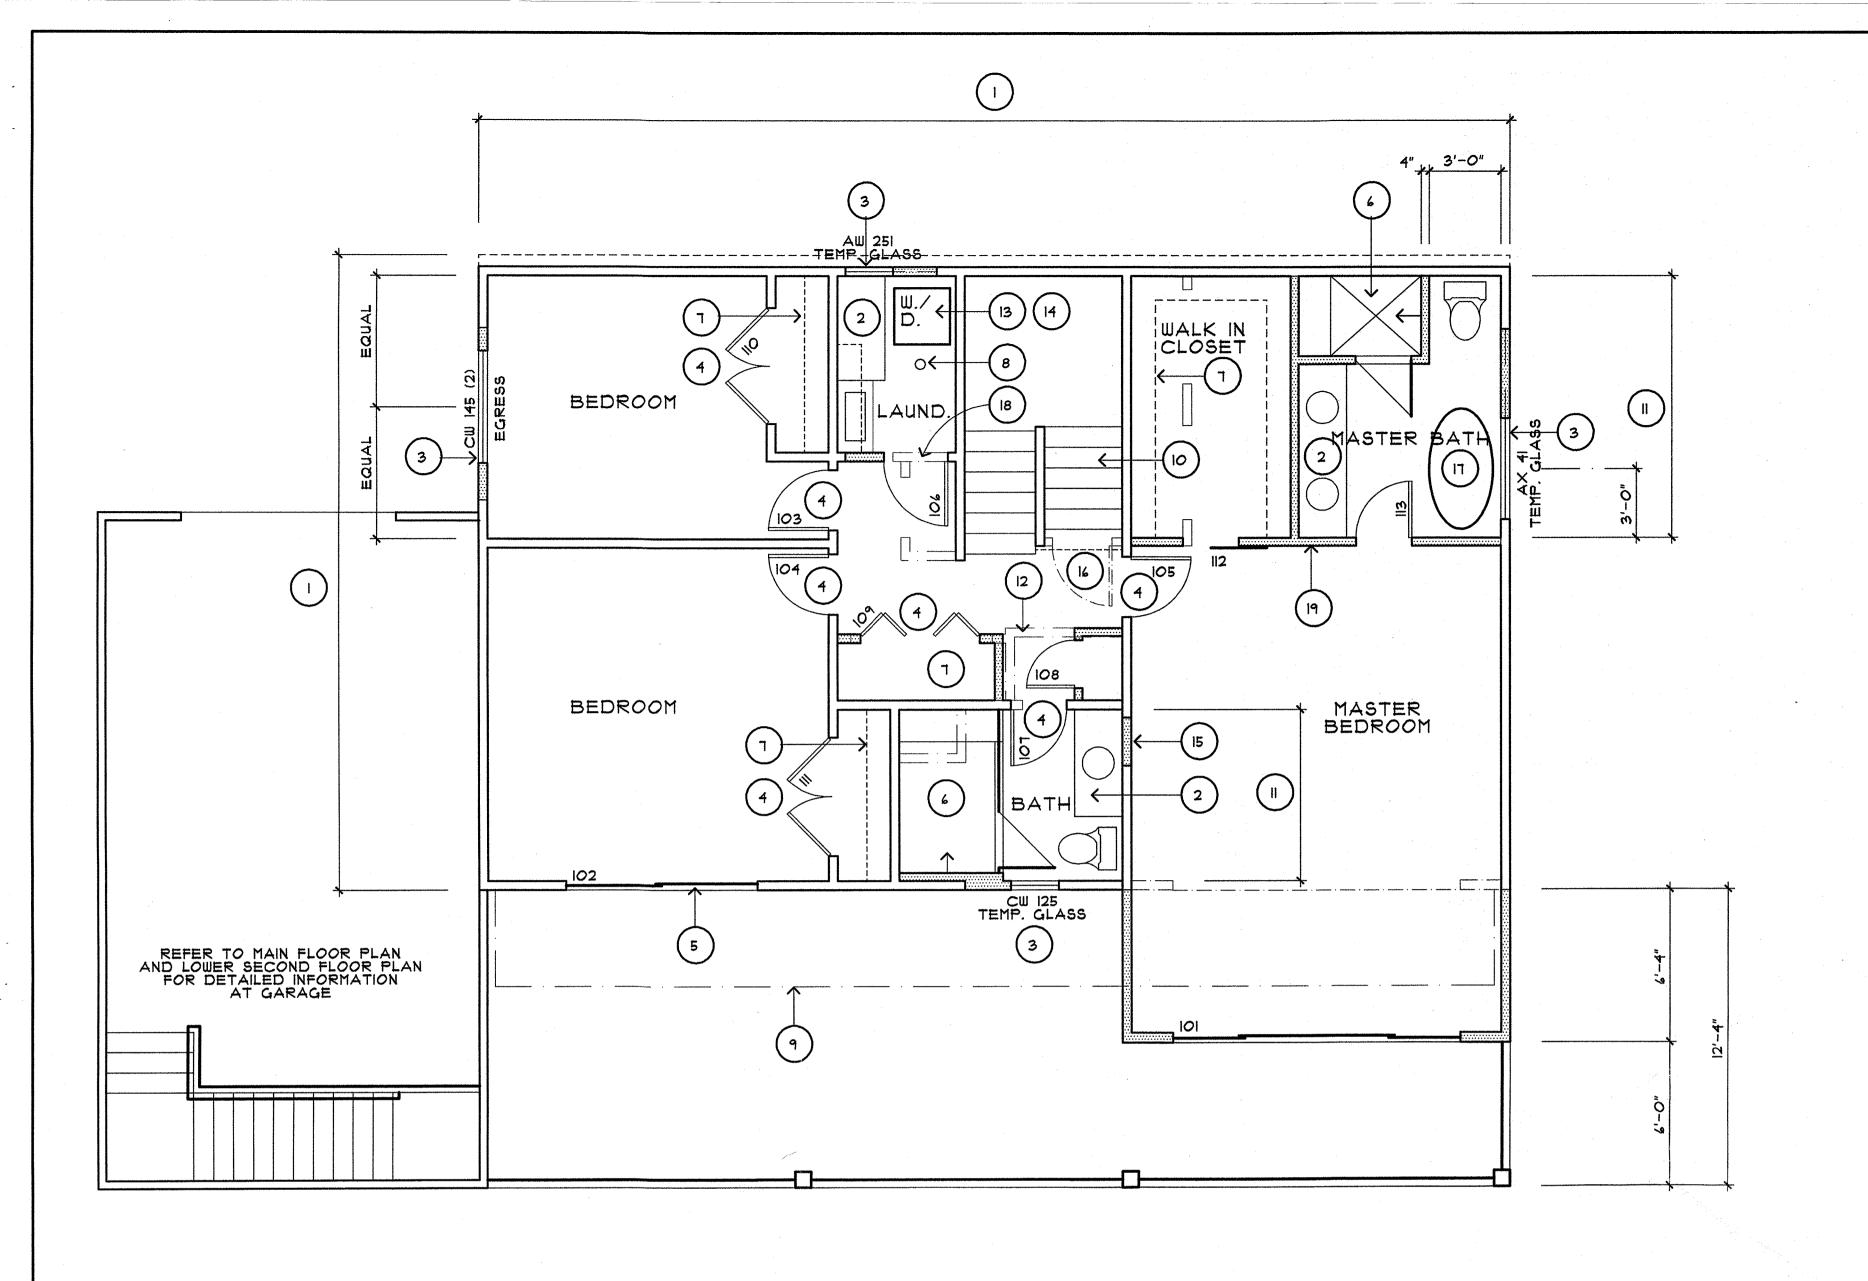
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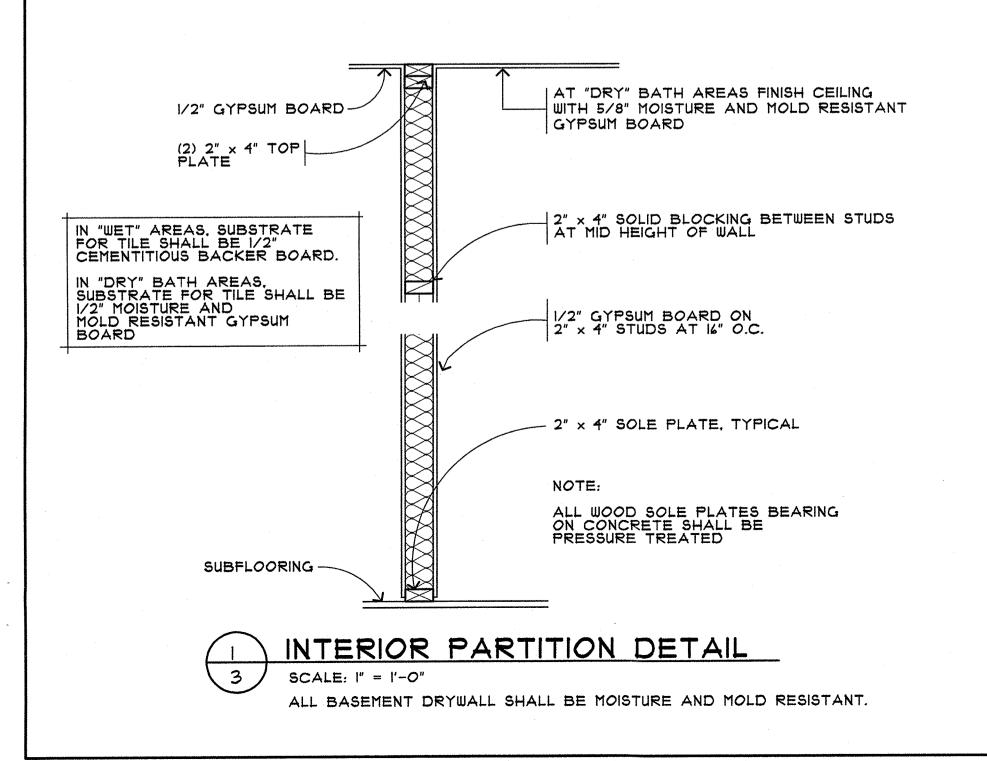
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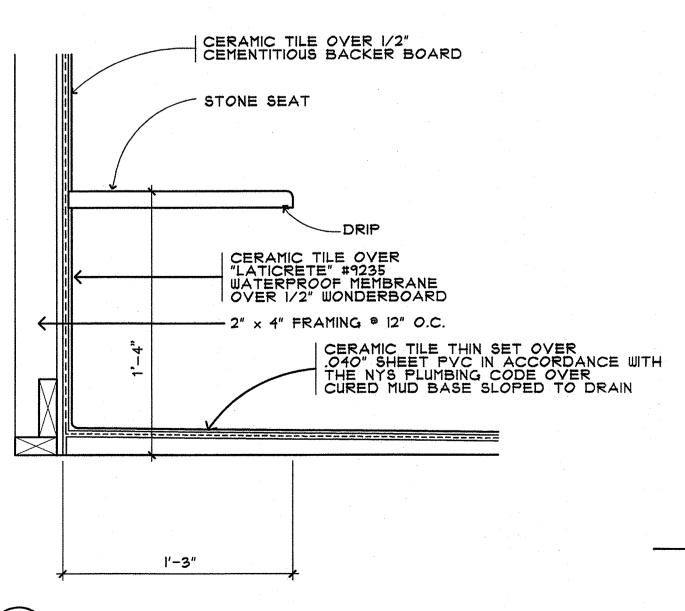





LOWER FIRST FLOOR PLAN NOTES

SCALE: 1/4" = 1'-0"





SHOWER SEAT DETAIL SCALE: |" = |'-0" THE CONNECTION BETWEEN THE SHOWER LINER AND DRAIN SHALL BE IN ACCORDANCE WITH THE NY STATE PLUMBING CODE.

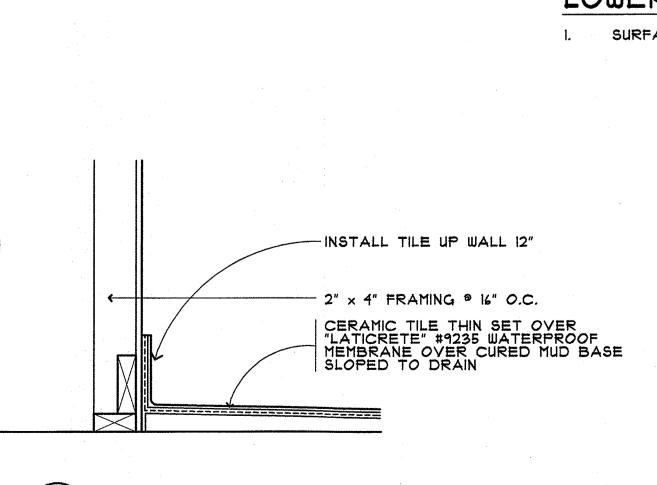

LAUNDRY FLOOR DETAIL THE CONNECTION BETWEEN THE SHOWER LINER AND DRAIN SHALL BE IN ACCORDANCE WITH THE NY STATE PLUMBING CODE.

LOWER FLOOR PLAN NOTES

RE-CONFIGURE PLUMBING AND ELECTRICAL WORK TO SUIT THE NEW LAYOUT.
REFER TO OTHER ASPECTS OF THESE DRAWINGS AND GENERAL NOTES FOR ADDITIONAL INFORMATION. INSULATE EXTEROR WALLS WITH 5" R-34 CLOSED CELL SPRAY

INSULATE INTERIOR PERIMETER LAVATORY AND BEDROOM WALLS WITH 3 1/2" BATT SOUND INSULATION. FINISH WALLS AND CEILINGS WITH 1/2" GYPSUM BOARD. SHIM CEILINGS LEVEL AS MAY BE REQUIRED BY FIELD CONDITIONS. REFER TO BATH FINISH NOTES FOR ADDITIONAL INFORMATION. FURR EXTERIOR WALLS TO ACCOMMODATE INSUL.

FLOOR FINISHES AS DIRECTED BY THE OWNER. FOR BIDDING PURPOSES ASSUME 4" SELECT RED OAK. STAIN AS SELECTED BY THE OWNER. TWO COATS SATIN POLYURETHANE OVER.

MOULDINGS AS SELECTED BY THE OWNER.

2. CABINETRY PER THE GENERAL NOTES.

- REMOVE EXISTING WINDOW UNIT IN ENTIRETY. MODIFY FRAMING TO ACCOMMODATE THE NEW WINDOW UNIT INDICATED.
- REMOVE THE EXISTING DOOR UNIT, MODIFY FRAMING TO ACCOMMODATE THE NEW DOOR UNIT.
- REMOVE THE EXISTING WINDOW UNIT. MODIFY FRAMING TO ACCOMMODATE THE NEW DOOR UNIT.
- 6. SHOWER STALL PER DETAIL 2/3. TEMPERED GLASS DOOR AS SELECTED BY OWNER.
- CLOSET ORGANIZER AS SELECTED BY THE OWNER.
- FLOOR DRAIN WITH TRAP PRIMER, REFER TO DETAIL 3/3 FOR FLOOR WATERPROOFING.
- EXISTING BALCONY TO BE REMOVED.
- REMOVE EXISTING WOOD STAIR, GUARD AND HANDRAILS IN ENTIRETY. PROVIDE NEW WOOD STAIR PER DETAILS I/IO AND 2/IO. GUARD AND HANDRAIL AS SELECTED BY THE OWNER.
- BATH INTERIOR FINISHES AS FOLLOWS:

SHOWER WALLS AND CEILING: TILE AS SELECTED BY THE OWNER THIN SET OVER 1/2" CEMENTITIOUS BACKER BOARD. BALANCE OF WALLS: TILE WAINSCOT AS DIRECTED BY THE OWNER OVER 1/2" 1/2" CEMENTITIOUS BACKER BAORD. BALANCE OF CEILING: 5/8" MOISTURE AND MOLD RESISTANT GYPSUM BOARD. FLOOR: REFER TO DETAIL 1/4.

- 12. REMOVE EXISTING FRAME WALL TO EXTENT SHOWN.
- GAS CLOTHES DRYER. VENT TO EXTERIOR WITH GALVANIZED DUCT. PROVIDE HOODED CAP WITH BACKDRAFT DAMPER.
- CLOTHES WASHER, PROVIDE RECESSED WALL STATION WITH HOT AND COLD WATER SUPPLIES, DRAIN AND VENT CONNECTIONS.
- REMOVE EXISTING DOOR UNIT IN ENTIRETY. CLOSE OPENING WITH CONSTRUCTION TO MATCH EXISTING.
- REMOVE EXISTING DOORWAY WALL IN ENTIRETY.
- FREE STANDING TUB AS SELECTED BY THE OWNER.
- CUT OPENING IN EXISTING FRAME WALL AND FRAME TO ACCOMMODATE NEW DOOR UNIT.
- 19. NEW FRAME PARTITION PER DETAIL 1/3.

LOWER FIRST FLOOR DOOR SCHEDULE

101	FWG 120611-4	ANDERSEN FRENCHWOOD GLIDING DOOR UNIT.
102	FWG 80411	ANDERSEN FRENCHWOOD GLIDING DOOR UNIT.
103	2'-6" × 6'-8" × 1 3/8"	PRIVACY LOCKSET.
104	2'-6" × 6'-8" × 1 3/8"	PRIVACY LOCKSET.
105	2'-8" × 6'-8" × 1 3/8"	PRIVACY LOCKSET.
106	2'-8" × 6'-8" × 1 3/8"	PASSAGE LOCKSET. LOUVER DOOR.
107	2'-4" × 6'-8" × 1 3/8"	PRIVACY LOCKSET.
108	2'-0" × 6'-8" × 1 3/8"	PASSAGE LOCKSET.
109	5'-0" × 6'-8" × 1 3/8"	BI FOLD DOOR UNIT.
110	PAIR 2'-8" × 6'-8" × 1 3/8"	DUMMY TRIM. BALL CATCHES.
111	PAIR 2'-8" × 6'-8" × 1 3/8"	DUMMY TRIM. BALL CATCHES.
112	2'-4" × 6'-8" × 1 3/8"	SURFACE SLIDING DOOR UNIT. NOTE #1 BELOW.

LOWER FLOOR DOOR SCHEDULE NOTES

2'-8" × 6'-8" × 1 3/8"

SURFACE SLIDING DOOR UNIT HARDWARE AS SELECTED BY THE OWNER.

FLOOR PLAN LEGEND

EXISTING CONSTRUCTION TO REMAIN.

EXISTING CONSTRUCTION TO BE REMOVED.

PRIVACY LOCKSET.

NEW CONSTRUCTION.

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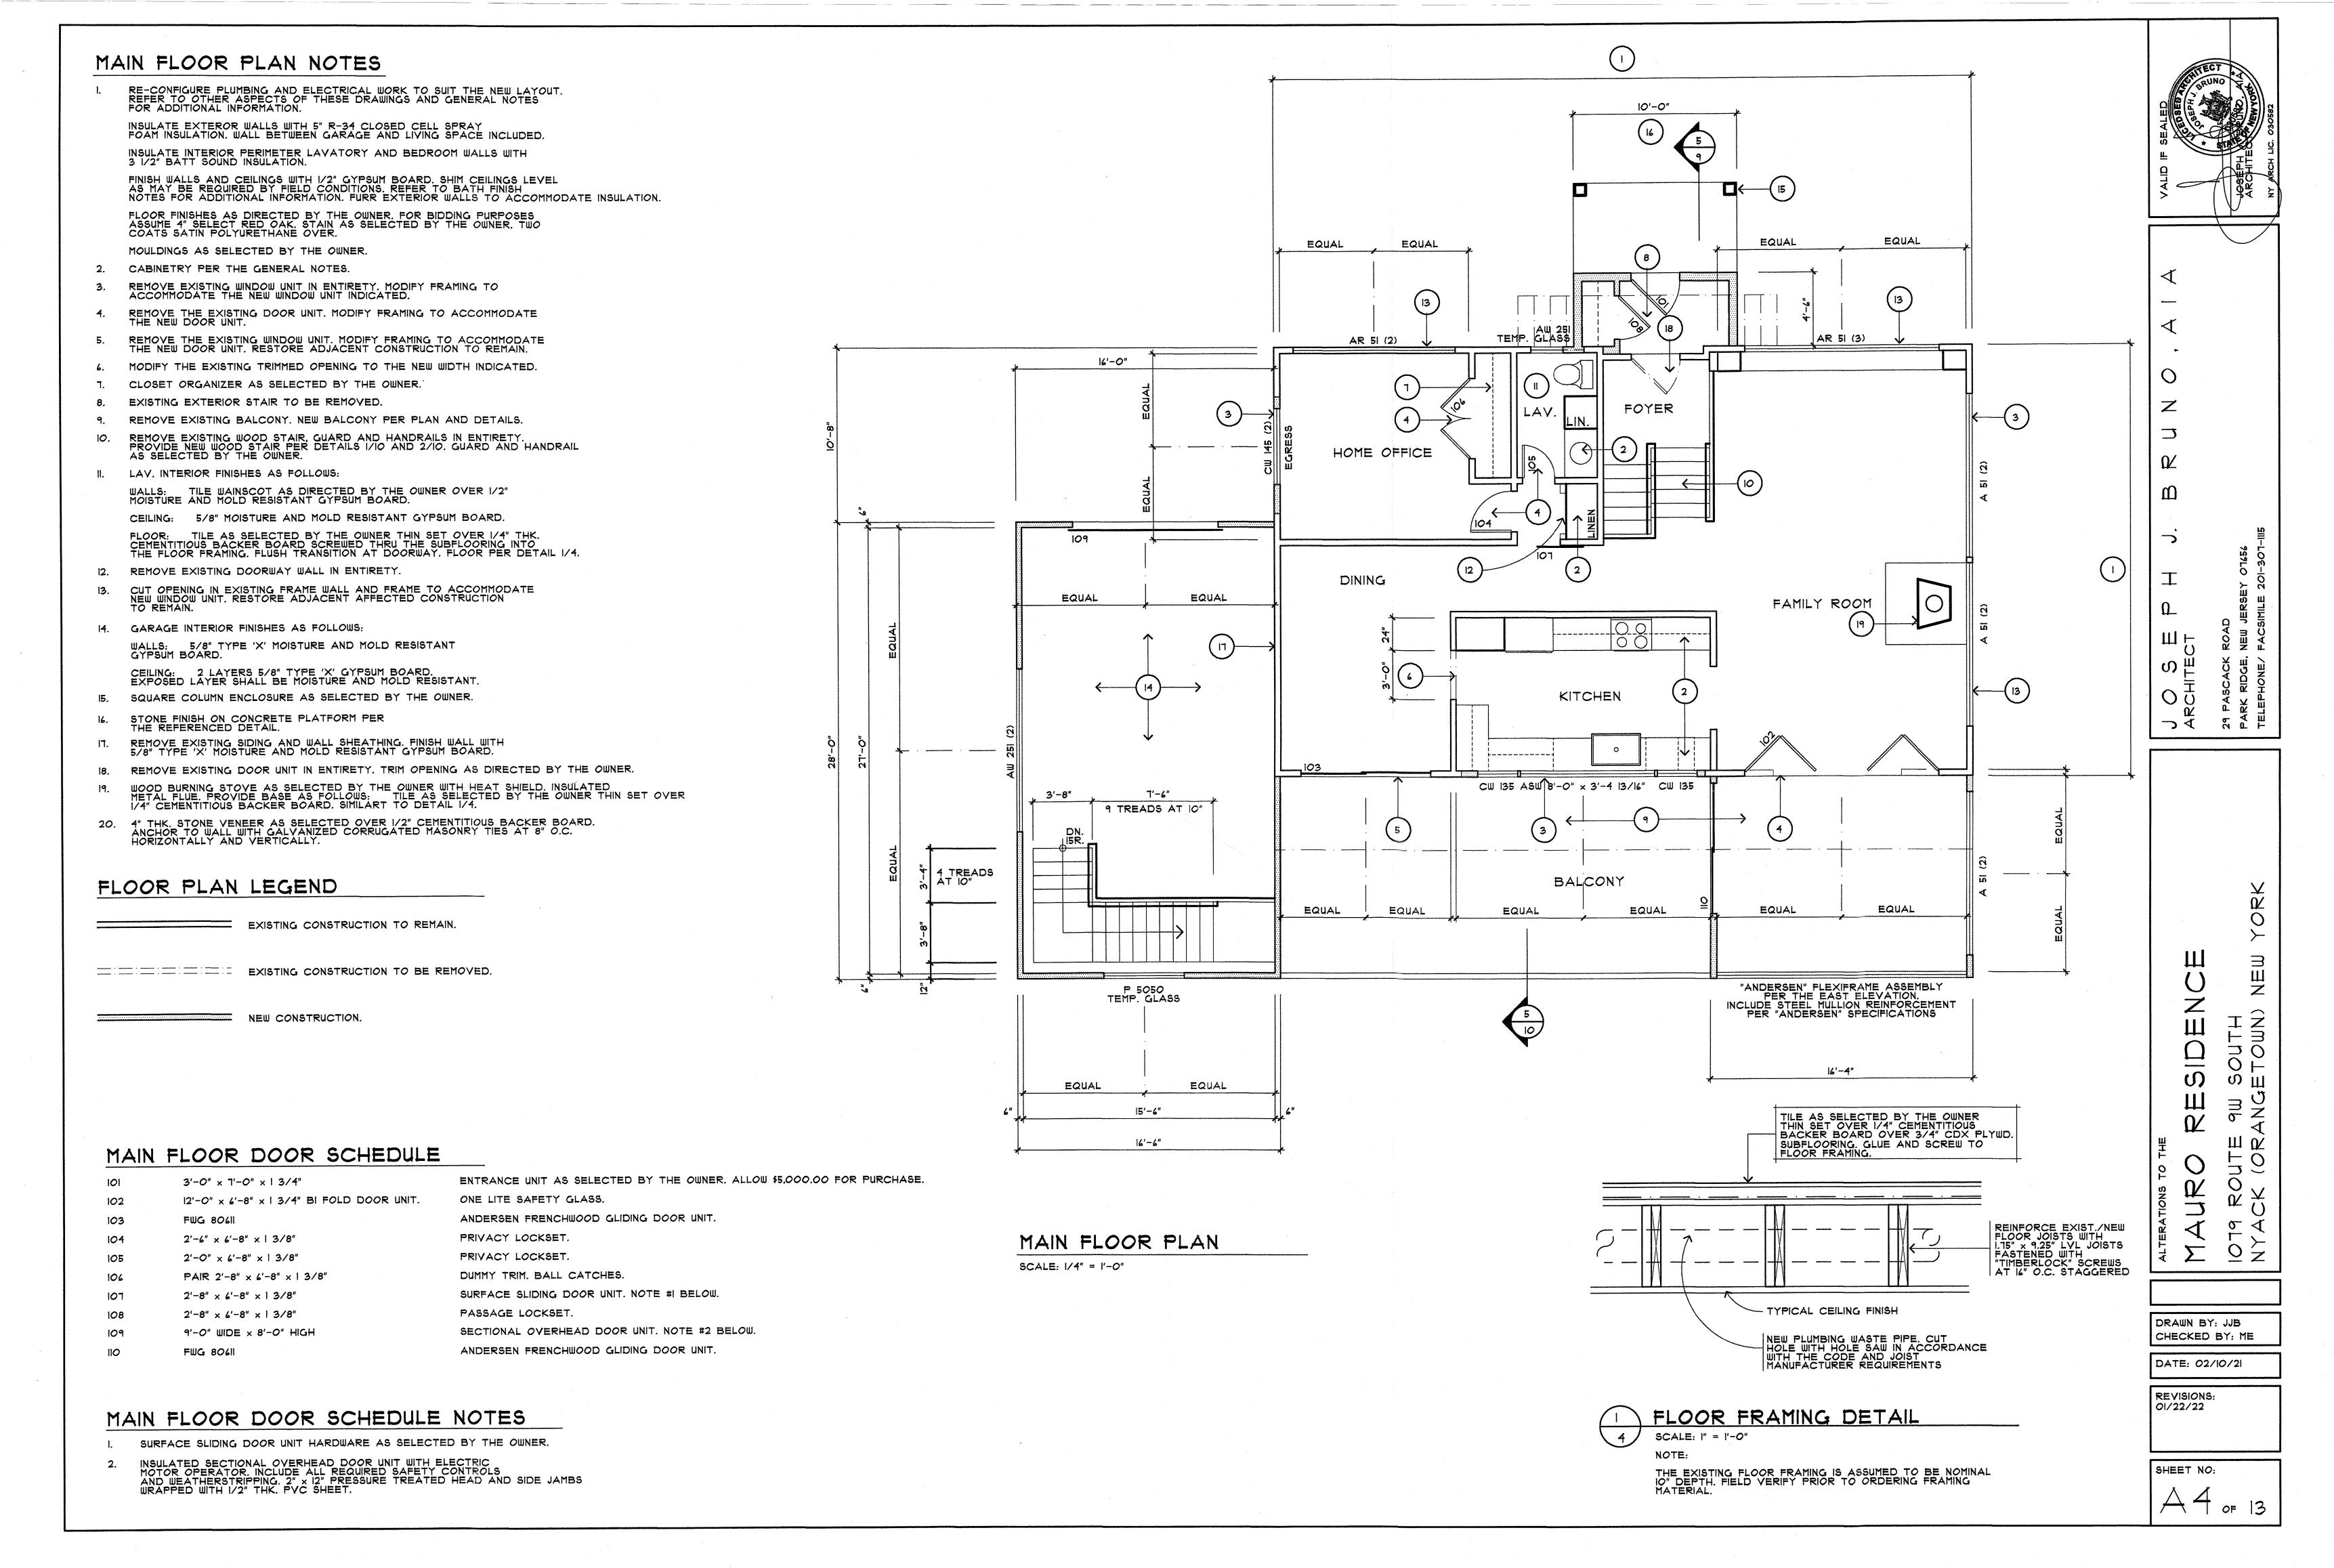
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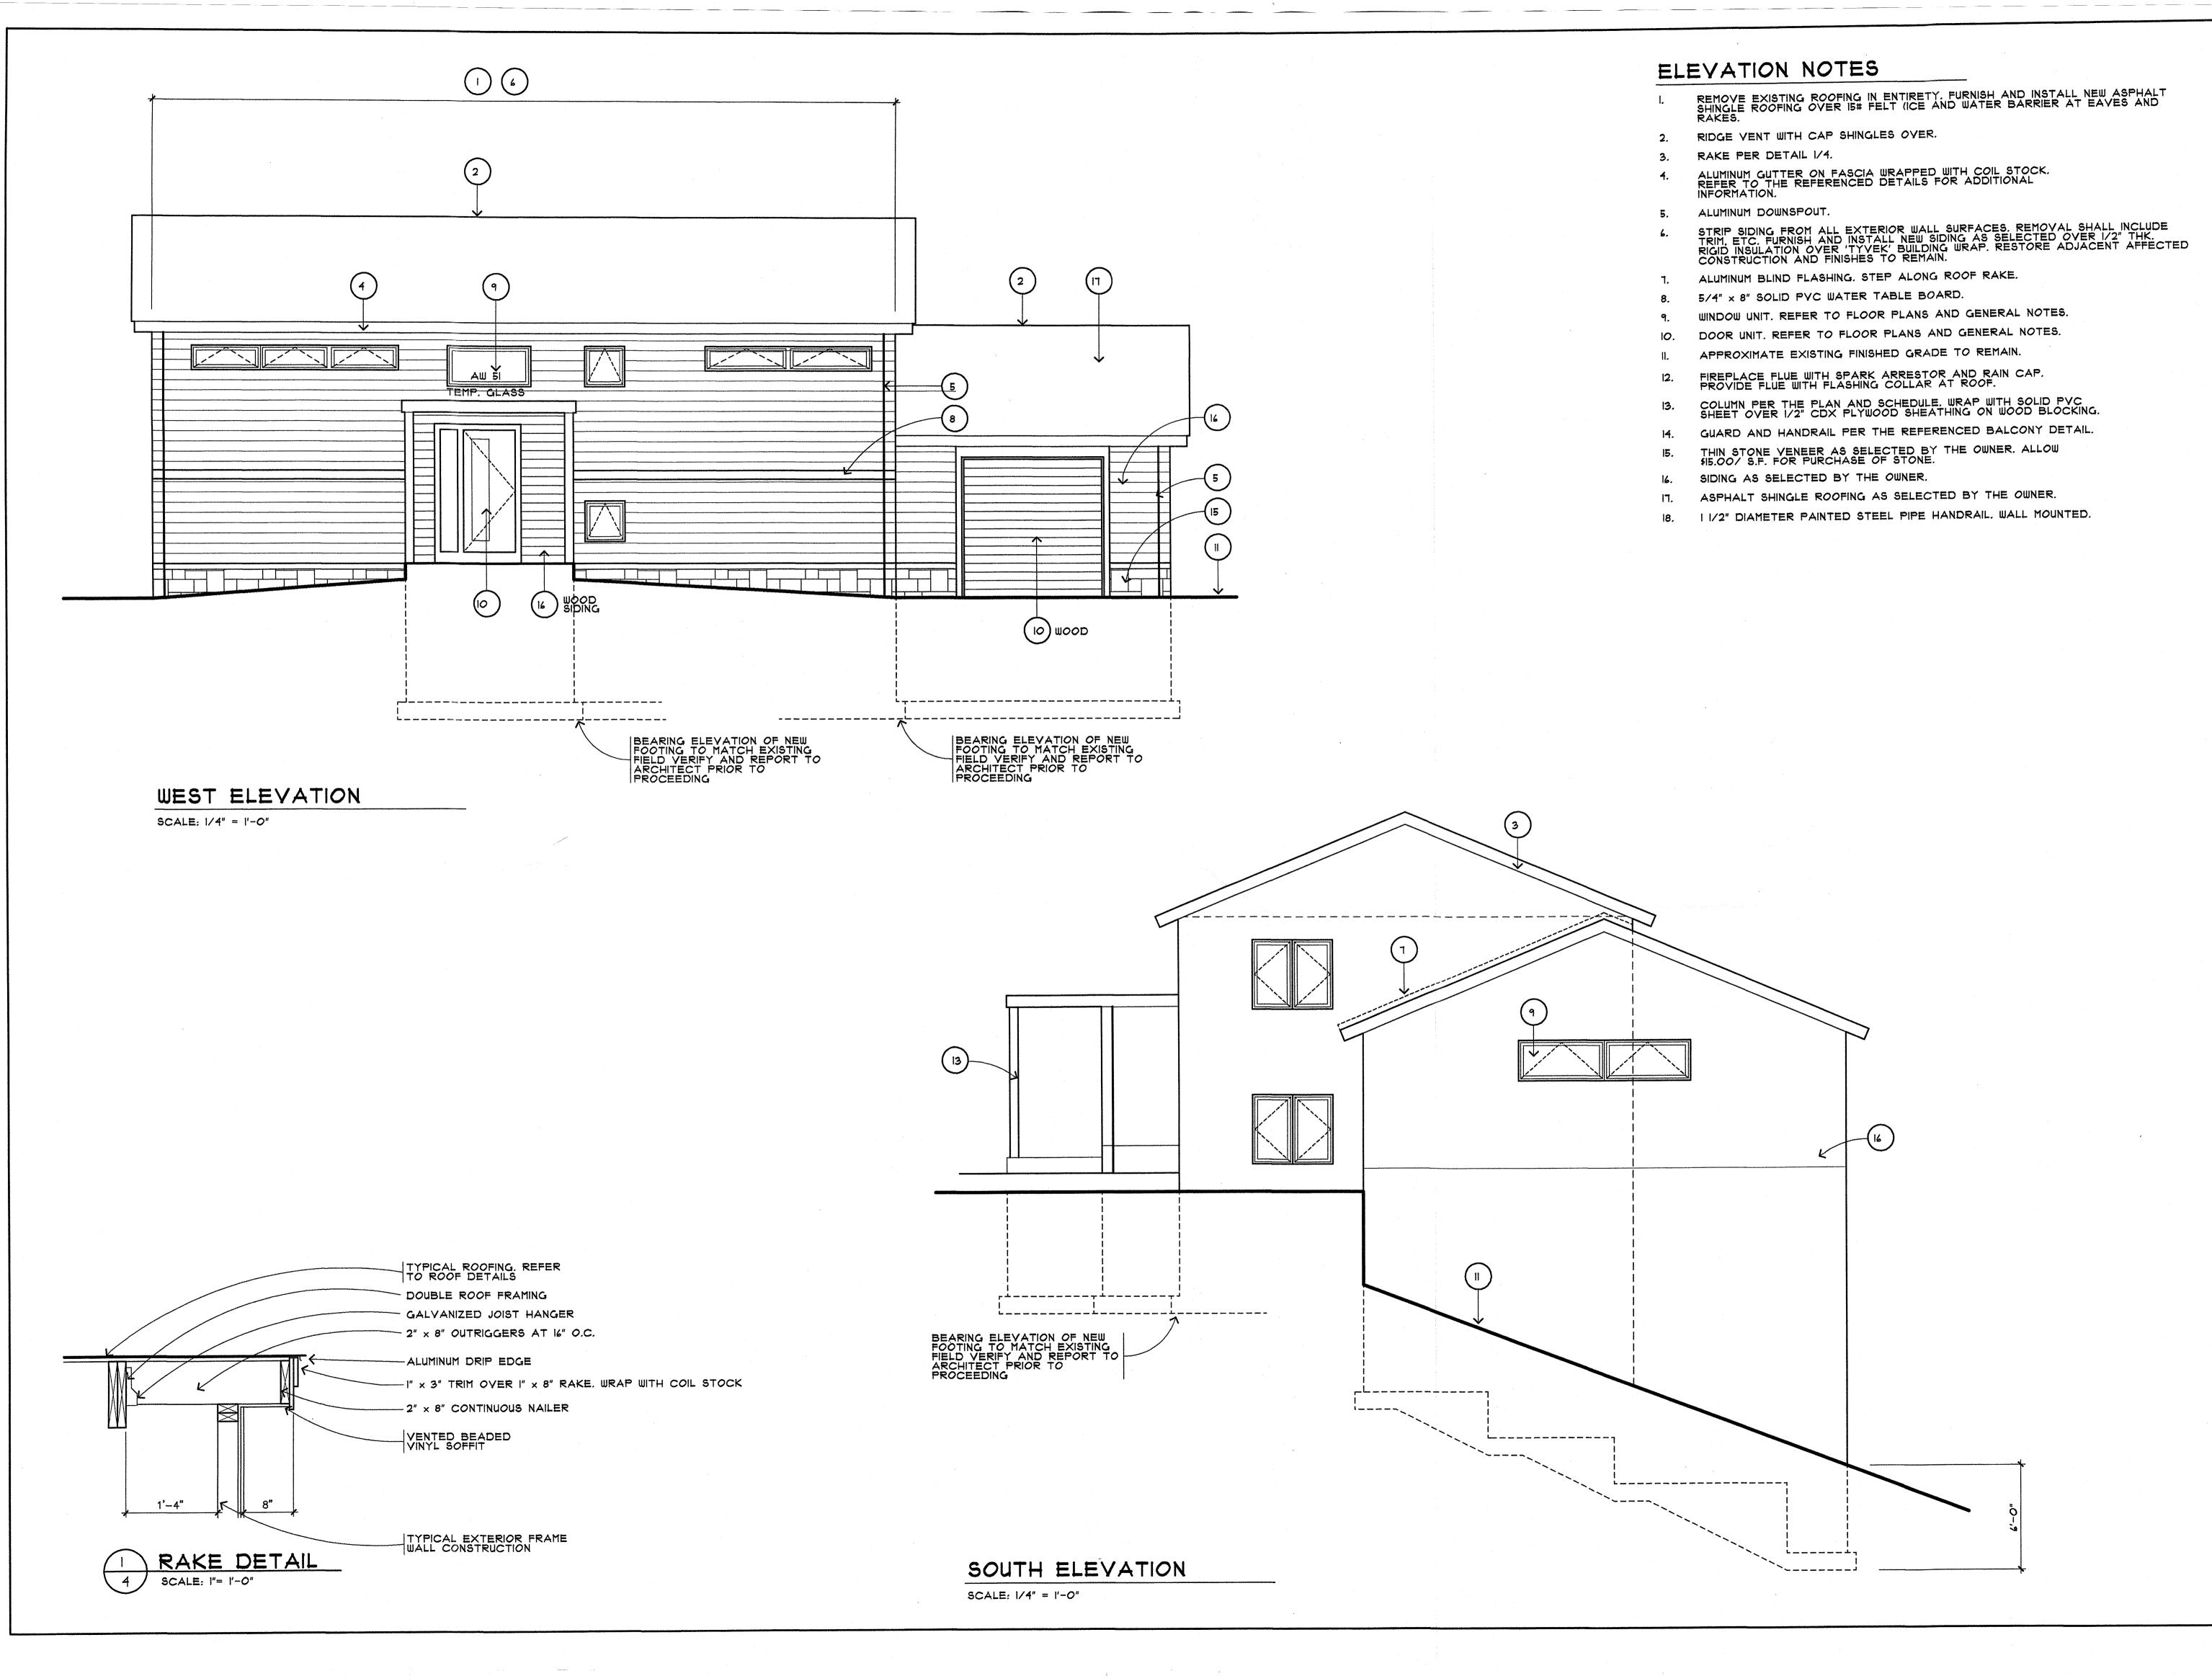
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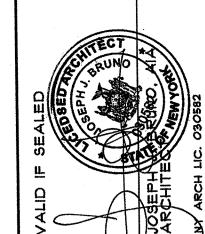
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OSEPH J. BRUNO, A

MAURO RESIDENCE
1019 ROUTE 9W SOUTH
NYACK (ORANGETONN) NEW YORK

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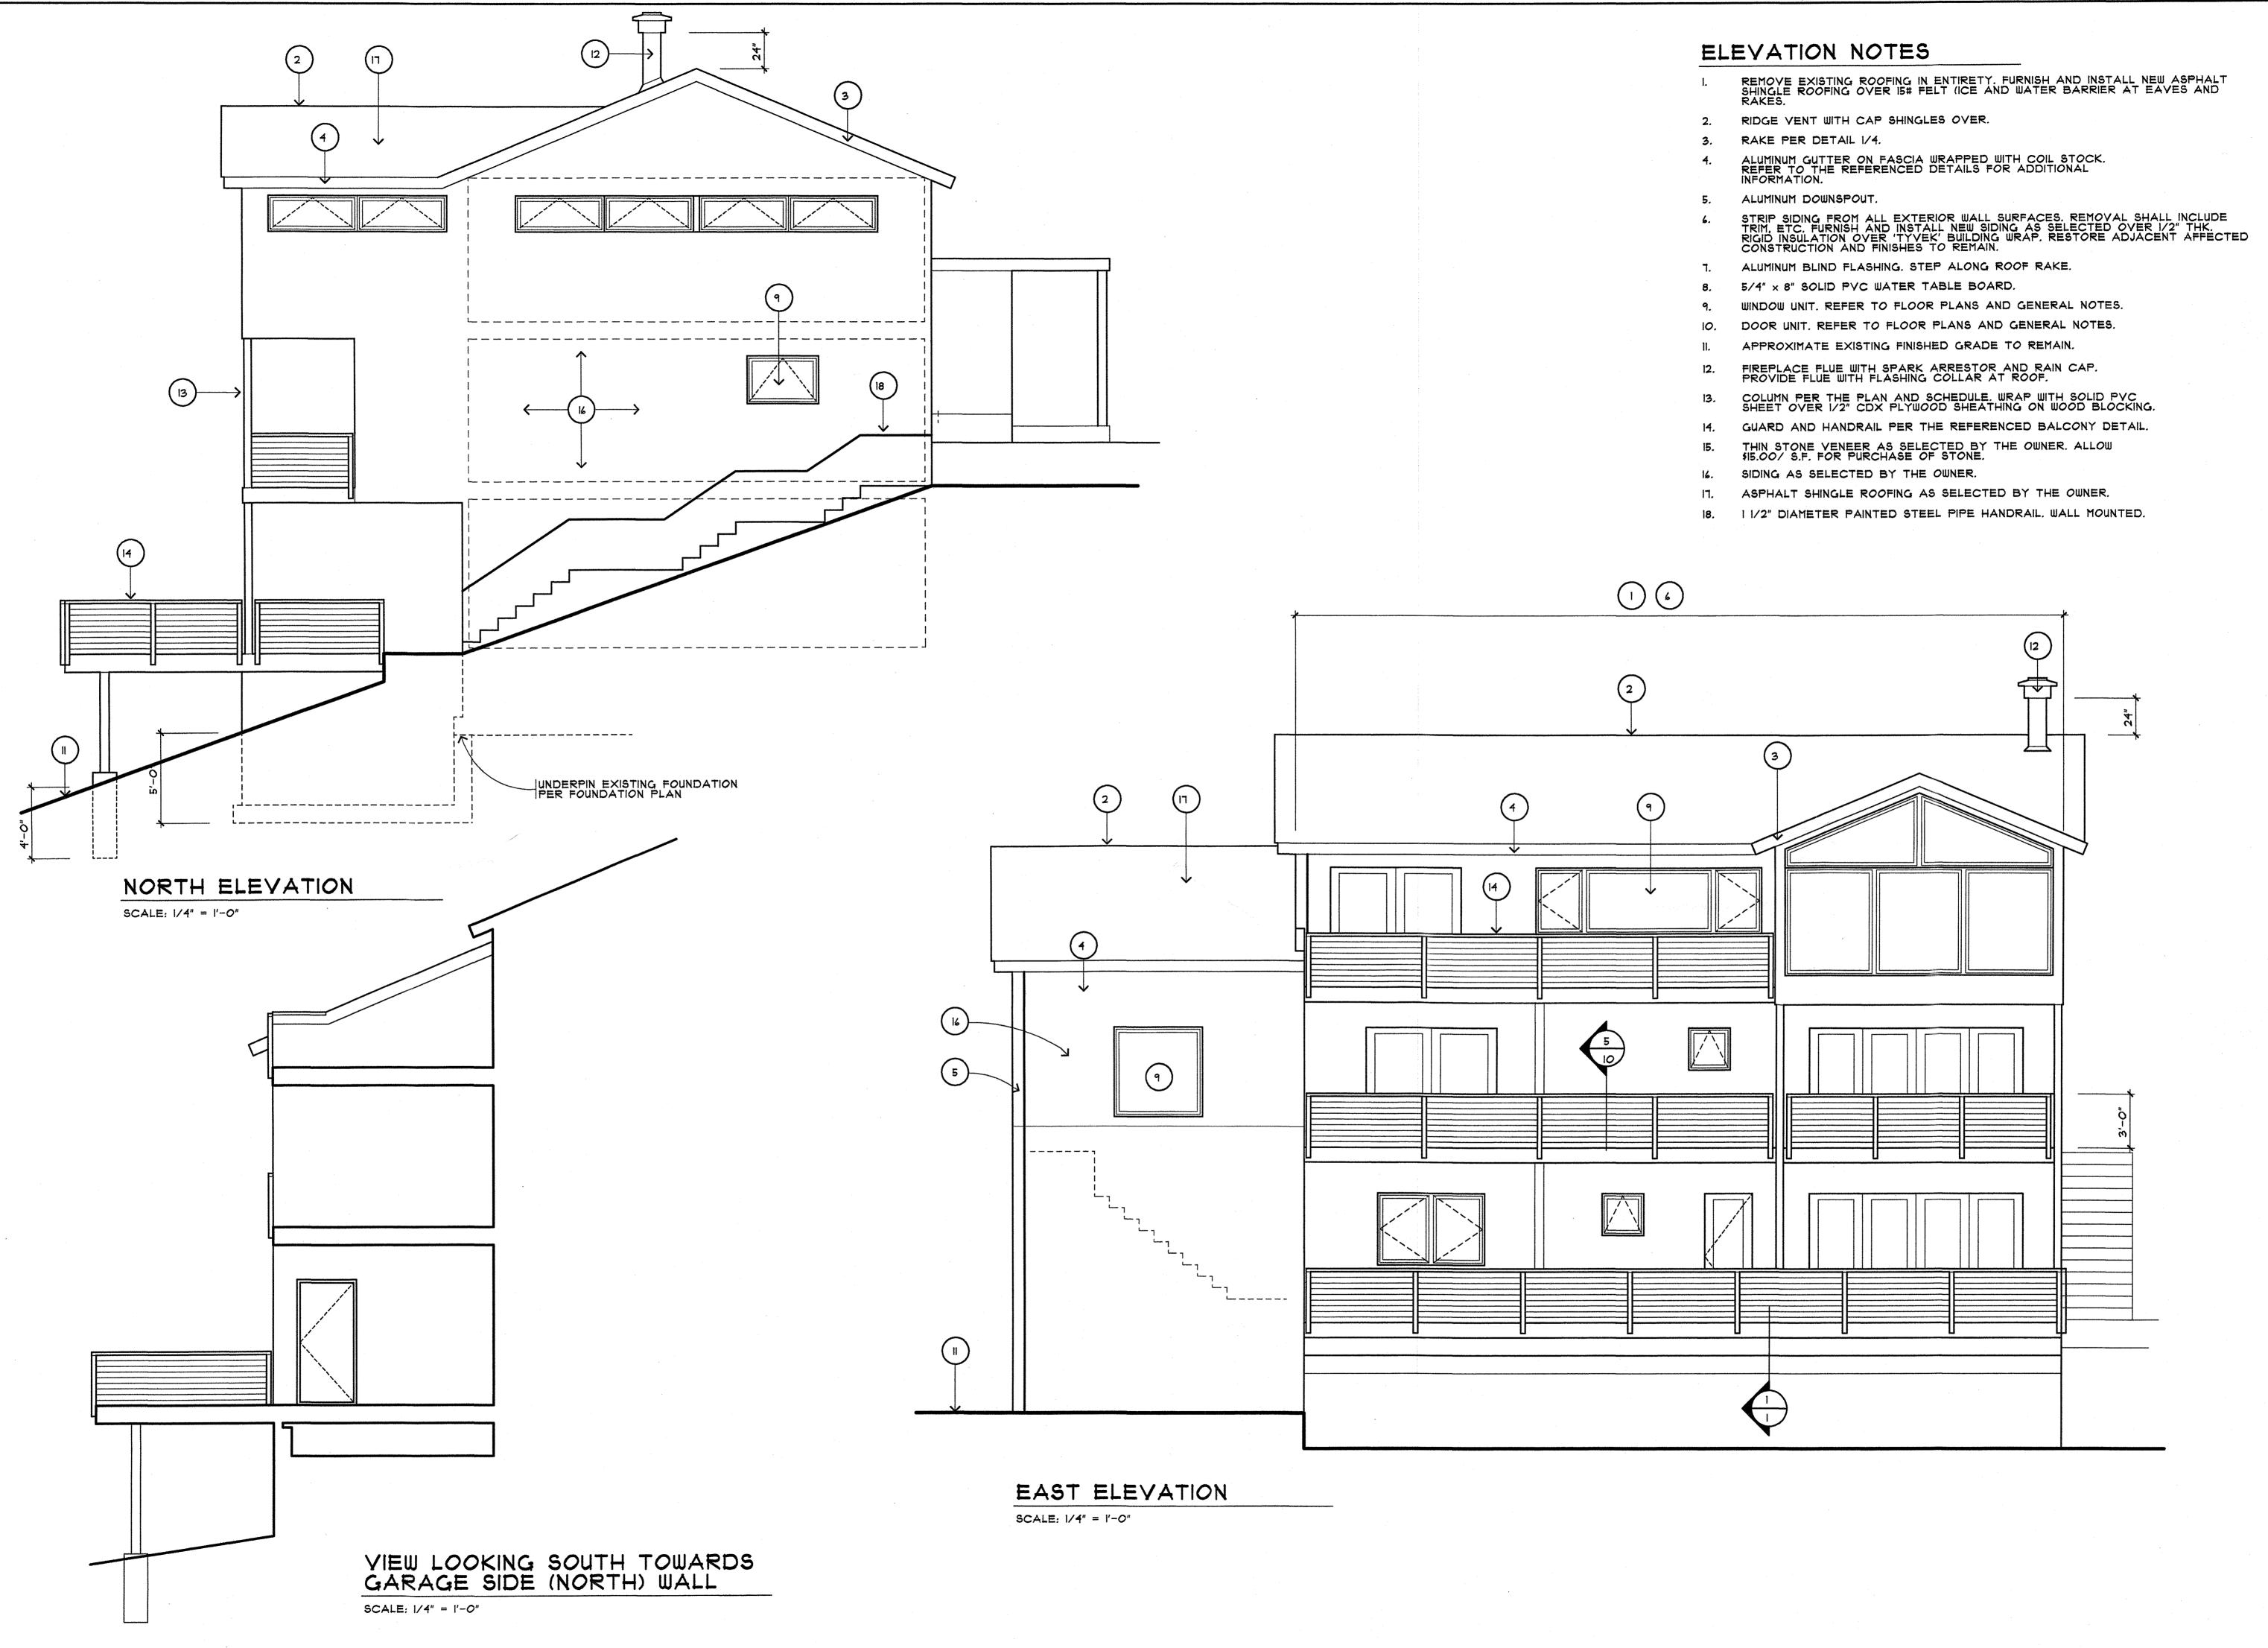
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J. BRUNO, A-A

JOSEPH ARCHITECT

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19 ROUTE 9W SOUTH


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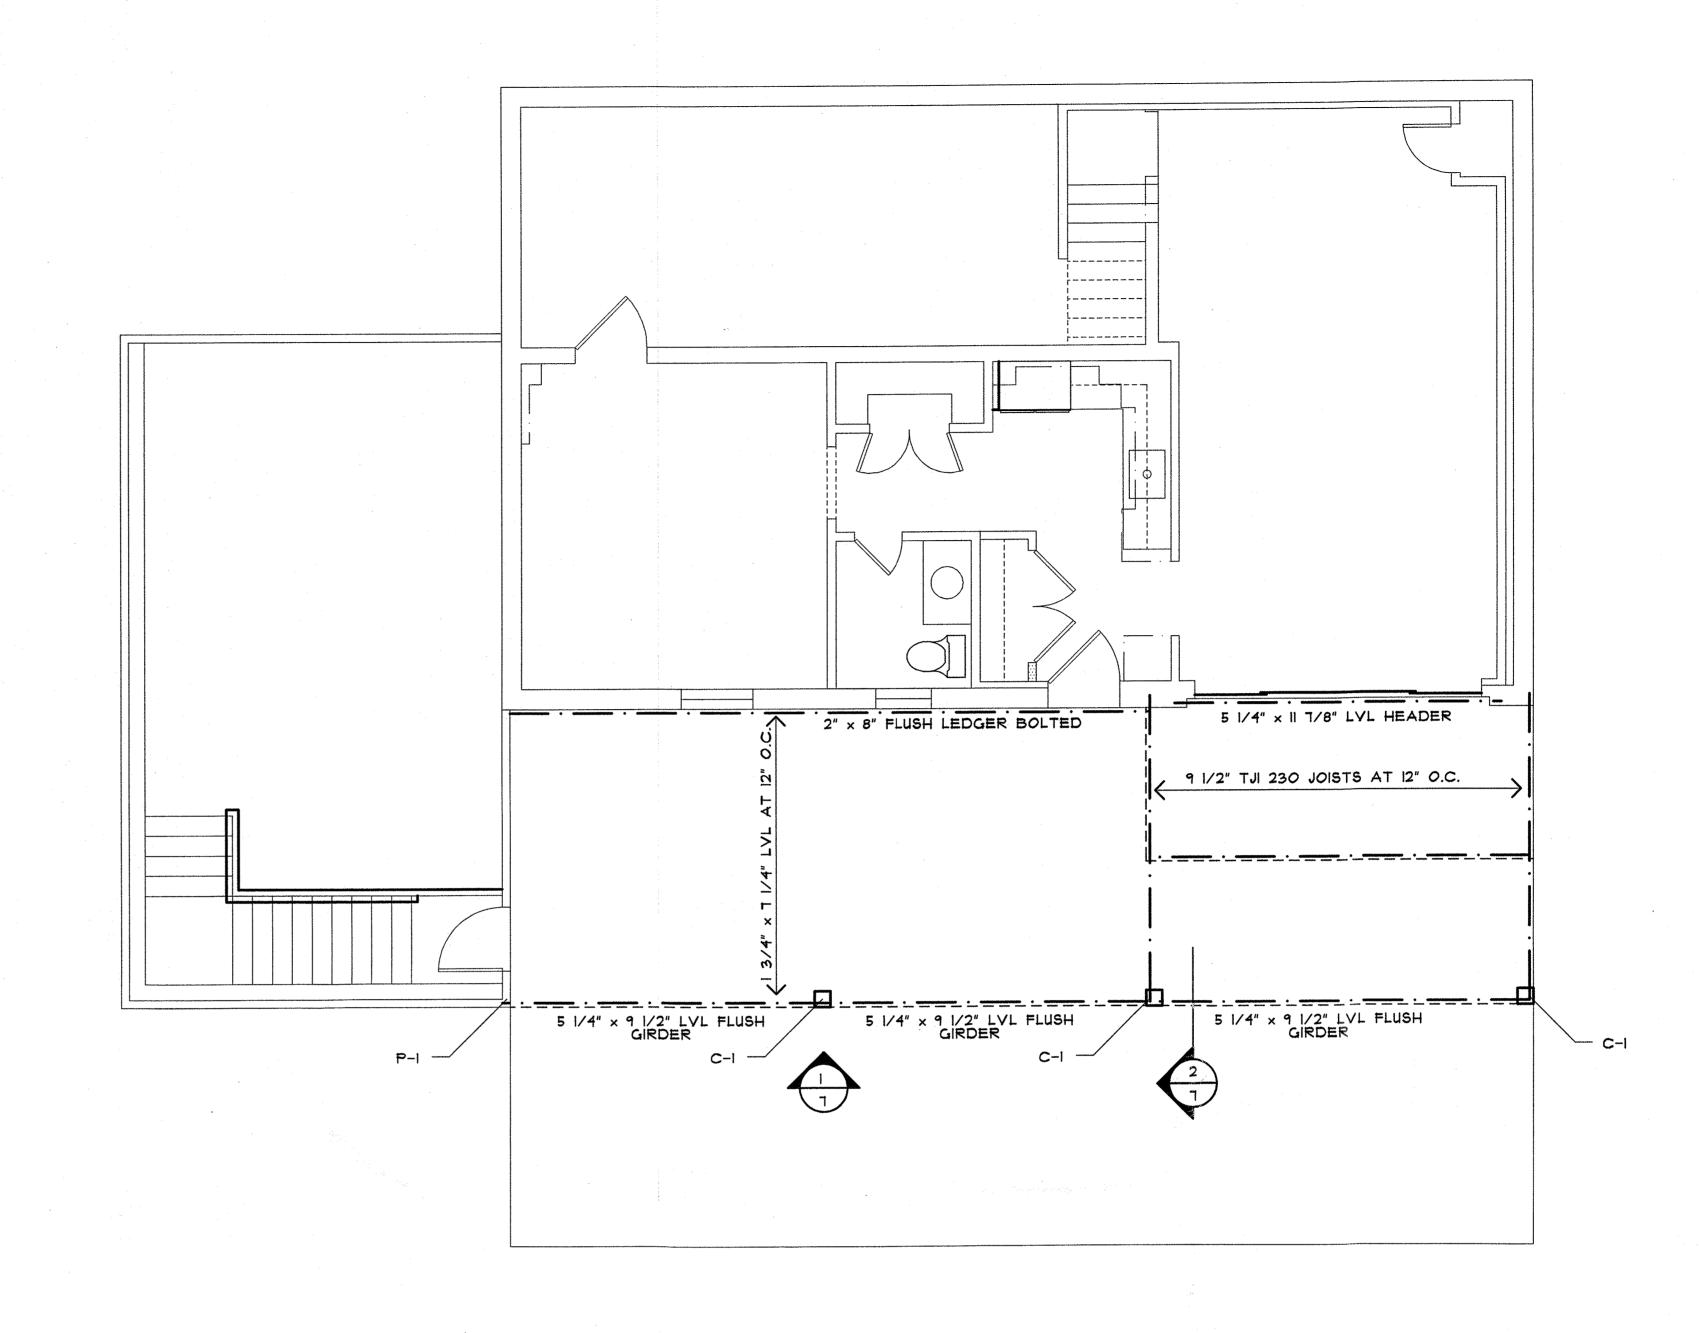
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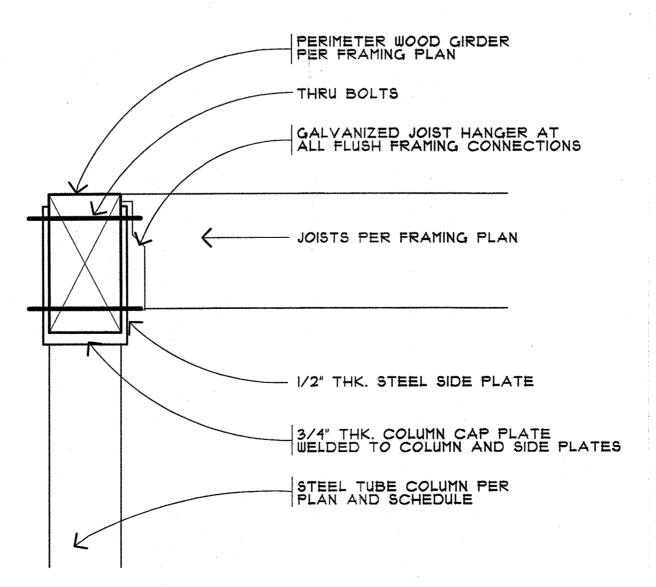
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SECTION THRU PERIMETER GIRDER at COLUMN SCALE: 1 1/2" = 1'-0"

LOWER FIRST FLOOR FRAMING PLAN

SCALE: 1/4" = 1'-0"

COLUMN SCHEDULE

C-I 6" × 6" × 1/2" THK. SQUARE STRUCTURAL TUBE COLUMN.
6" × 8" × 1/2" THK. CAP PLATE. 6" × 12" × 3/4" THK. BASE PLATE.
CONTINUOUS FROM FOUNDATION TO UNDERSIDE OF UPPER TERRACE
FRAMING. 2 COAT EPOXY PAINT OVER PRIMER.

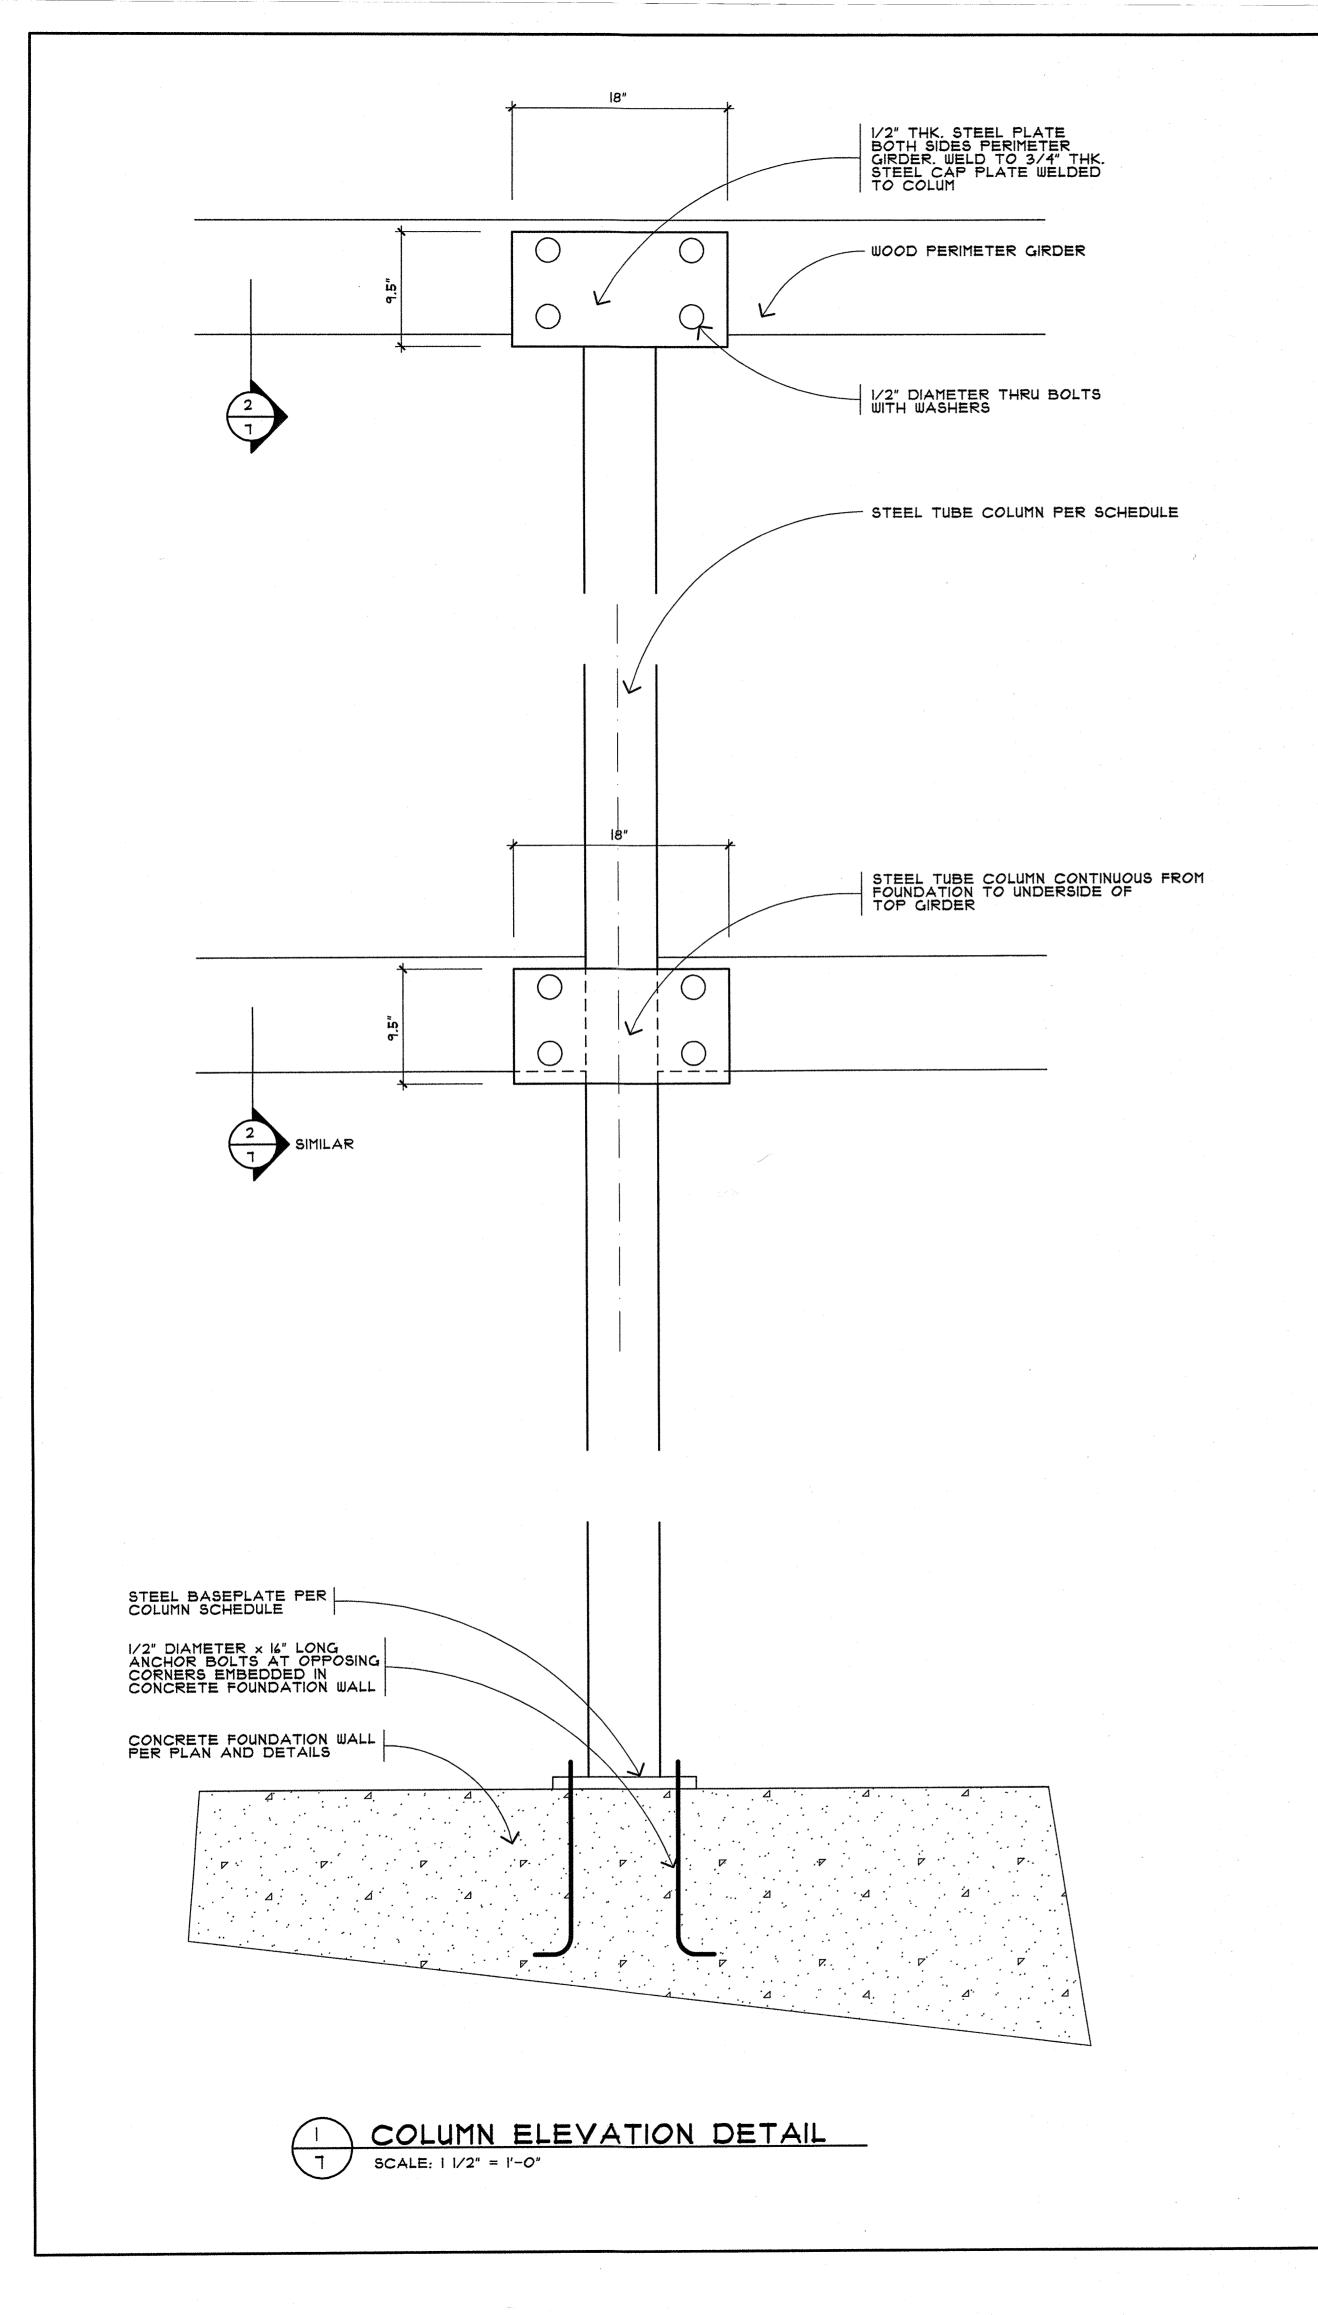POST SCHEDULE

P-I 5 1/4" x 5 1/4" LVL POST

HEADER SCHEDULE

ALL HEADERS SHALL BE AS FOLLOWS UNLESS NOTED OTHERWISE:

(2) 2" × 10" (2" × 4" STUD WALLS.

(3) 2" × 10" (2" × 6" STUD WALLS.

THOND THO

ARCHITECI 29 PASCACK ROAD PARK RIDGE, NEW JERSEY 07656

MAURO RESIDENCE

IOTA ROUTE AW SOUTH


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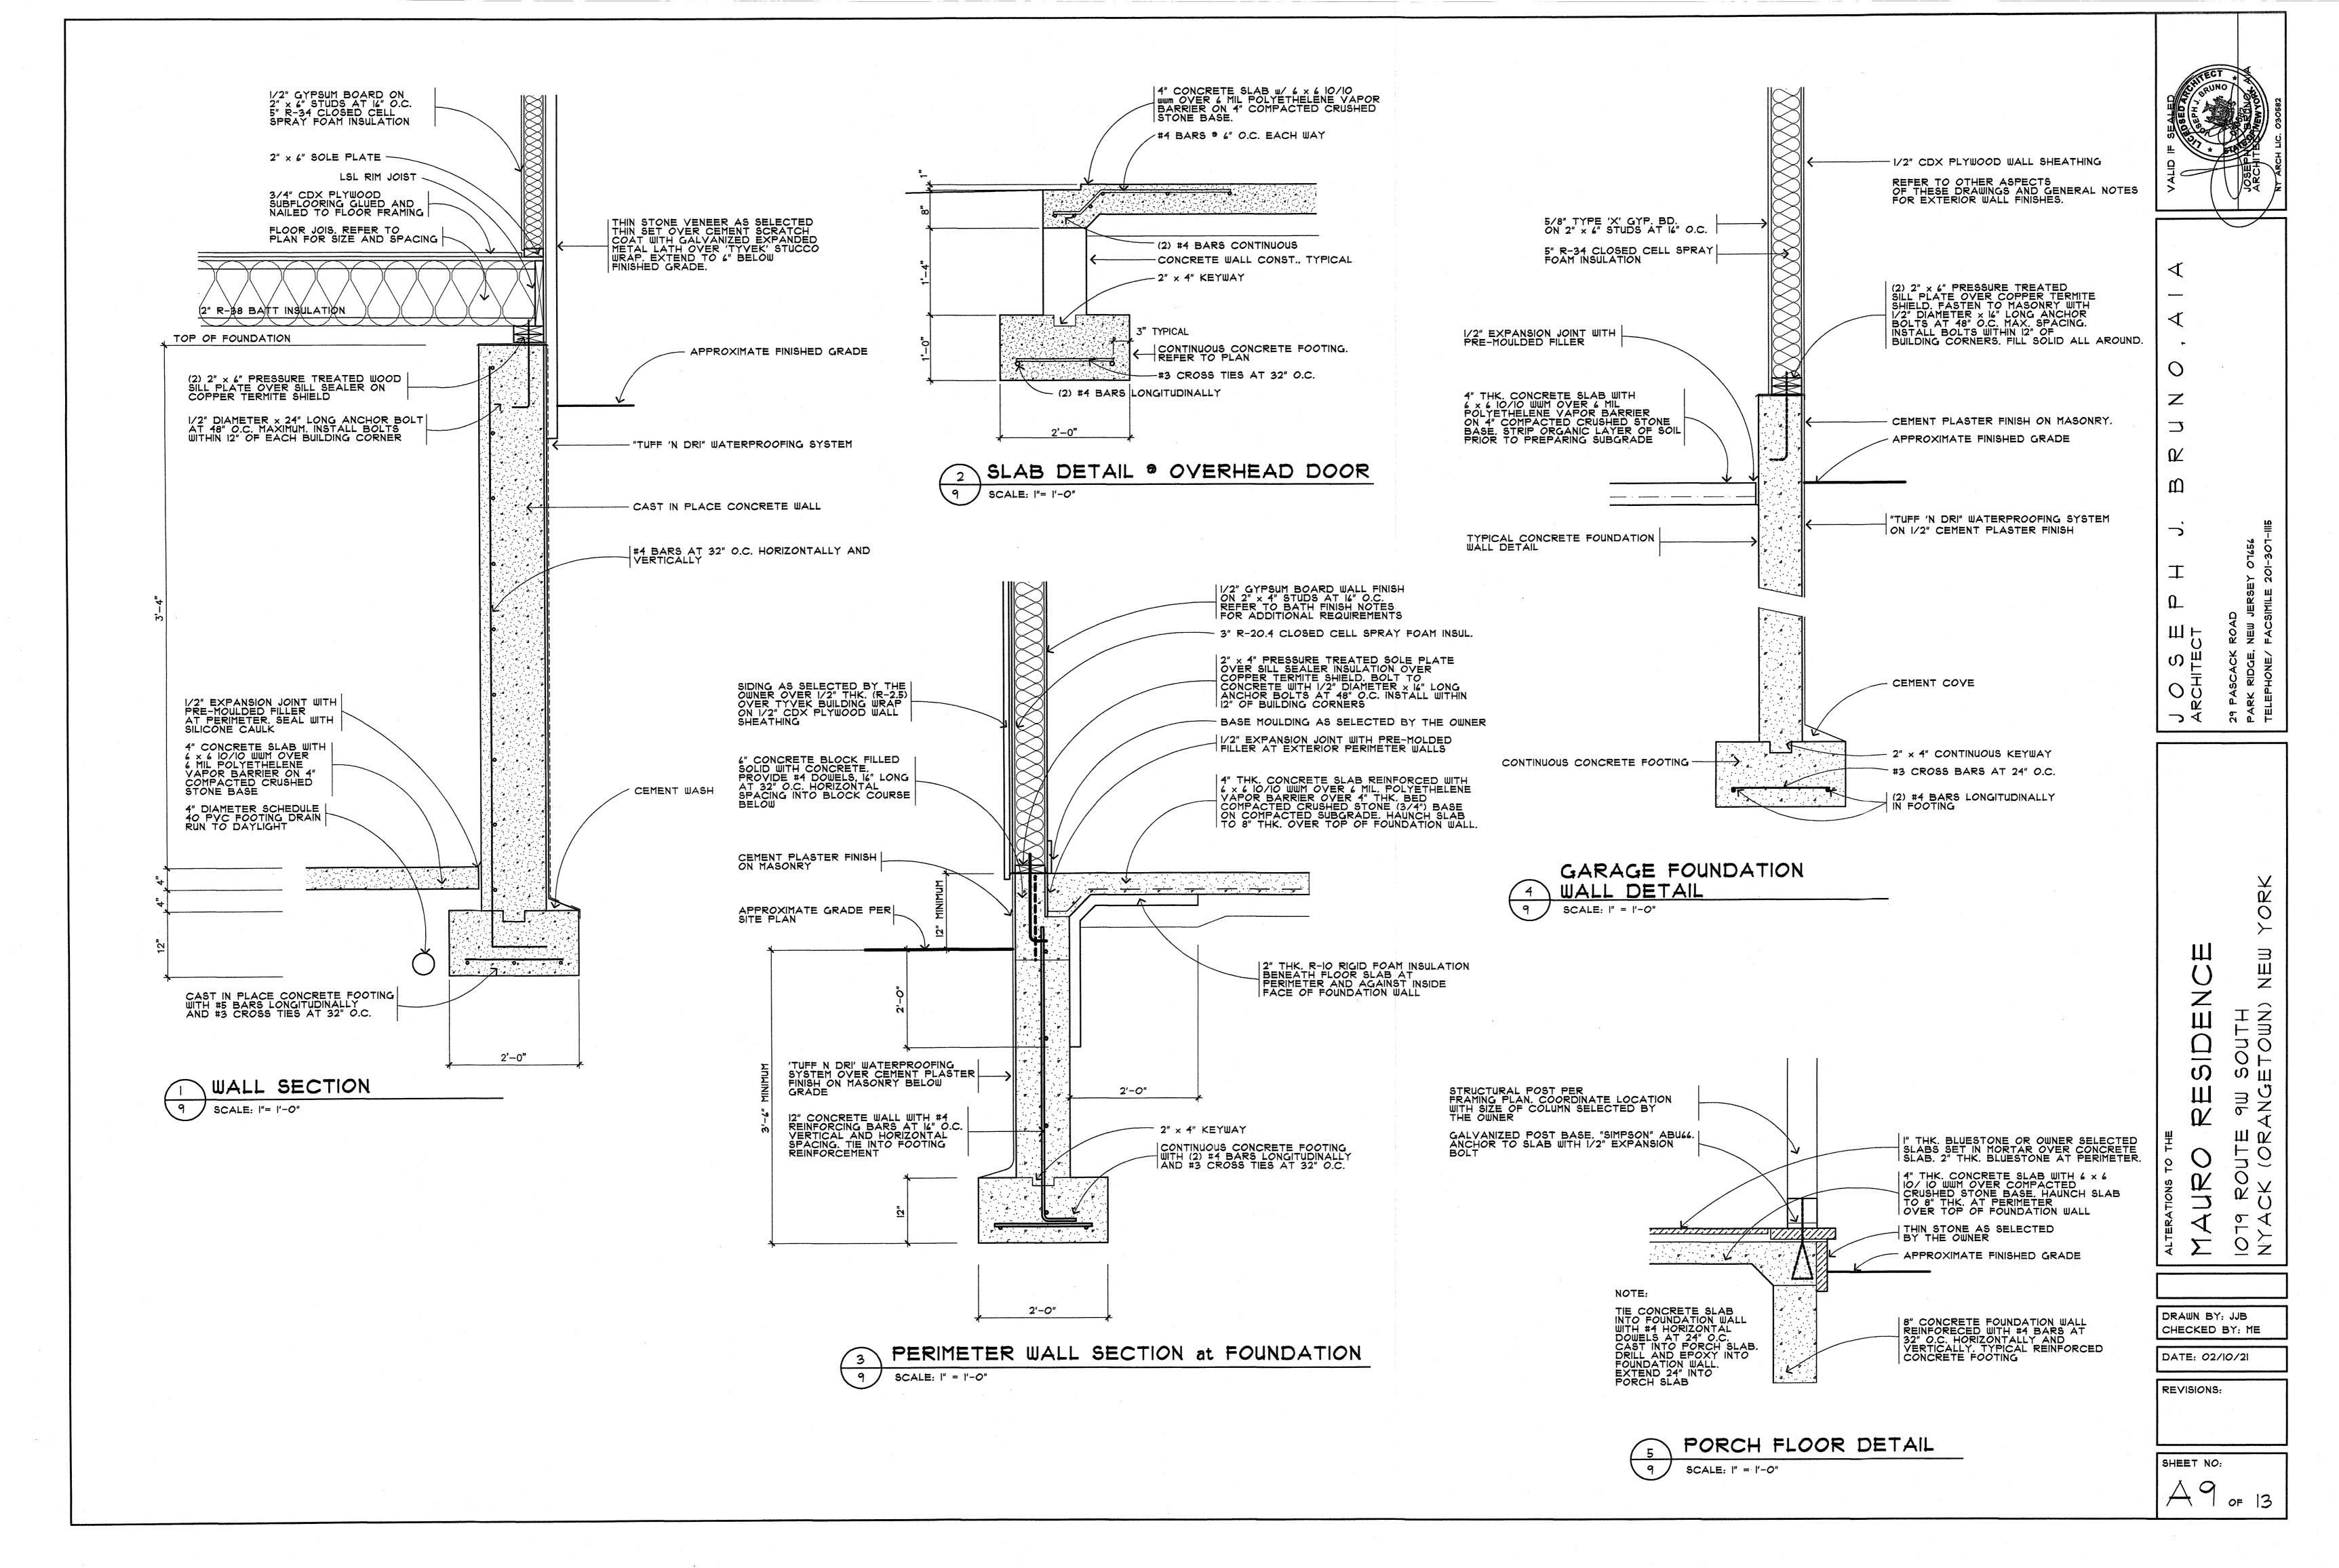
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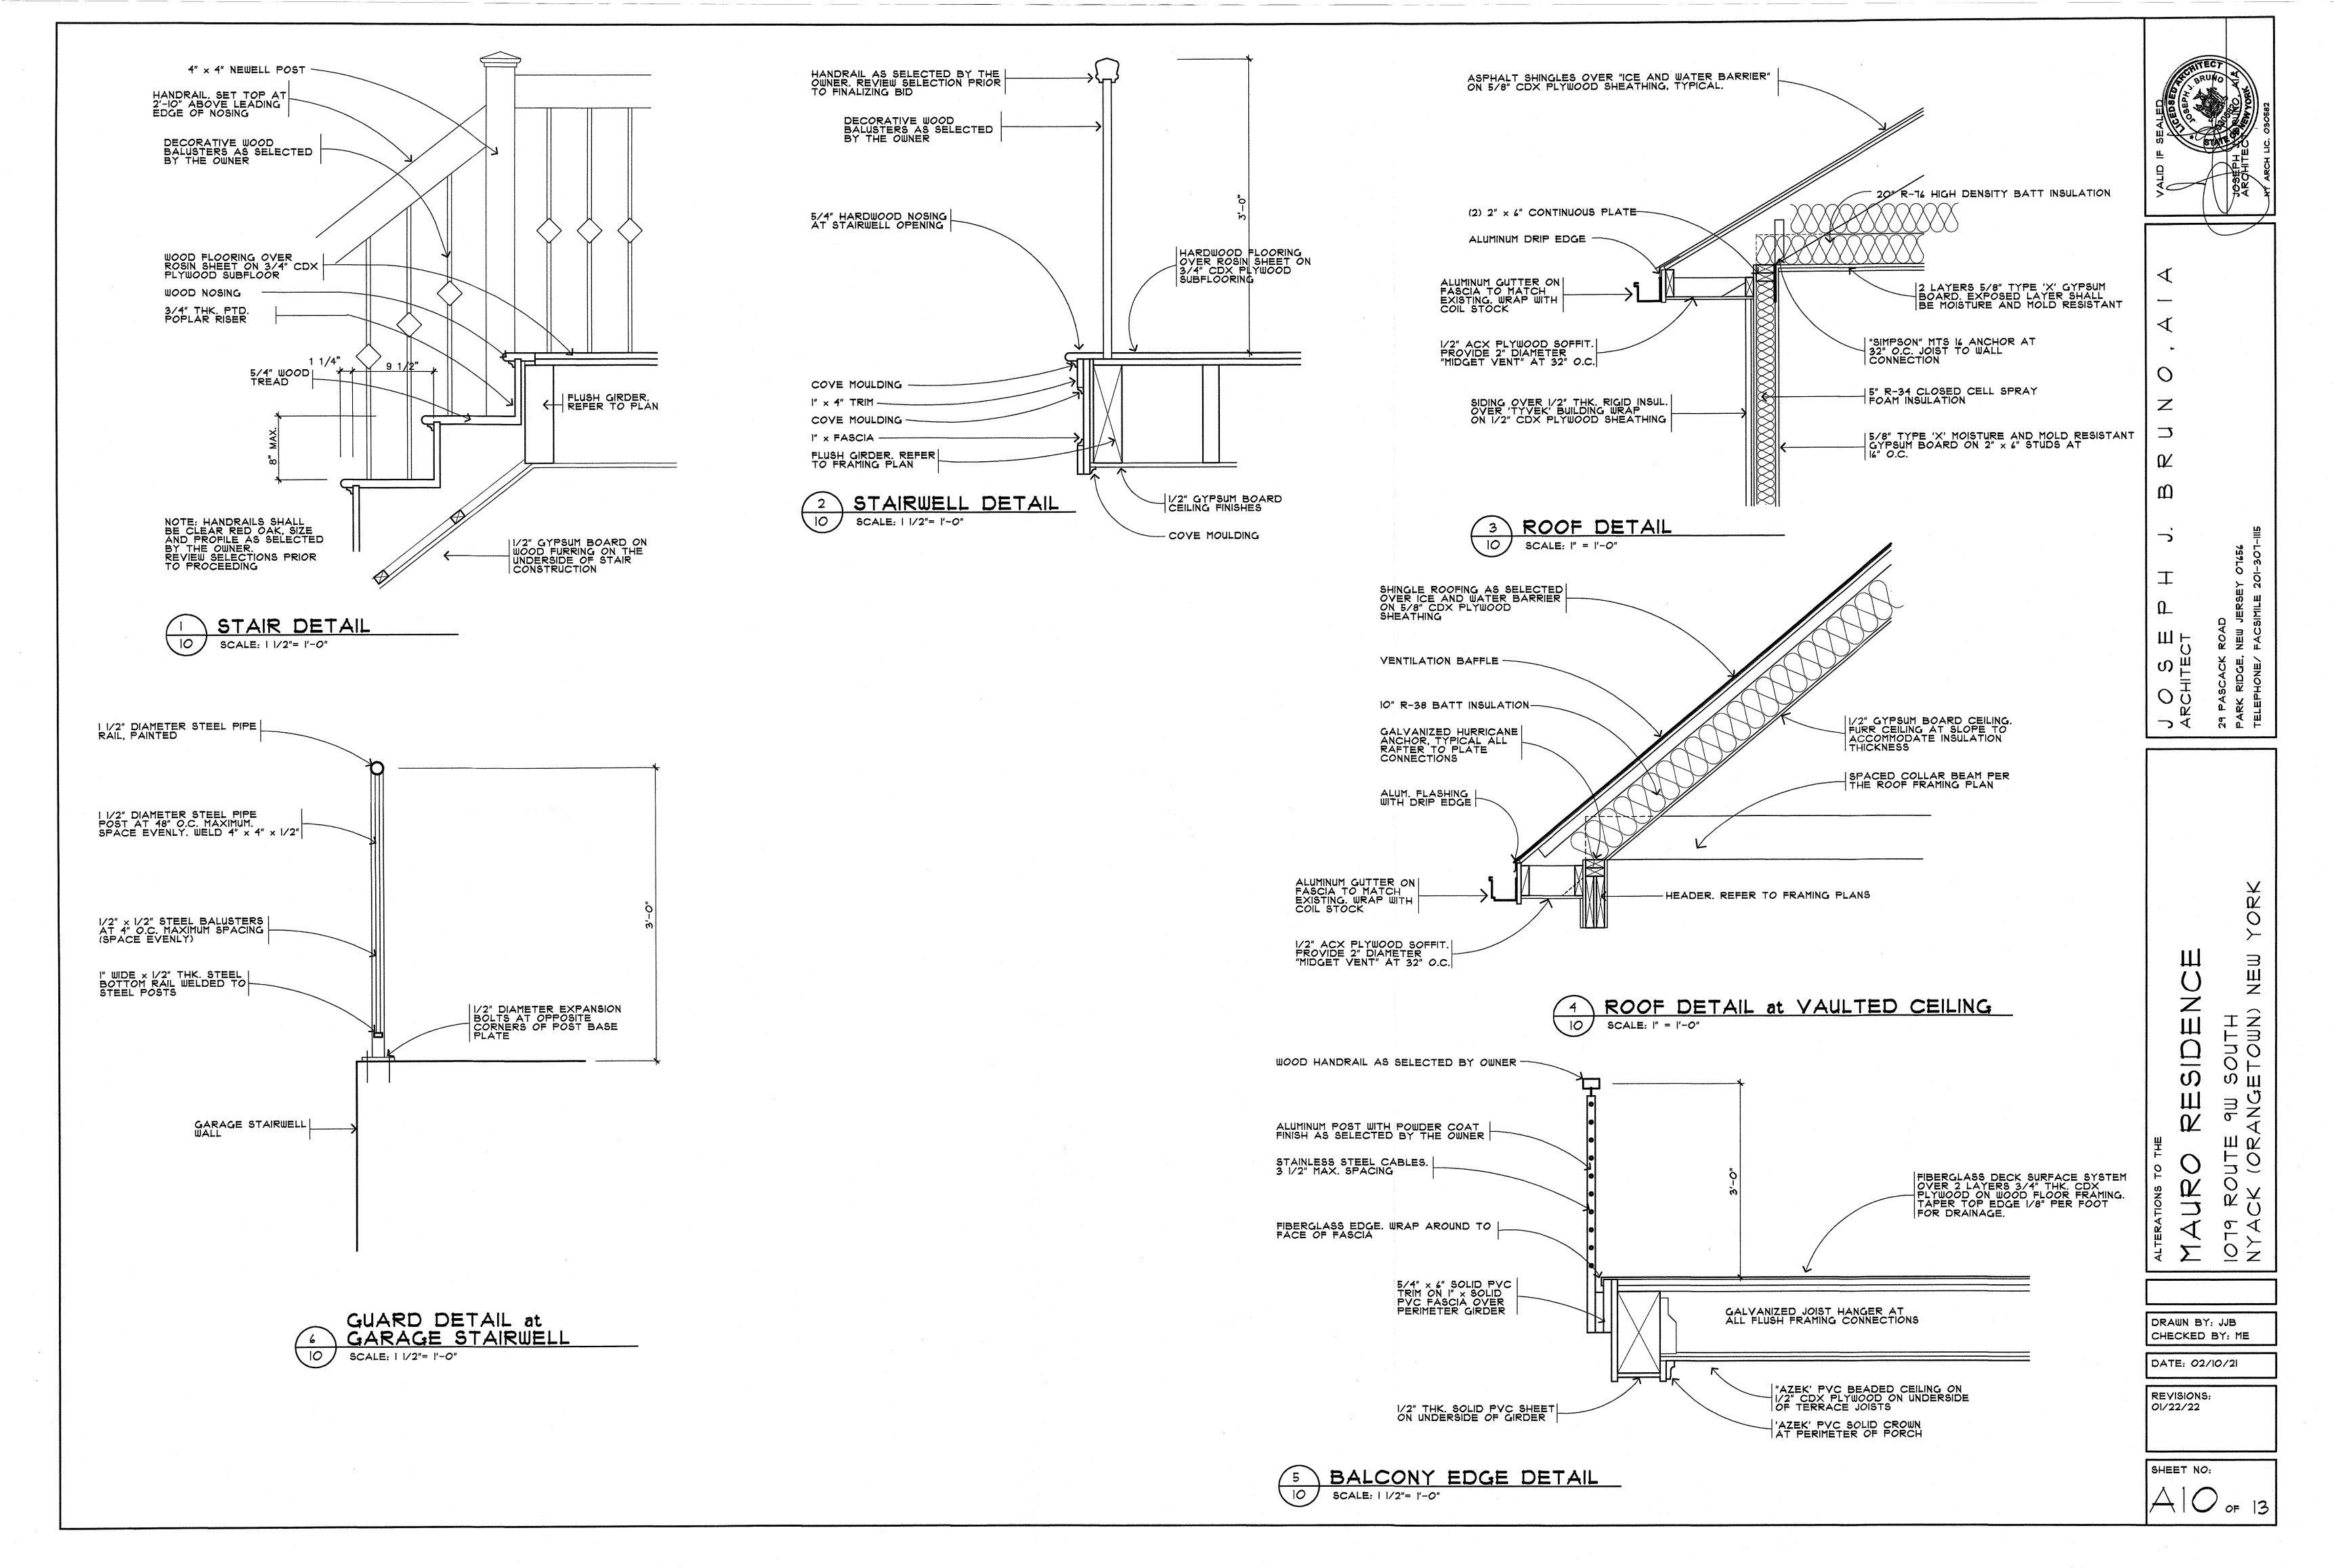
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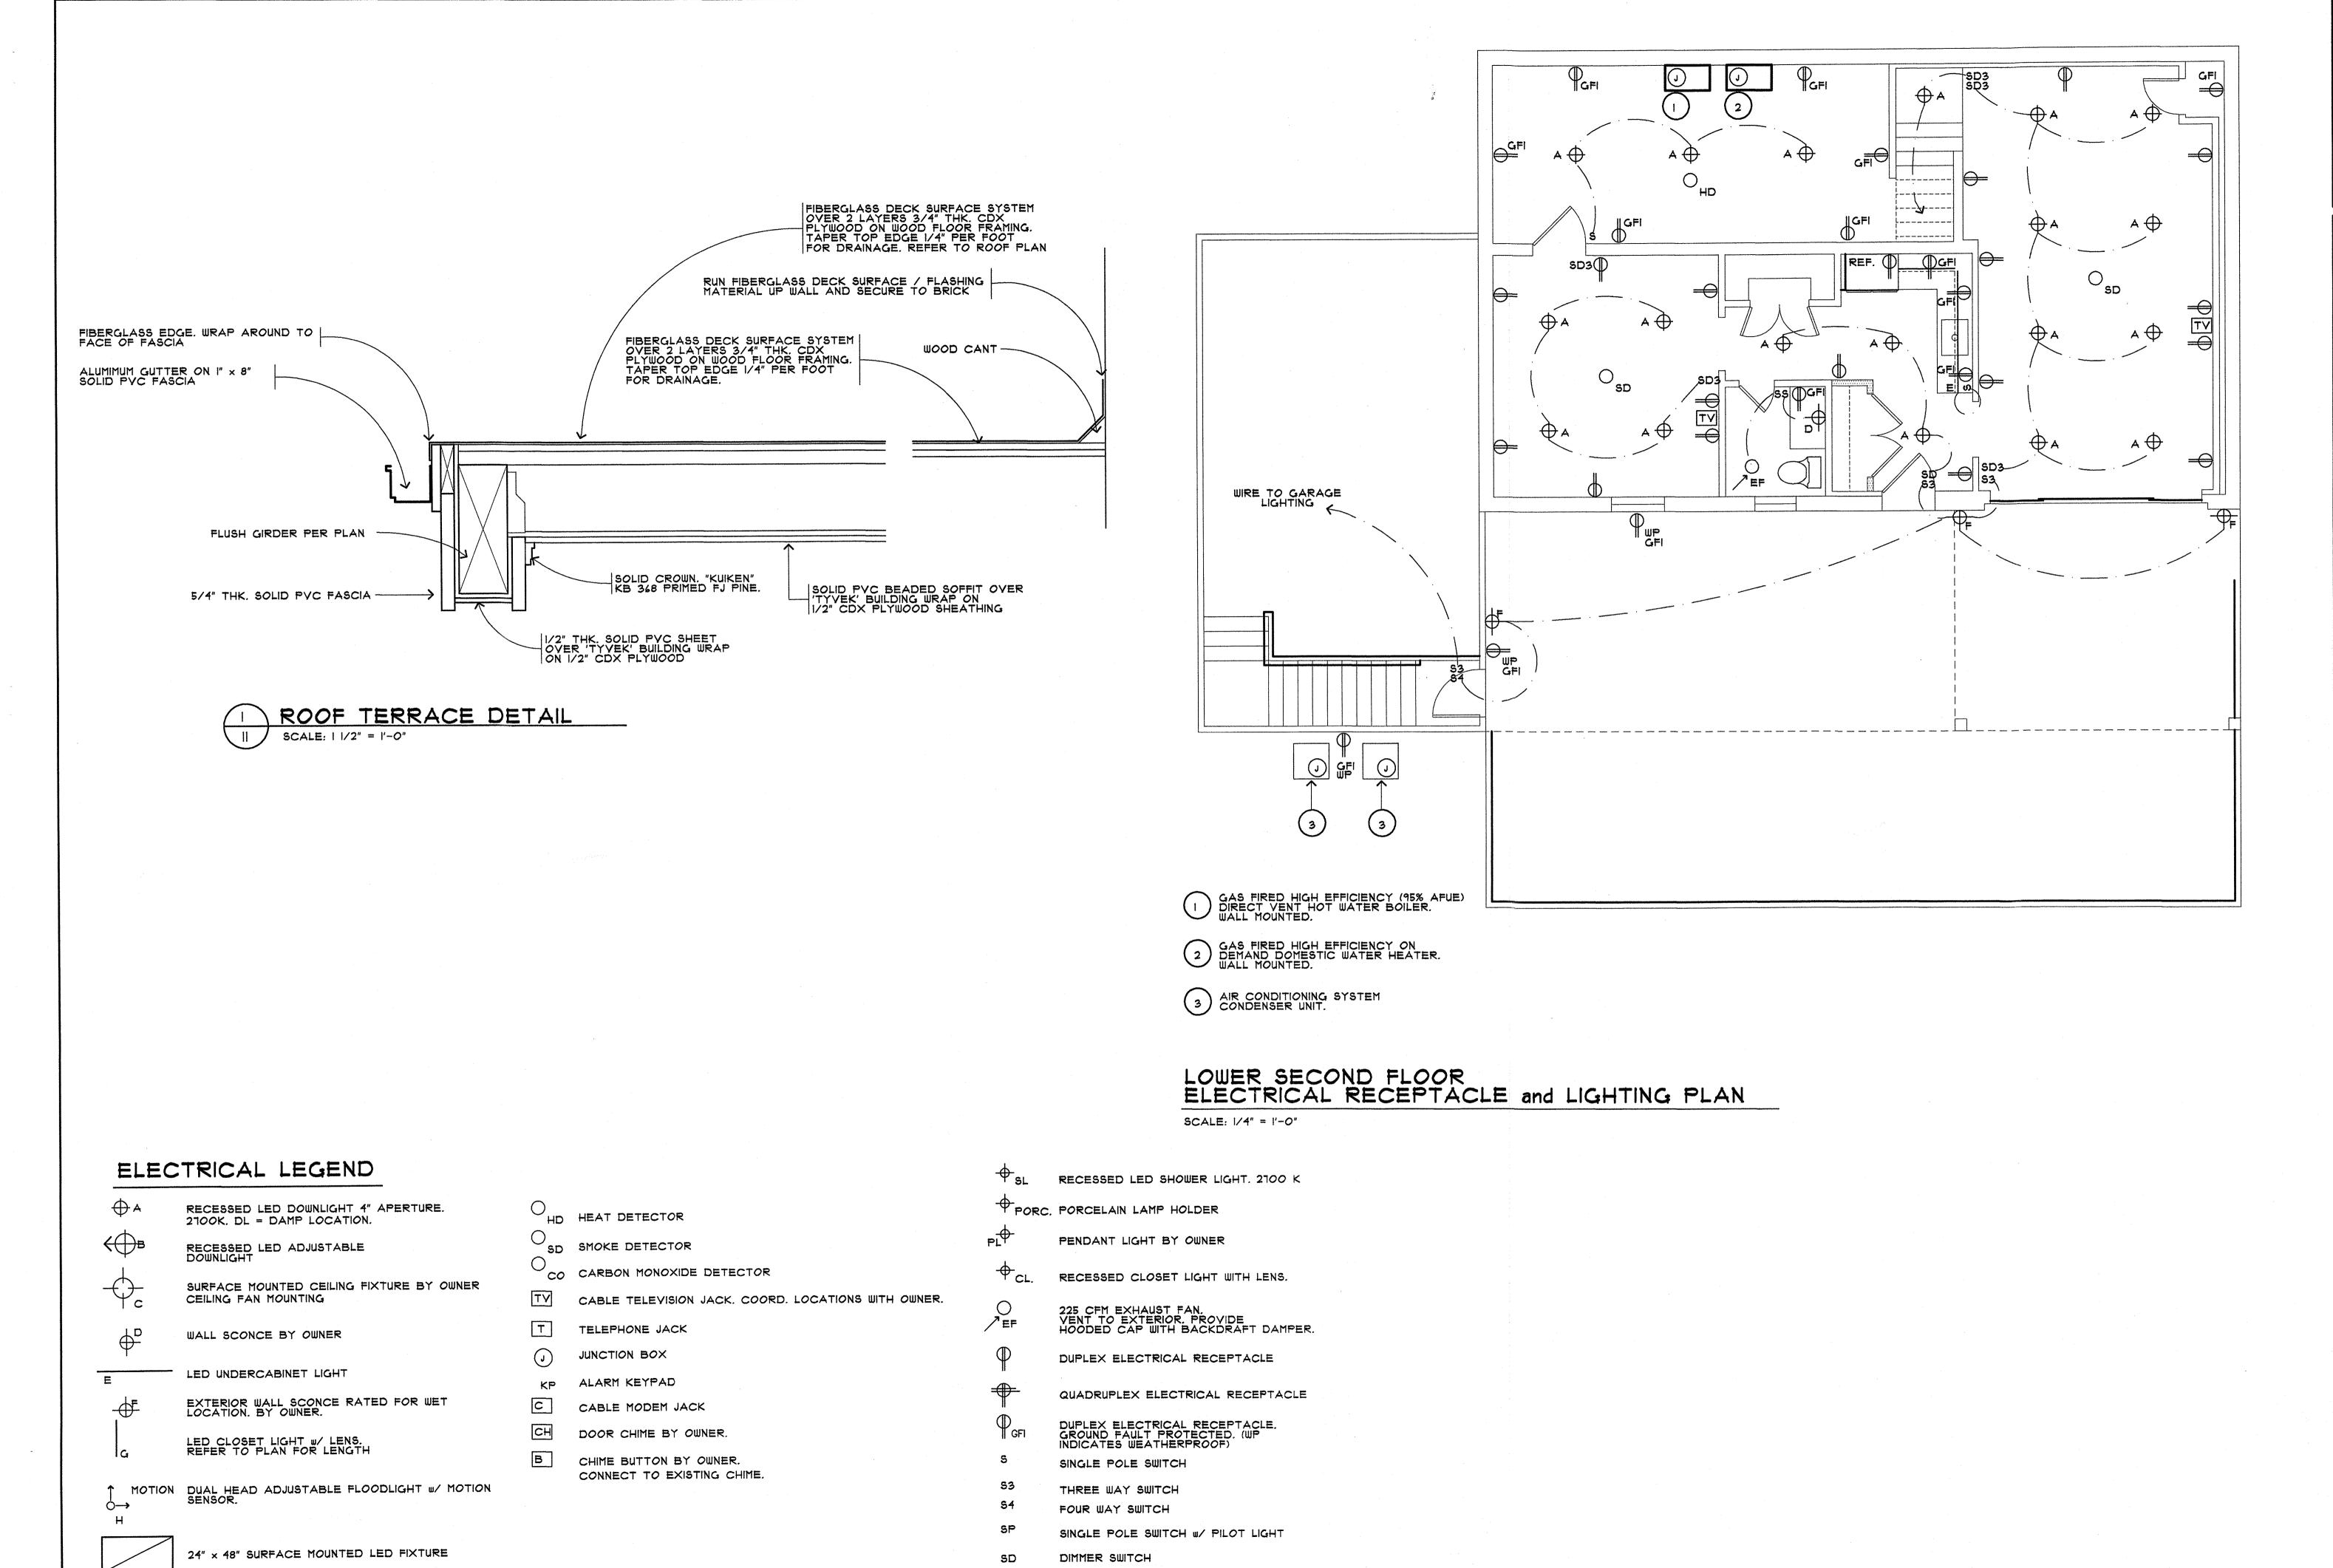
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FAN CONTROL SWITCH

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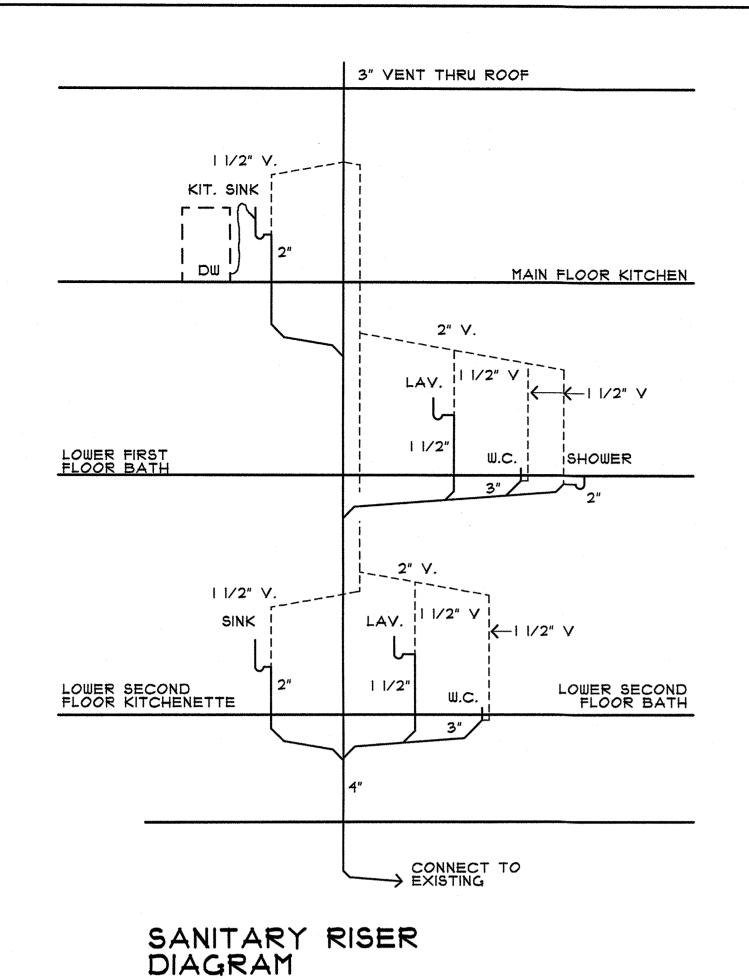
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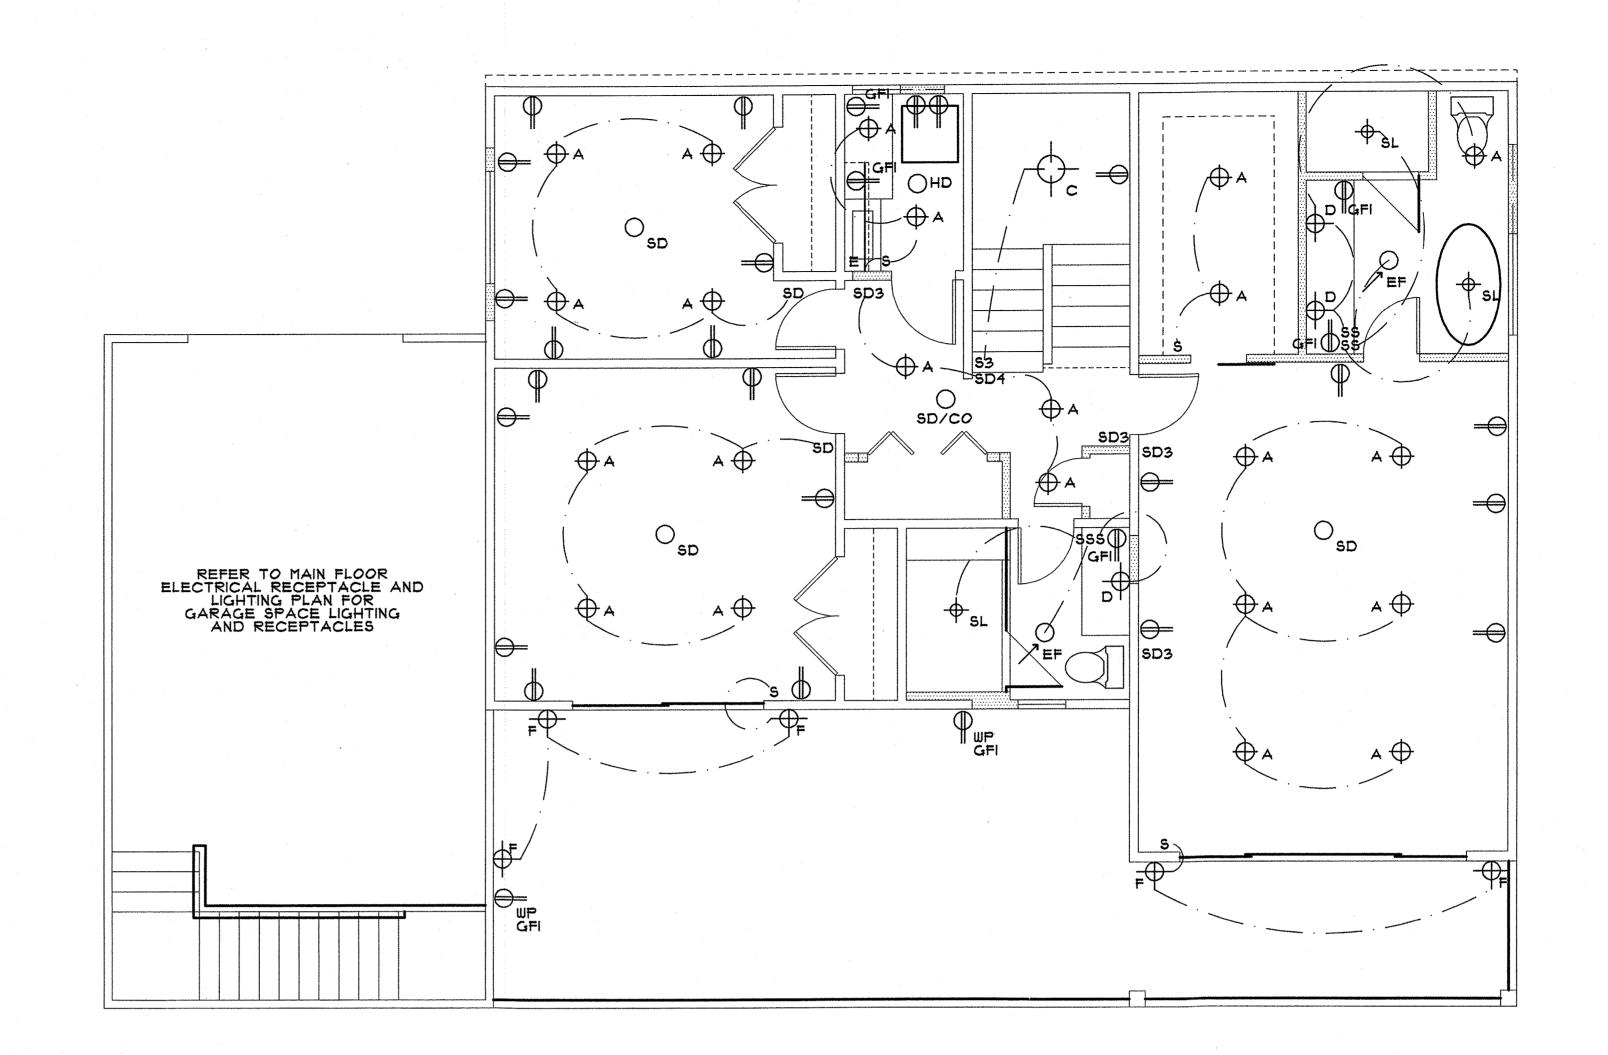
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LOWER FIRST FLOOR ELECTRICAL RECEPTACLE and LIGHTING PLAN SCALE: 1/4" = 1'-0"


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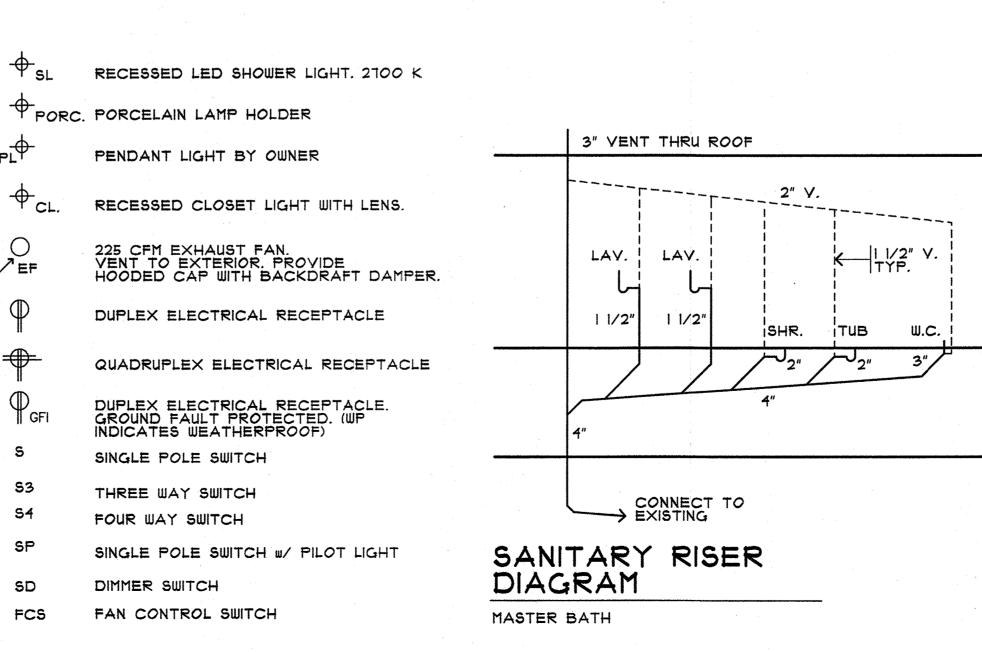
1 1/2"


| 1 1/2" V.

W.C.

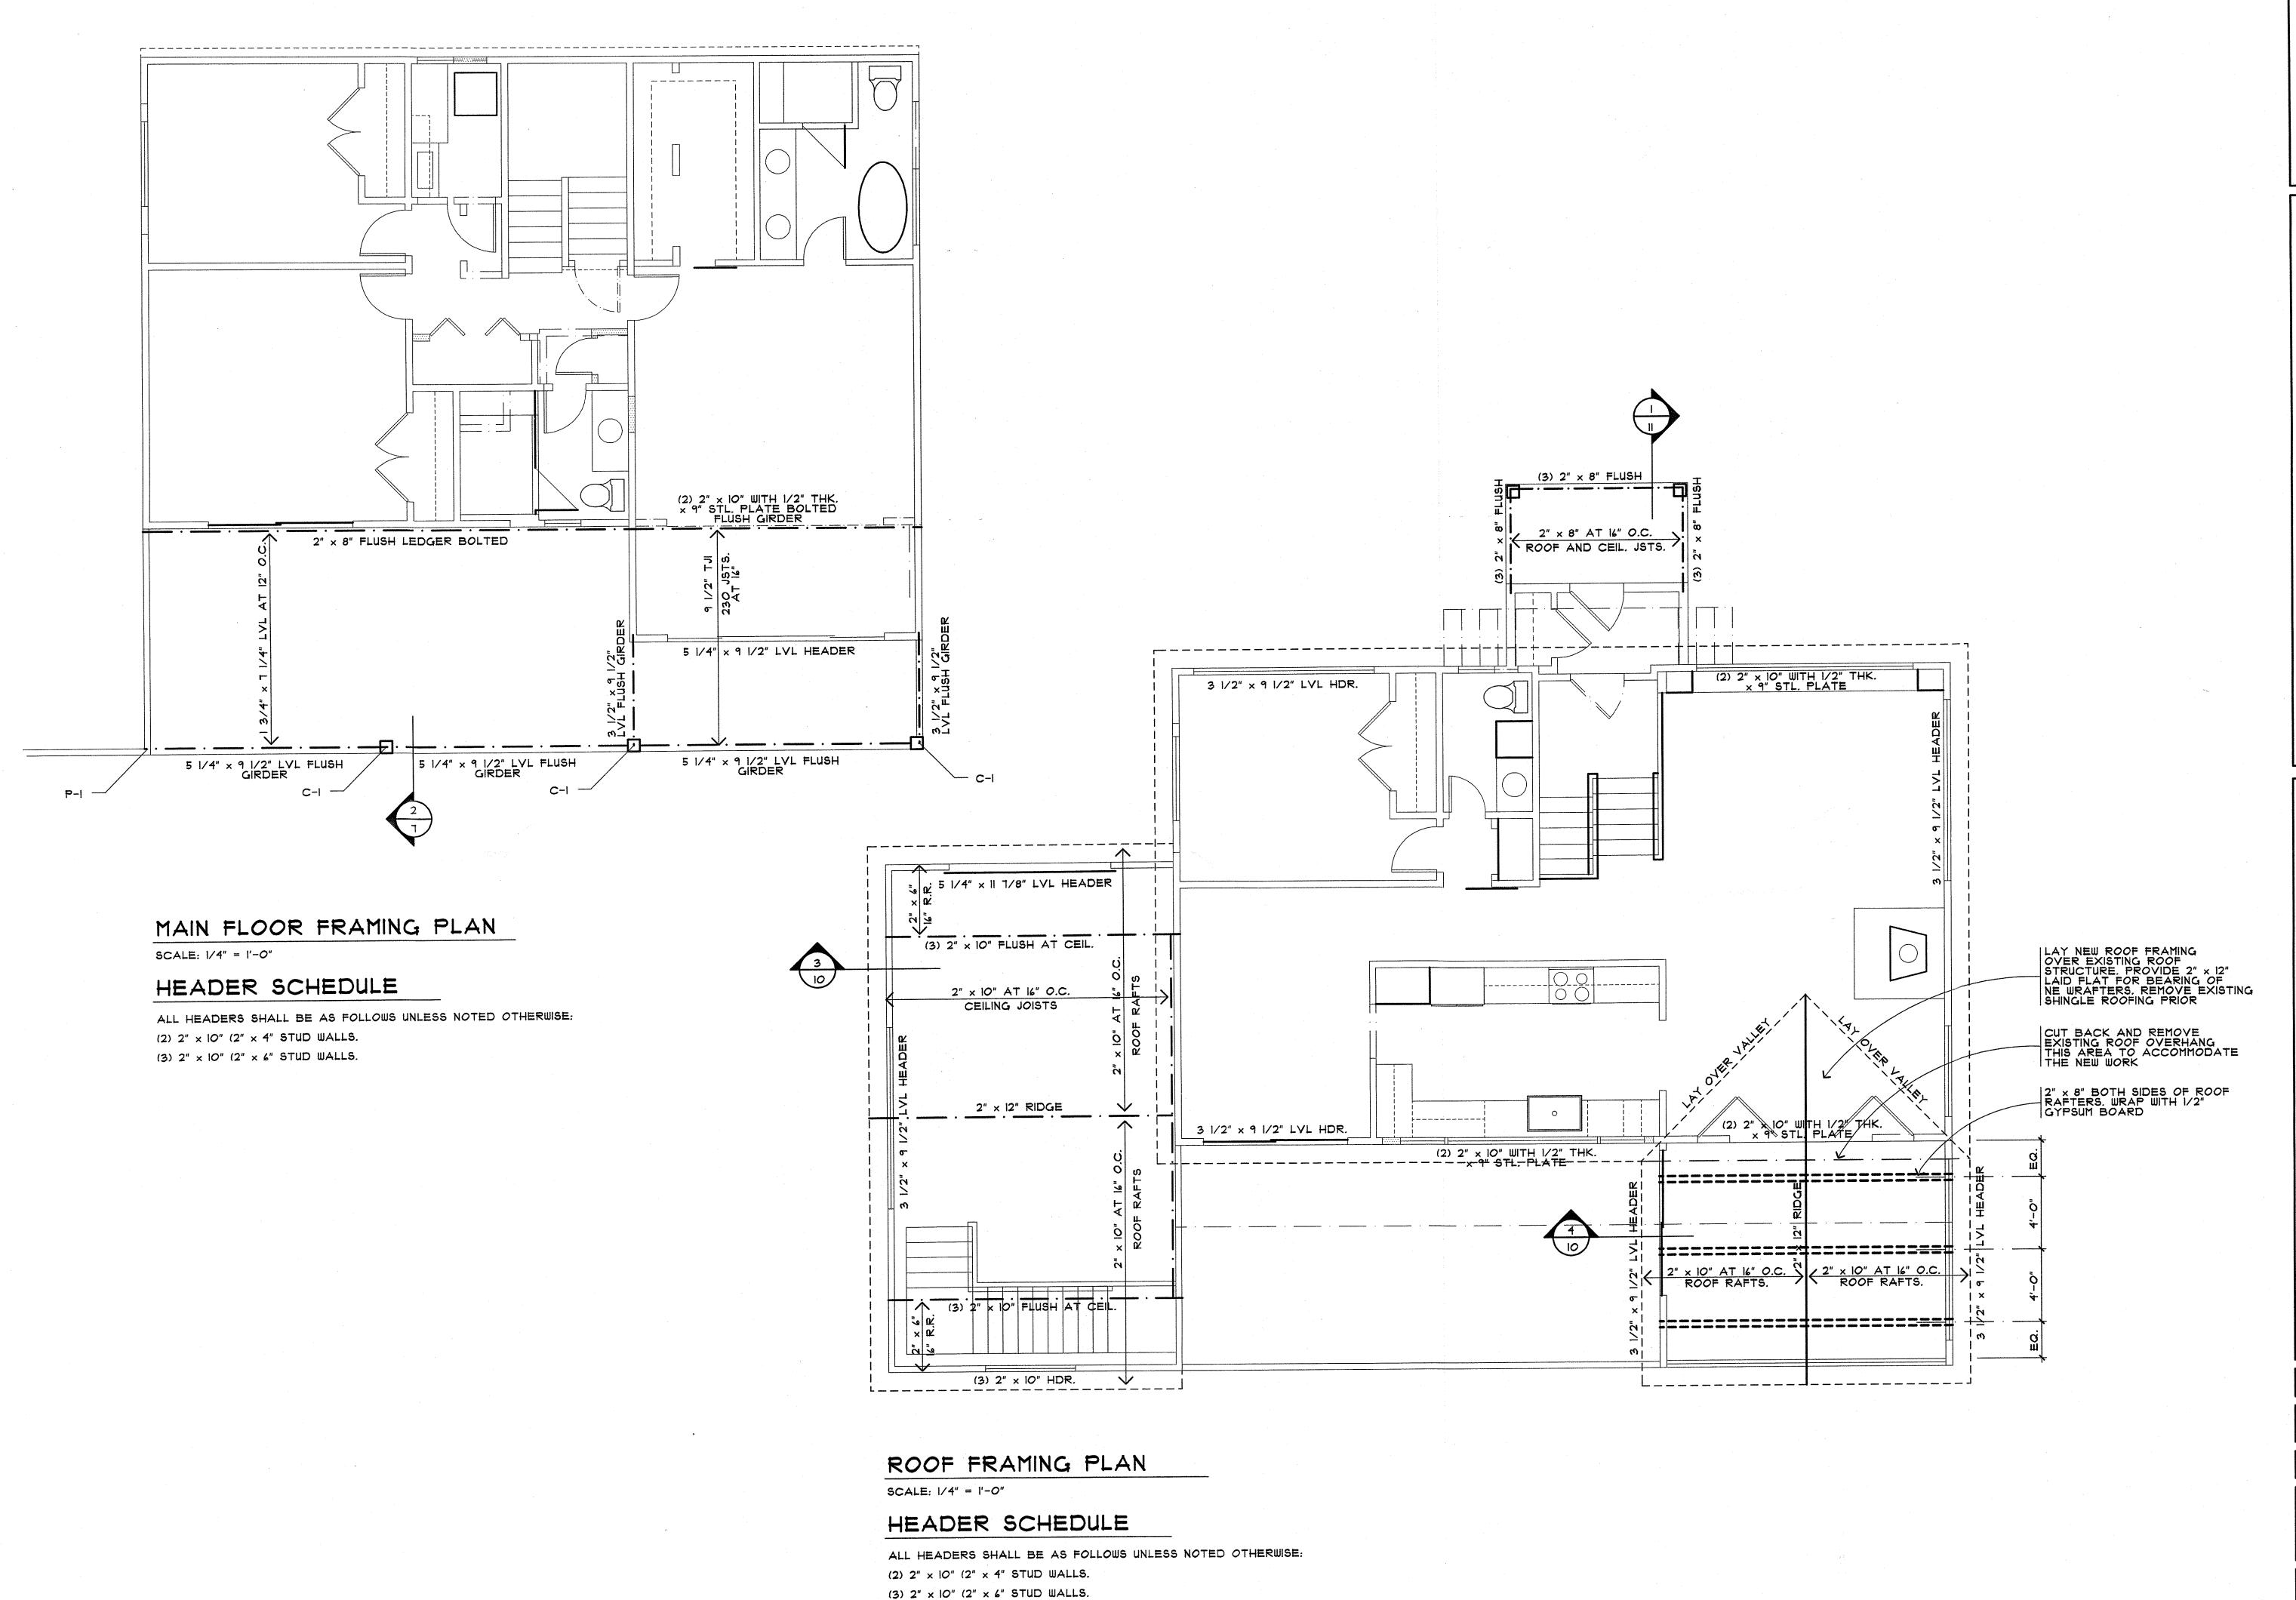TUB



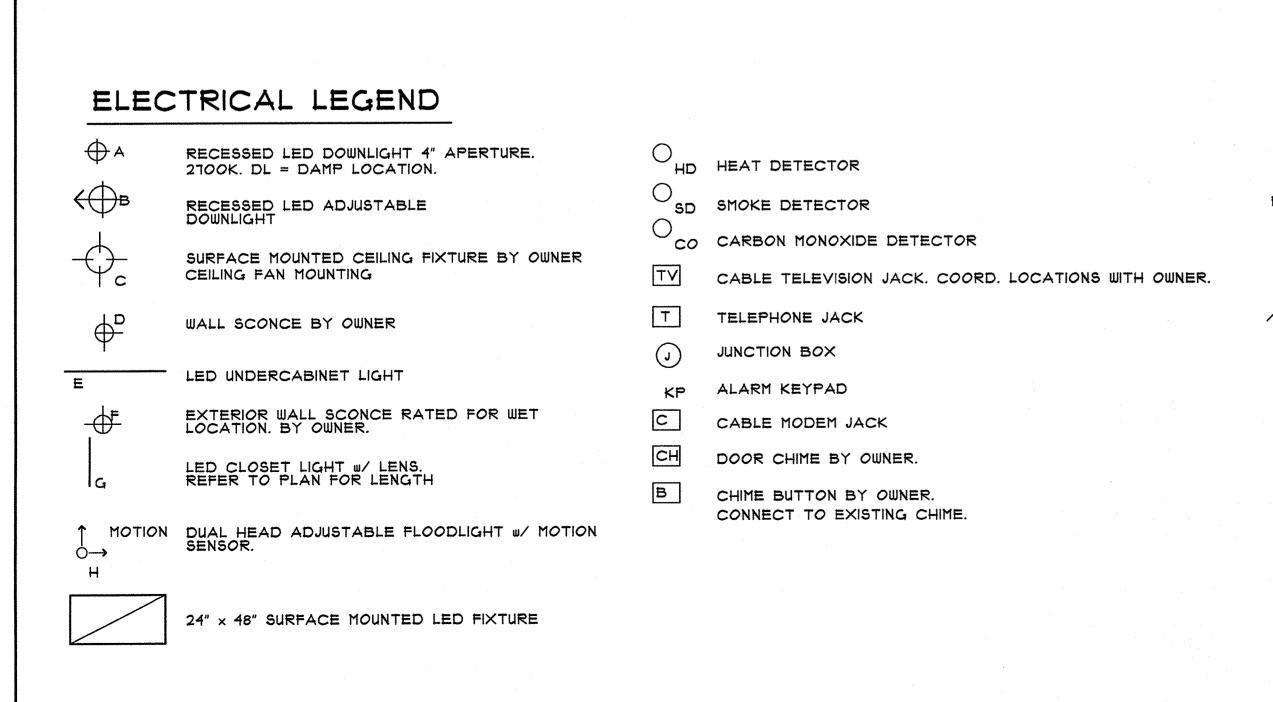

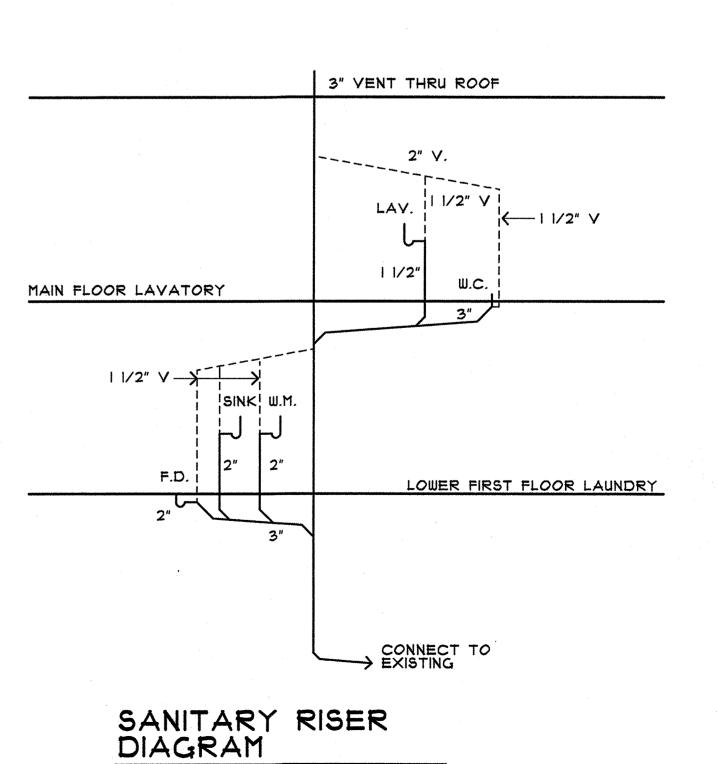


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MAIN FLOOR ELECTRICAL RECEPTACLE and LIGHTING PLAN

SCALE: 1/4" = 1'-0"

YENT KITCHEN EXHAUST TO EXTERIOR. PROVIDE HOODED CAP WITH BACKDRAFT DAMPER. PROVIDE MAKEUP AIR IF FAN EXCEEDS 400 CFM.

2 POWER SUPPLY BELOW COUNTERTOP FOR DISHWASHER.

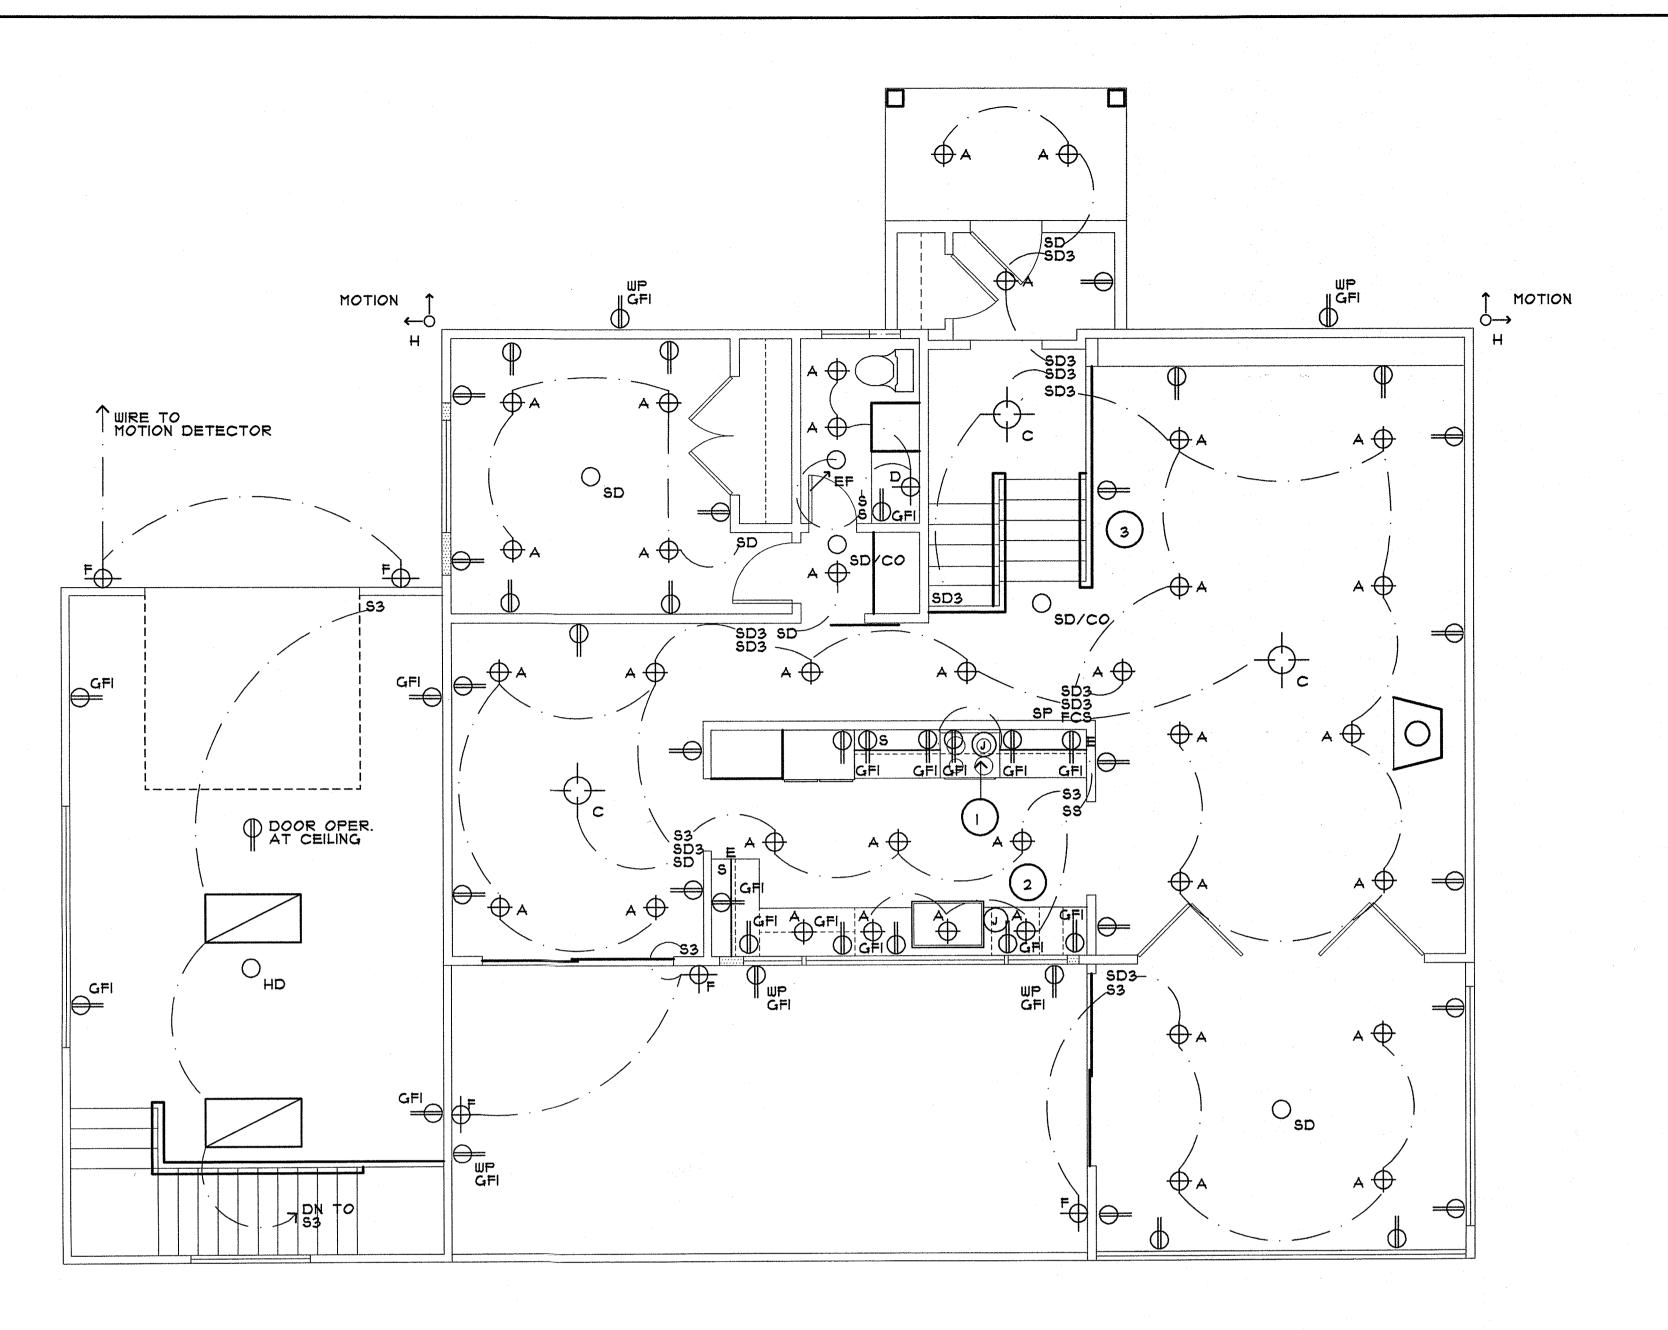3 RECESSED FLOOR RECEPTACLE WITH FLUSH COVER.

ELECTRICAL LEGEND

A RECESSED LED DOWNLIGHT 4" APERTURE. 2100K. DL = DAMP LOCATION.

RECESSED LED ADJUSTABLE

SURFACE MOUNTED CEILING FIXTURE BY OWNER CEILING FAN MOUNTING

WALL SCONCE BY OWNER

EXTERIOR WALL SCONCE RATED FOR WET LOCATION. BY OWNER.

LED CLOSET LIGHT W/ LENS. REFER TO PLAN FOR LENGTH

↑ MOTION DUAL HEAD ADJUSTABLE FLOODLIGHT W/ MOTION SENSOR.

24" x 48" SURFACE MOUNTED LED FIXTURE

HD HEAT DETECTOR

SD SMOKE DETECTOR

CO CARBON MONOXIDE DETECTOR

CABLE TELEVISION JACK. COORD. LOCATIONS WITH OWNER.

T TELEPHONE JACK

J JUNCTION BOX

KP ALARM KEYPAD

C CABLE MODEM JACK

DOOR CHIME BY OWNER.

CHIME BUTTON BY OWNER.
CONNECT TO EXISTING CHIME.

SL RECESSED LED SHOWER LIGHT. 2700 K

PENDANT LIGHT BY OWNER

CL. RECESSED CLOSET LIGHT WITH LENS.

O 225 CFM EXHAUST FAN.

225 CFM EXHAUST FAN.
VENT TO EXTERIOR, PROVIDE
HOODED CAP WITH BACKDRAFT DAMPER.

QUADRUPLEX ELECTRICAL RECEPTACLE

DUPLEX ELECTRICAL RECEPTACLE

DUPLEX ELECTRICAL RECEPTACLE.
GROUND FAULT PROTECTED. (WP
INDICATES WEATHERPROOF)

SINGLE POLE SWITCH

THREE WAY SWITCH

59 FOUR WAY SWITCH
SP SINGLE POLE SWITCH w/ PILOT LIGHT

SD DIMMER SWITCH
FCS FAN CONTROL SWITCH

JOSEPH J. BROWN PECT

JOSEPH J. BRU ARCHITECT

29 PASCACK ROAD PARK RIDGE, NEW JERSEY O

AURO RESIDENCE PROUTE PW SOUTH ACK (ORANGETOWN) NEW YORK

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