
DOMINICAN COLLEGE

ATHLETIC COMPLEX SYNTHETIC TURF FIELD

470 WESTERN HIGHWAY, ORANGEBURG, NY 10962

H2M PROJECT NO. LTGR 2001 August 30, 2021

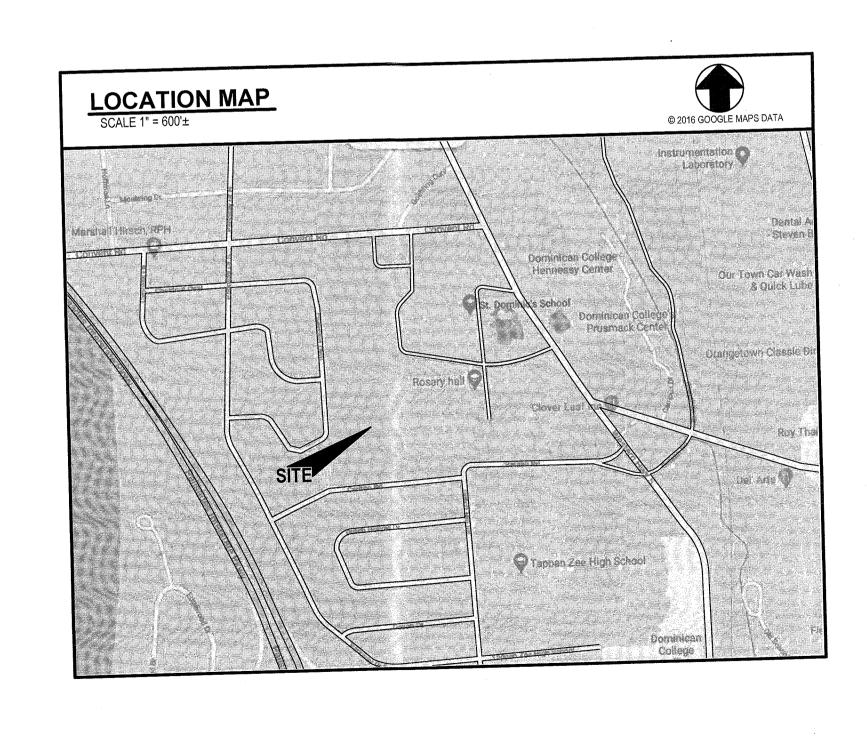






CIVIL DRAWINGS: G0.0 COVER SHEET

- C1.0 EXISTING CONDITIONS AND REMOVALS PLAN
- C1.1 TREE REMOVAL PLAN
 C1.2 TREE REMOVAL LIST
- C2.0 DIMENSIONAL SITE PLAN
- C3.0 GRADING AND DRAINAGE PLAN
- C3.1 CULVERT SECTIONS

C4.0 LANDSCAPE PLAN

- C5.0 EROSION AND SEDIMENT CONTROL PLAN
- C6.0 SITE DETAILS
- C7.0 BLEACHER SITE PLAN, SECTION, AND ELEVATIONS

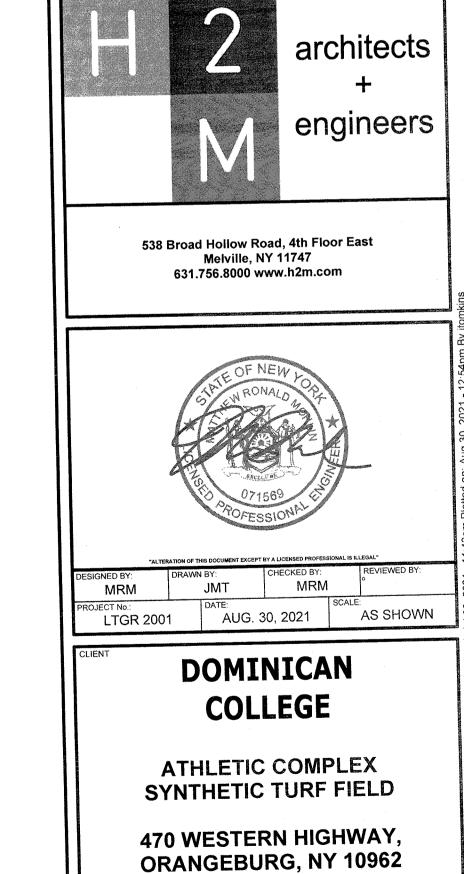

APPLICANT

DOMINICAN COLLEGE

470 WESTERN HIGHWAY

ORANGEBURG, NY 10962

(845) 848-7814

NOT FOR CONSTRUCTION

COLLEGE


DRAWING No.

SHEET N

G0.0

SEC. 7.06, BLOCK 3, P/O LOTS 1.1 & 1.3

SHEET No.

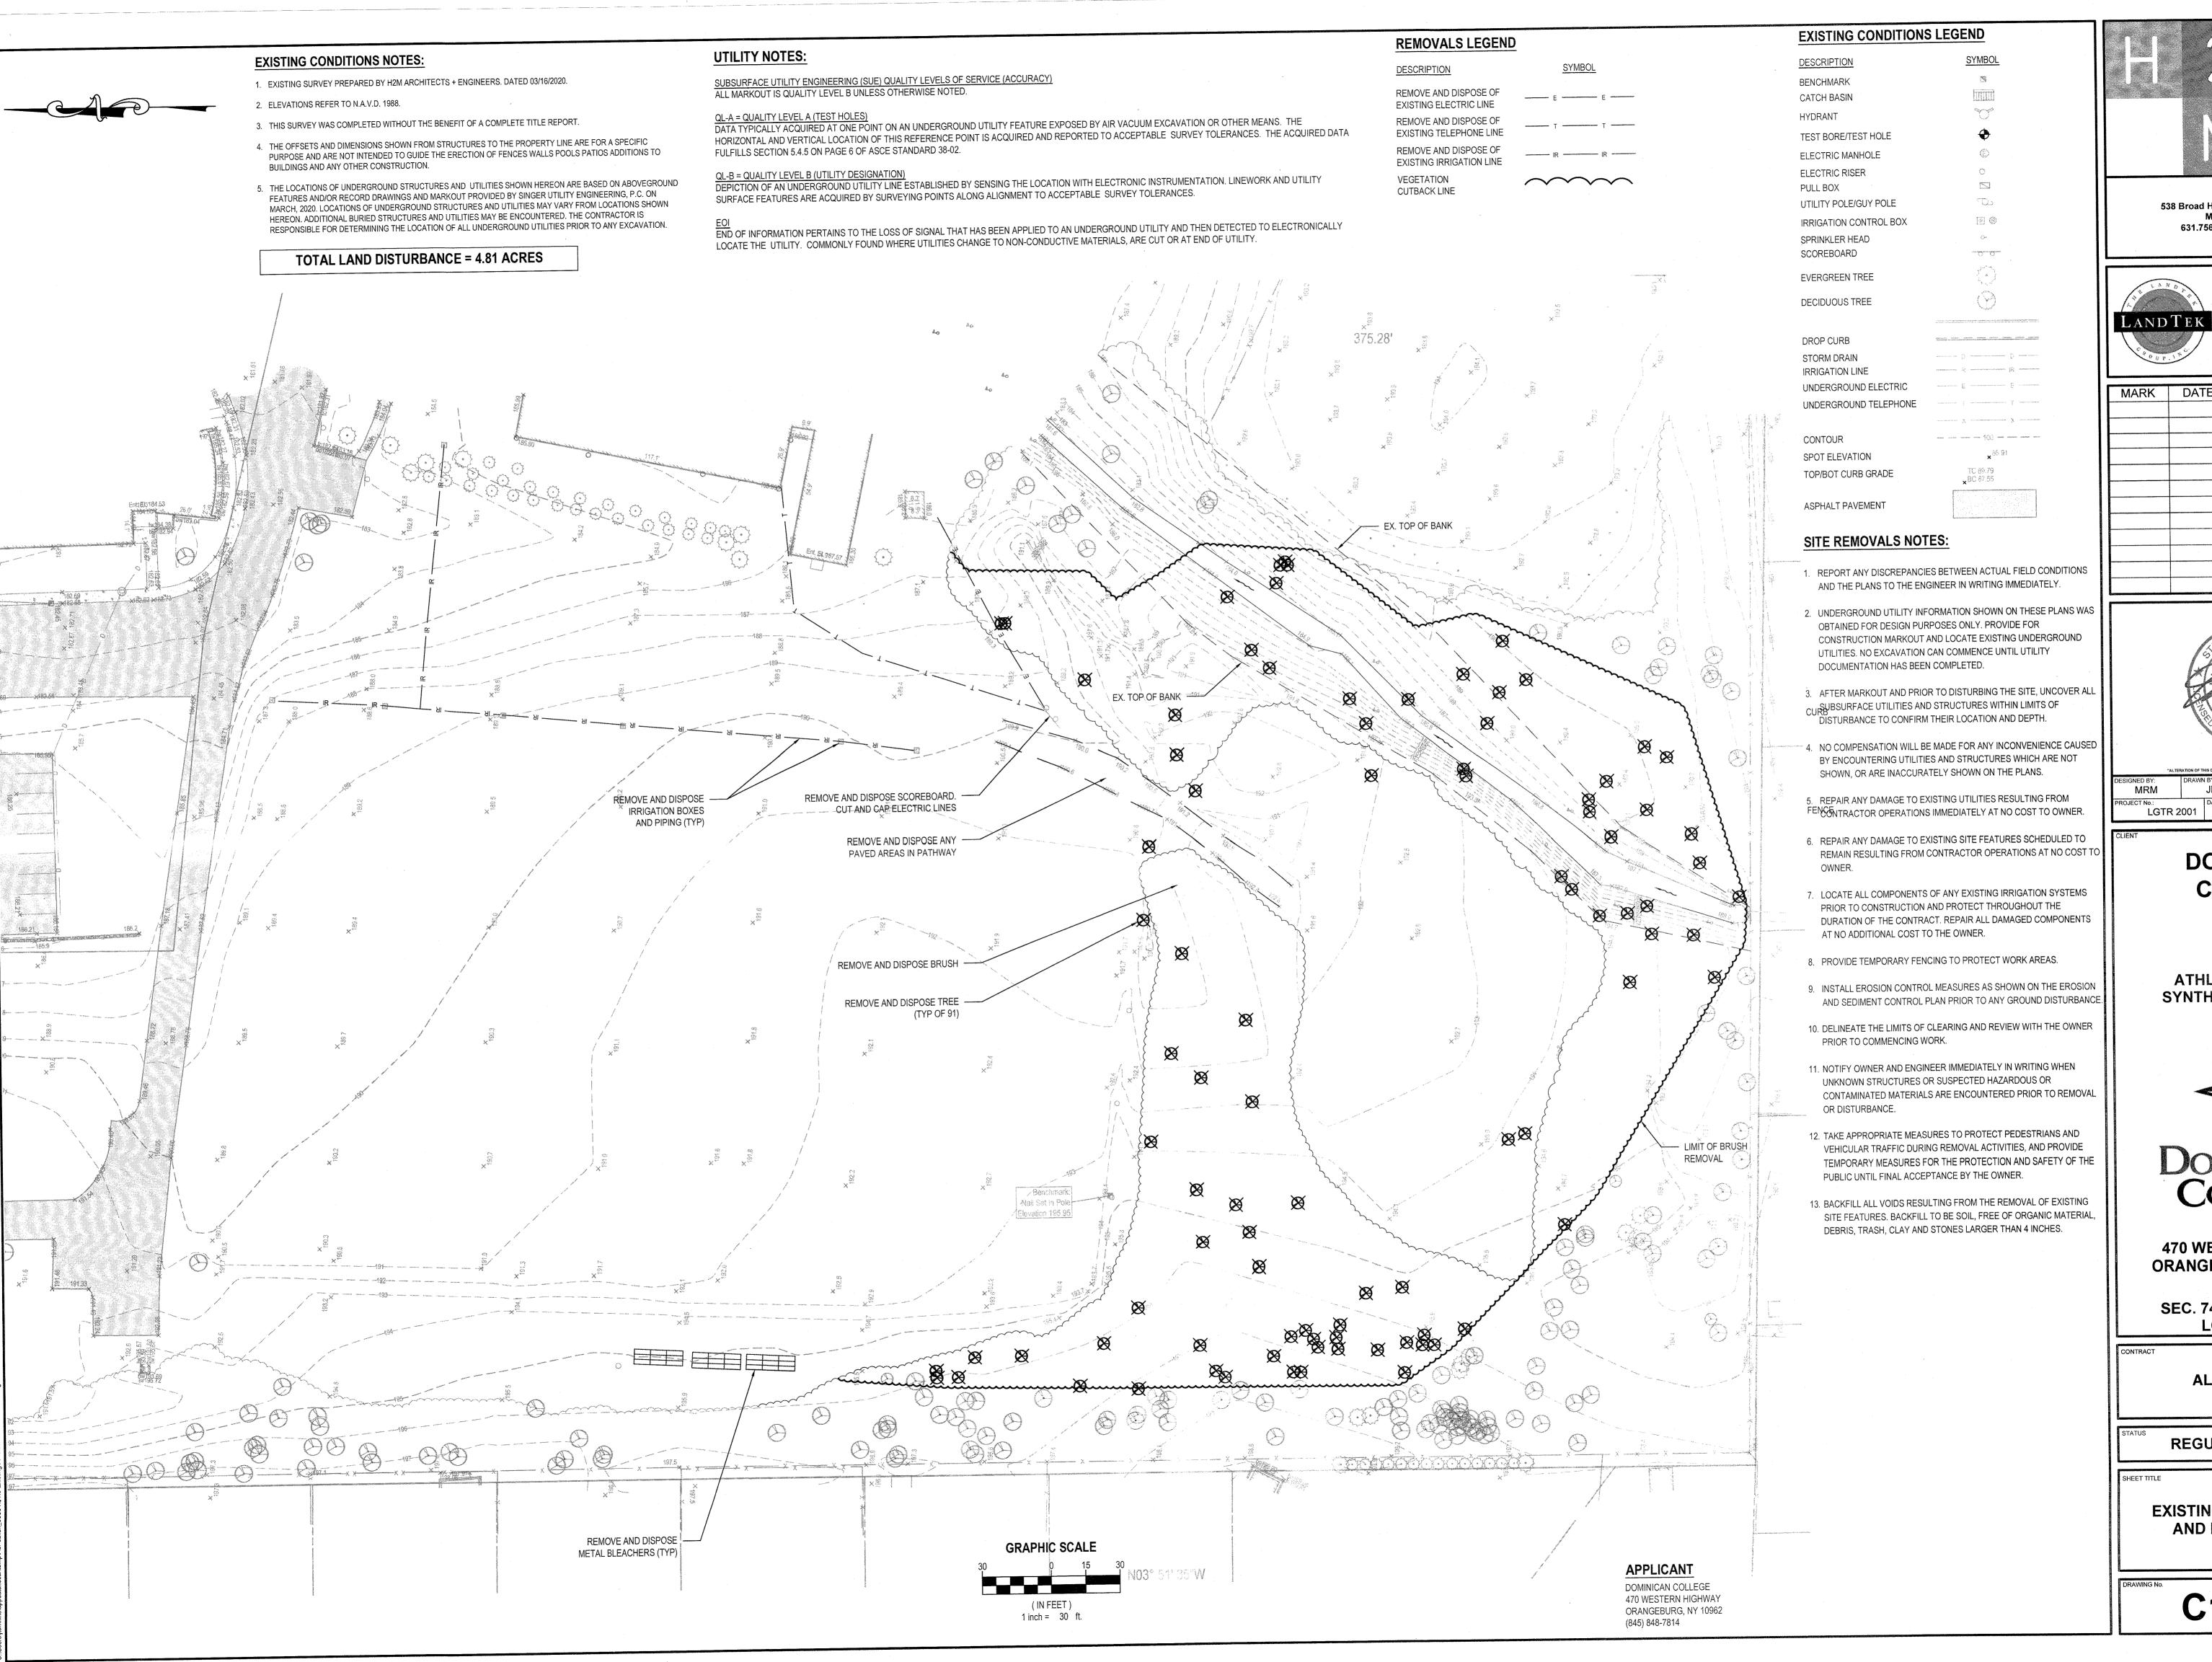

engineers


538 Broad Hollow Road, 4th Floor East Melville, NY 11747 631.756.8000 • www.h2m.com



235 County Line Rd Amityville, NY 11701 631-691-2381 631-598-8280

www.landtekgroup.com

DESCRIPTION

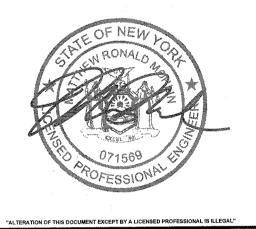

LGTR 2001 | AUG. 30, 2021 | AS SHOWN

DOMINICAN COLLEGE

ATHLETIC COMPLEX SYNTHETIC TURF FIELD




470 WESTERN HIGHWAY ORANGEBURG, NEW YORK 10962


SEC. 74.06, BLOCK 3, P/O LOTS 1.1 & 1.3

ALL CONTRACTS

REGULATORY REVIEW

EXISTING SITE CONDITIONS AND REMOVALS PLAN

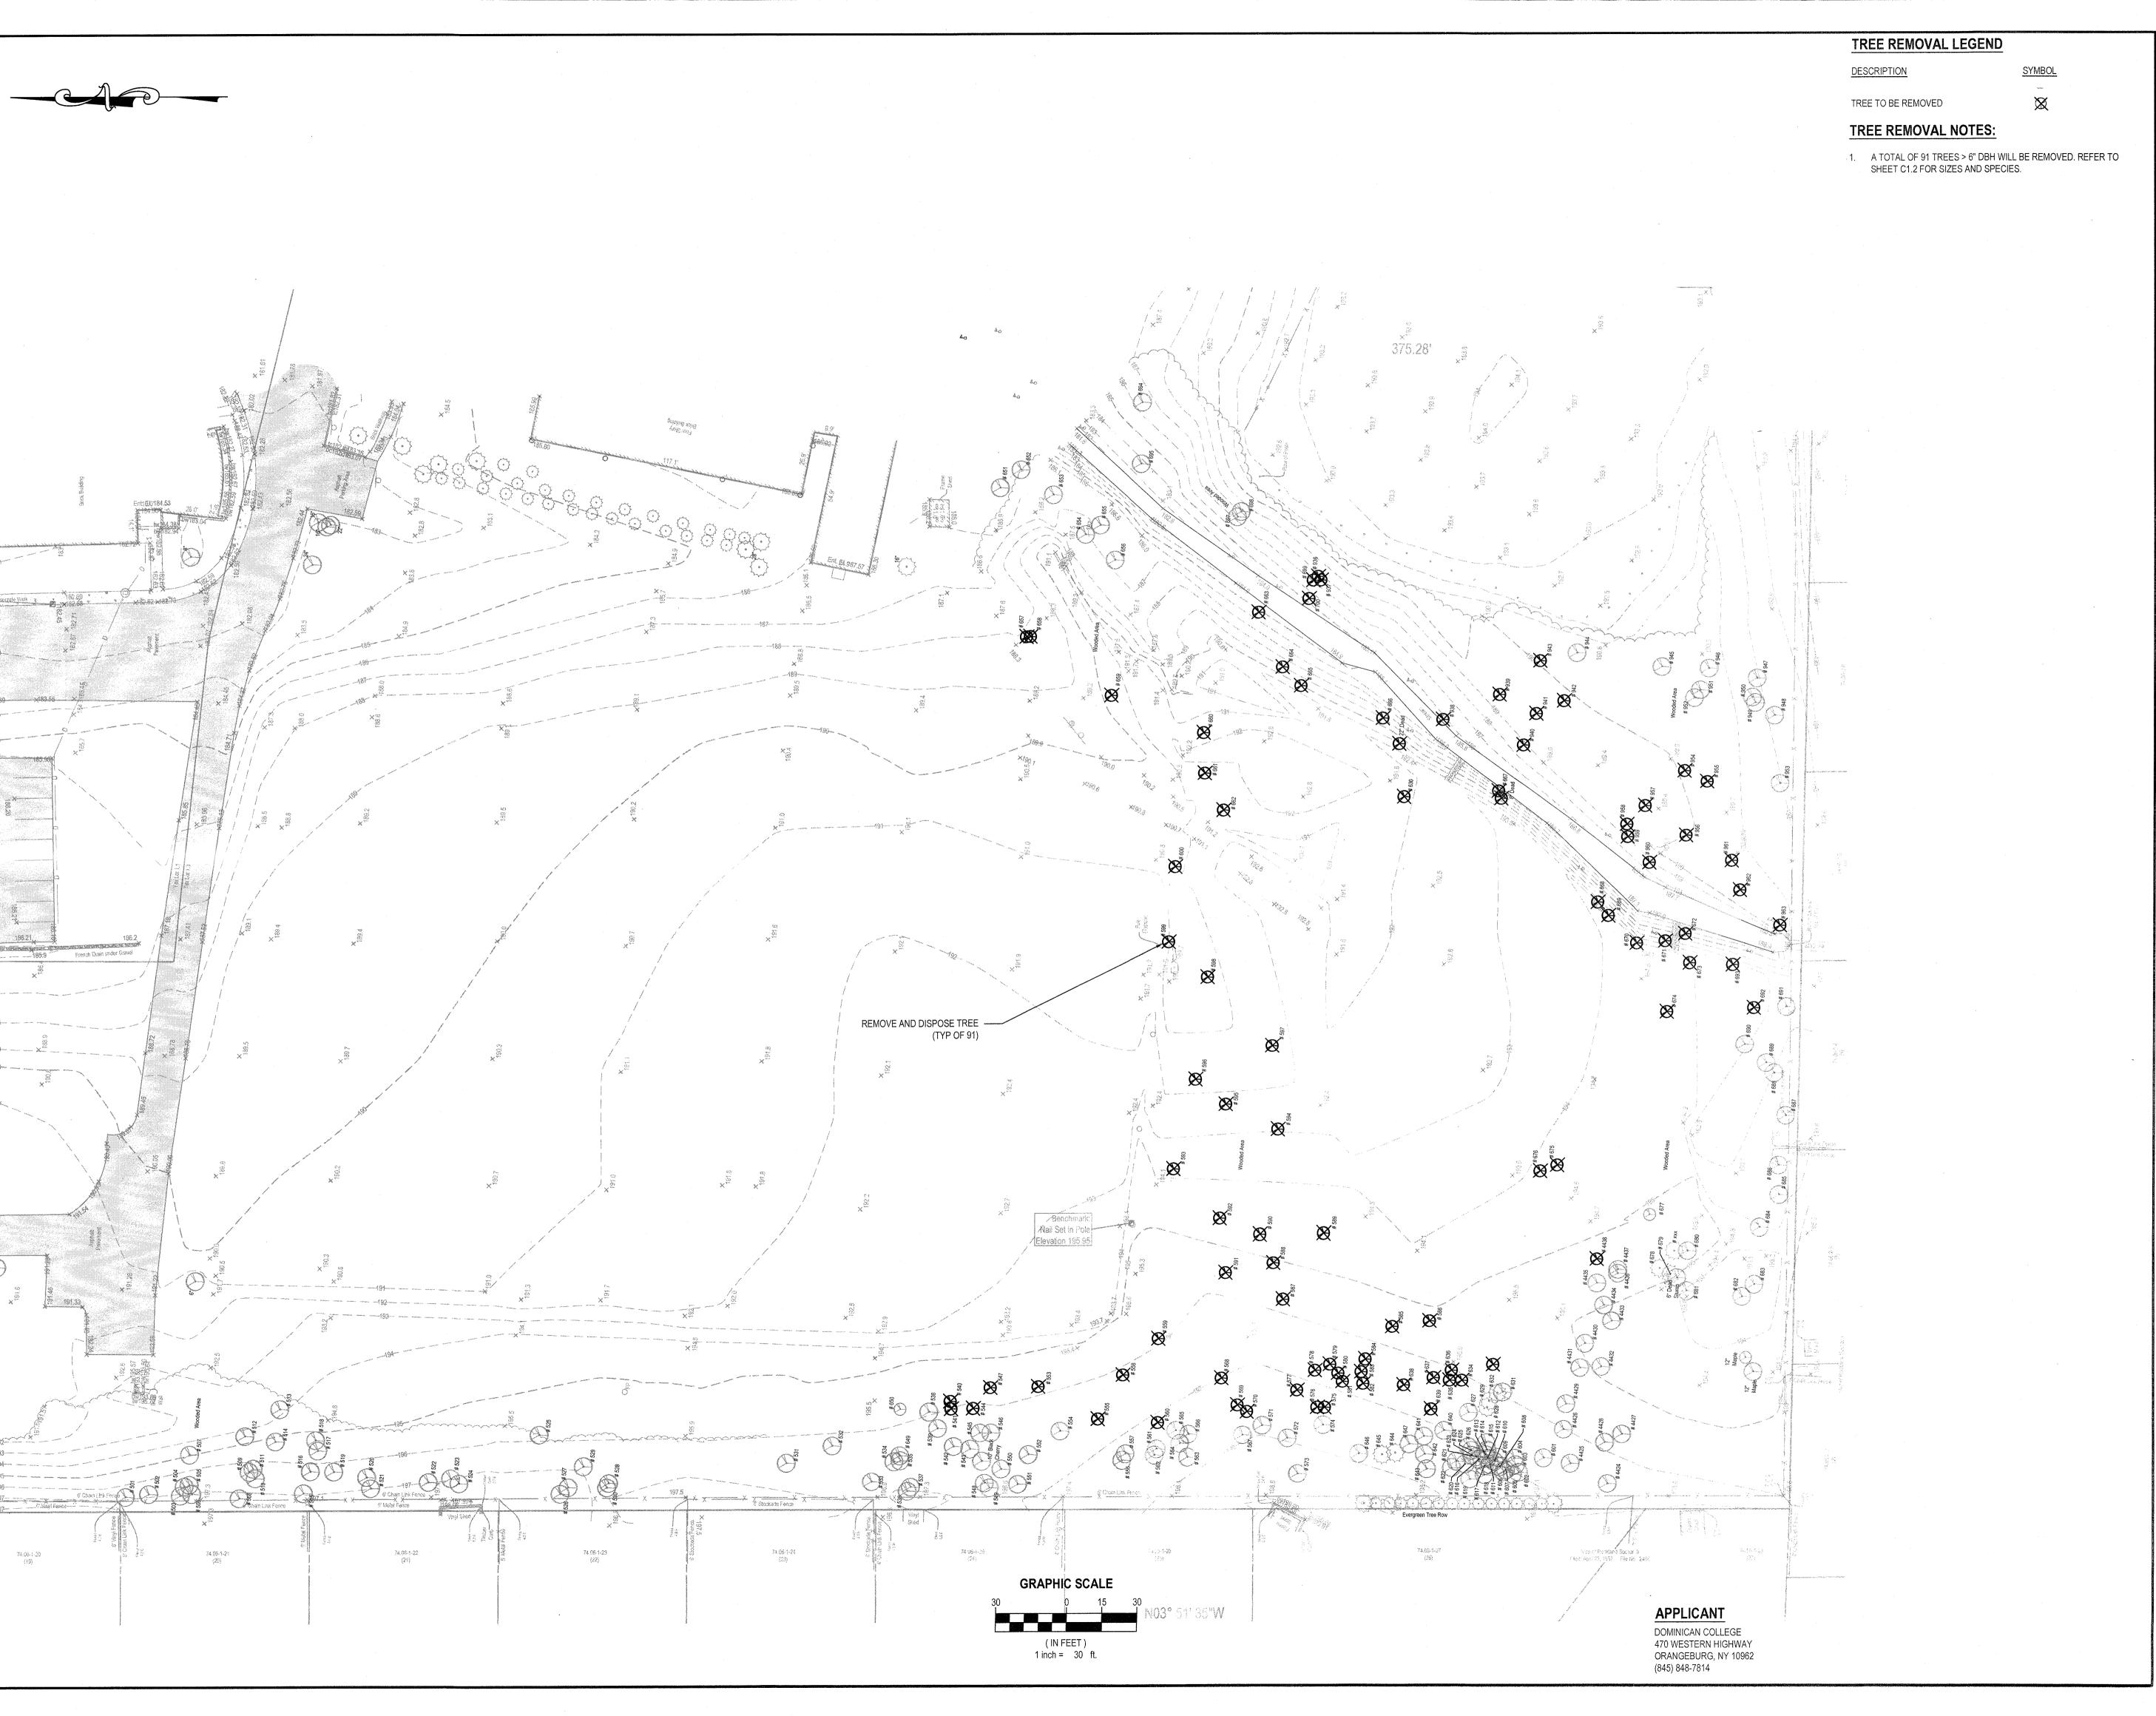

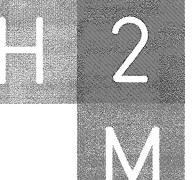

architects + engineers

538 Broad Hollow Road, 4th Floor East Melville, NY 11747 631.756.8000 • www.h2m.com



THE LANDTEK GROUP, INC

235 County Line Rd Amityville, NY 11701 631-691-2381 631-598-8280 www.landtekgroup.com

| MARK | DATE | DESCRIPTION |
|------|------|-------------|
| | | |
| | | |
| | | |
| | | |
| | | |
| | | |
| | | |
| | · | |
| | | |
| | | |
| | | |
| | | |



DESIGNED BY:

MRM

DRAWN BY:

CHECKED BY:

MRM

DATE:

LGTR 2001

DATE:

AUG. 30, 2021

AS SHOWN

DOMINICAN COLLEGE

ATHLETIC COMPLEX SYNTHETIC TURF FIELD



470 WESTERN HIGHWAY ORANGEBURG, NEW YORK 10962

SEC. 74.06, BLOCK 3, P/O LOTS 1.1 & 1.3

CONTRACT


ALL CONTRACTS

REGULATORY REVIEW

SHEET TITL

TREE REMOVAL PLAN

C1.1

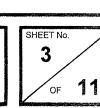

| Sheet_ | <u>4 of 6</u> | | Prepared By: NR, KAK Date: 03/25/21 |
|------------|--|--------------------|--|
| ROJ NAME | Dominican College Athletic Complex Synthetic Turf Field | | SHADE INDICATES TREE TO BE REMOVED |
| ROJ# | LTGR 2001 | | |
| TREE # | COMMON NAME | D.B.H. (INCHES) | COMMENTS |
| 627 | MAPLE, NORWAY | 12.0 | |
| 628 | PINE, EASTERN WHITE | 7.0 6.0 | |
| 629 630 | PINE, EASTERN WHITE UNKNOWN DEAD TREES | 16.0 | LOCATED NEAR 670-680 SERIES |
| 631 | BIRCH, SWEET | 10.5 | |
| 632 | CHERRY, BLACK | 7.5 | The state of the s |
| 633 | PINE, EASTERN WHITE | 15.0 | |
| 634 | HICKORY, BITTERNUT | 16,6,13 | Multi-stem |
| 635 | ASH, WHITE | 14.0 | |
| 636 | CHERRY, BLACK | 7.5 | |
| 637 | PINE, EASTERN WHITE | 8.0 | |
| 638 639 | BEECH, AMERICAN PINE, EASTERN WHITE | 7.5 | |
| 640 | PINE, EASTERN WHITE | 6.5 | |
| 641 | BLACKGUM | 13.5 | |
| 642 | BLACKGUM | 6.5 | |
| 643 | BLACKGUM | 9,4 | Multi-stem |
| 644 | PINE, EASTERN WHITE | 17.0 | |
| 645 | PINE, EASTERN WHITE | 12.0 | |
| 646 | AMERICAN SYCAMORE | 11.0 | |
| 647 | PINE, EASTERN WHITE UNKNOWN DEAD TREES | 6.5 16.0 | LOCATED NEAR 670-680 SERIES |
| 648 649 | ASH, WHITE | 7.5 | LOCATED NEAR 570-680 SERIES LOCATED NEAR THE 530 - 550 SERIES |
| 650 | CHERRY, BLACK | 7.5 | LOCATED NEAR THE 530 - 550 SERIES |
| 651 | CHERRY, OTHER | 10.0 | |
| 652 | COTTONWOOD, SWAMP | 33.5 | |
| 653 | ASH, WHITE | 14.5 | |
| 654 | ELM, AMERICAN | 22.0 | |
| 655 | HICKORY, BITTERNUT | 11.5 | |
| 656 657 | ASH, WHITE ELM, AMERICAN | 6.5 8.0 | |
| 658 | ELM, AMERICAN | 7.0 | |
| 659 | BLACK LOCUST | 6.0 | |
| 660 | TREE OF HEAVEN | 8.0 | |
| 661 | CHERRY, BLACK | 6.0 | |
| 662 | TREE OF HEAVEN | 10.5 | |
| 663 | HICKORY, SHAGBARK | 15.5 | |
| 664 | ELM, SLIPPERY | 14.0 | |
| 565 | MAPLE, NORWAY | 8.0 | |
| 666 667 | HICKORY, SHAGBARK ASH, WHITE | 14,0 10.0 | |
| 667 | AMII, WEIFIG | TO'O | |

8.0 HACKBERRY HACKBERRY 18.0

FIELD_INVENTORY

BEECH, AMERICAN OAK, SWAMP WHITE

BEECH, AMERICAN BEECH, AMERICAN OAK, SWAMP WHITE MULBERRY, WHITE

Sheet<u>2</u> of <u>6</u>

PROJ#

543

549

550

552

556

573

PROJ NAME | Complex Synthetic Turf Field

COMMON NAME

ASH. WHITE

HICKORY BITTERNUT

MAPLE, NORWAY

WALNUT, BLACK

HICKORY, BITTERNUT

CHERRY, BLACK

MAPLE, NORWAY

CHERRY, BLACK

MAPLE, NORWAY

CHERRY, BLACK

ELM, SLIPPERY

CHESTNUT, AMERICAN

PINE, EASTERN WHIT

MAPLE, NORWAY

MAPLE, NORWAY

CHERRY, BLACK

CHESTNUT, AMERICAN

LINDEN, AMERICAN

MAPLE, NORWAY

MAPLE, NORWAY

ASH, WHITE

HICKORY, BITTERNUT

MAPLE NORWAY

MAPLE NORWAY

MAPLE, NORWAY

LINDEN, AMERICAN LINDEN, AMERICAN

LINDEN, AMERICAN

ASH, WHITE

LINDEN, AMERICAN

WALNUT, BLACK

PINE, EASTERN WHITE

PINE, EASTERN WHITE

PINE, EASTERN WHITE

PINE, EASTERN WHITE

UNKNOWN

PINE, EASTERN WHITE

PINE, EASTERN WHITI

PINE, EASTERN WHITE

PINE, EASTERN WHITE

PINE, EASTERN WHITE

Complex Synthetic Turf Field

COMMON NAME

OAK, NORTHERN RED

MAPLE, NORWAY

BIRCH, SWEET

ELM, AMERICAN

BOXELDER

OAK, PIN

DOGWOOD, OTHER

DOGWOOD, OTHER

UNKNOWN DEAD TREE

CHERRY, BLACK

SPRUCE, OTHER

HICKORY, SHAGBARK

OAK, PIN

OAK, PIN

CHESTNUT, AMERICAN

ELM, SLIPPERY

OAK, PIN

ASH, WHITE

ASH, WHITE

BIRCH, SWEET

OAK, WHITE

OAK, SCARLET

OAK, WHITE

BOXELDER OAK, WHITE

SWEETGUM

HAWTHORN, ENGLISH

AMERICAN SYCAMORE

Sheet_5_of__6_

LTGR 2001

PROJ NAME

PROJ#

679

680

685

686

687

689

691

LTGR 2001

OAK, PIN WALNUT, BLACK HONEYLOCUST WALNUT, BLACK 12.0 944 HICKORY, SHAGBARK 945

OAK, SWAMP WHITE

Prepared By: NR, KAK

Date: 03/25/21

2 architects - engineers

COMMENTS

(INCHES)

25.0

6.0

9.0

8.0

6.5

10.5

6.0

22.5

(INCHES)

7.0

7.0

9.0

8.0

6.5

18.0

15.0

8.0

30.0

28.0

9.0

11.0

9.0

23.5

36.0 9.0

6.0

COMMENTS

ADE INDICATES TREE TO BE REMOVED

Sheet<u>3_of_6</u>

omnlex Synthetic Turf Field PROJ NAME

PROJ#

LINDEN, AMERICAN ASH, WHITE LINDEN, AMERICAN ASH, WHITE HICKORY, BITTERNUT

HACKBERRY ASH, WHITE ASH, WHITE HICKORY, BITTERNUT HICKORY BITTERNUT BEECH, AMERICAN 601 PINE, EASTERN WHITE BLACKGUM 602 603 BLACKGUM

BLACKGUM BLACKGUM 605 606 CHERRY, BLACK 607 BLACKGUM 608 BLACKGUM 609 BLACKGUM 610 BLACKGUM

611 BLACKGUM 612 MULBERRY, WHITE BLACKGUM 613 614 BLACKGUM 615 BLACKGUM BLACKGUM 616 617 BLACKGUM

BLACKGUM

BLACKGUM

Complex Synthetic Turf Field

(INCHES)

36.0

9.0

7.0

10.0

34.0 11.0

41.0

13,12.5

5.5

9.5

17.0

14.5

12.0

COMMENTS

618 BLACKGUM 619 BLACKGUM 620 BLACKGUM BLACKGUM 621 622 BLACKGUM 623 BLACKGUM 624 BLACKGUM

Sheet_6_of__6_

PROJ NAME

PROJ# LTGR 2001

FIELD_INVENTORY

Date: 03/25/21

HADE INDICATES TREE TO BE REMOVED

Prepared By: NR, KAK

COMMON NAME HICKORY, SHAGBARK 947 CHESTNUT, AMERICAN OAK, PIN BEECH, AMERICAN BEECH, AMERICAN CHESTNUT, AMERICAN 952 CHESTNUT, AMERICAN 953 OAK, PIN OAK, PIN OAK, PIN OAK, PIN HICKORY, OTHER OAK, PIN SWEETGUM ASH, WHITE BIRCH, SWEET

ELM, SLIPPERY ASH, WHITE 4424 ASH, WHITE 4425 MAPLE, NORWAY 4426 DOGWOOD, OTHER 4427 MAPLE, RED 4428 PINE, EASTERN WHITE 4429 MAPLE, NORWAY PINE, EASTERN WHITE PINE, EASTERN WHITE 4432 PINE, EASTERN WHITE

> PINE, EASTERN WHITE MAPLE, RED MAPLE, RED PINE, EASTERN WHITE 9.0 MAPLE, RED

PINE, EASTERN WHIT

FIELD_INVENTORY

Prepared By: NR, KAK architectus conjugara Date: 03/25/21

| mplex synthetic run i reid | | | | | | |
|----------------------------|--------------------|-------------------------|--|--|--|--|
| GR 2001 | | | | | | |
| COMMON NAME | D.B.H. (INCHES) | COMMENTS | | | | |
| MAPLE, RED | 19.0 | Multi-stem (Combined) | | | | |
| MAPLE, RED | 11.5 | | | | | |
| DOGWOOD, OTHER | Multistem | Multi-stem (7 stems) | | | | |
| LINDEN, AMERICAN | 10.0 | | | | | |
| BLACK LOCUST | Multistern | Multi-stem (many stems) | | | | |
| | | | | | | |

6.0 6,6 ulti-stem

6.5 6.5 10.0 7.0 6.0 6.0 5.5

9,11 Julti-stem 11.5 8.0 6.5 8.0

8.5 7.0 8.5 7.0

8.0 6.0 7.0 8.5 8.5 FIELD_INVENTORY

Prepared By: NR, KAK Date: 03/25/21 SHADE INDICATES TREE TO BE REMOVED

> ATHLETIC COMPLEX SYNTHETIC TURF FIELD



JMT

LGTR 2001 | AUG. 30, 2021 | AS SHOWN

DOMINICAN

COLLEGE

engineers

THE LANDTEK GROUP, INC

235 County Line Rd

Amityville, NY 11701

631-691-2381

631-598-8280

www.landtekgroup.com

DESCRIPTION

538 Broad Hollow Road, 4th Floor East

Melville, NY 11747 631.756.8000 • www.h2m.com

MARK | DATE

470 WESTERN HIGHWAY ORANGEBURG, NEW YORK 10962

SEC. 74.06, BLOCK 3, P/O LOTS 1.1 & 1.3

ALL CONTRACTS

REGULATORY REVIEW


APPLICANT


(845) 848-7814

DOMINICAN COLLEGE 470 WESTERN HIGHWAY ORANGEBURG, NY 10962

FIELD_INVENTORY

TREE REMOVAL LIST

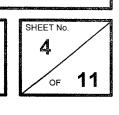

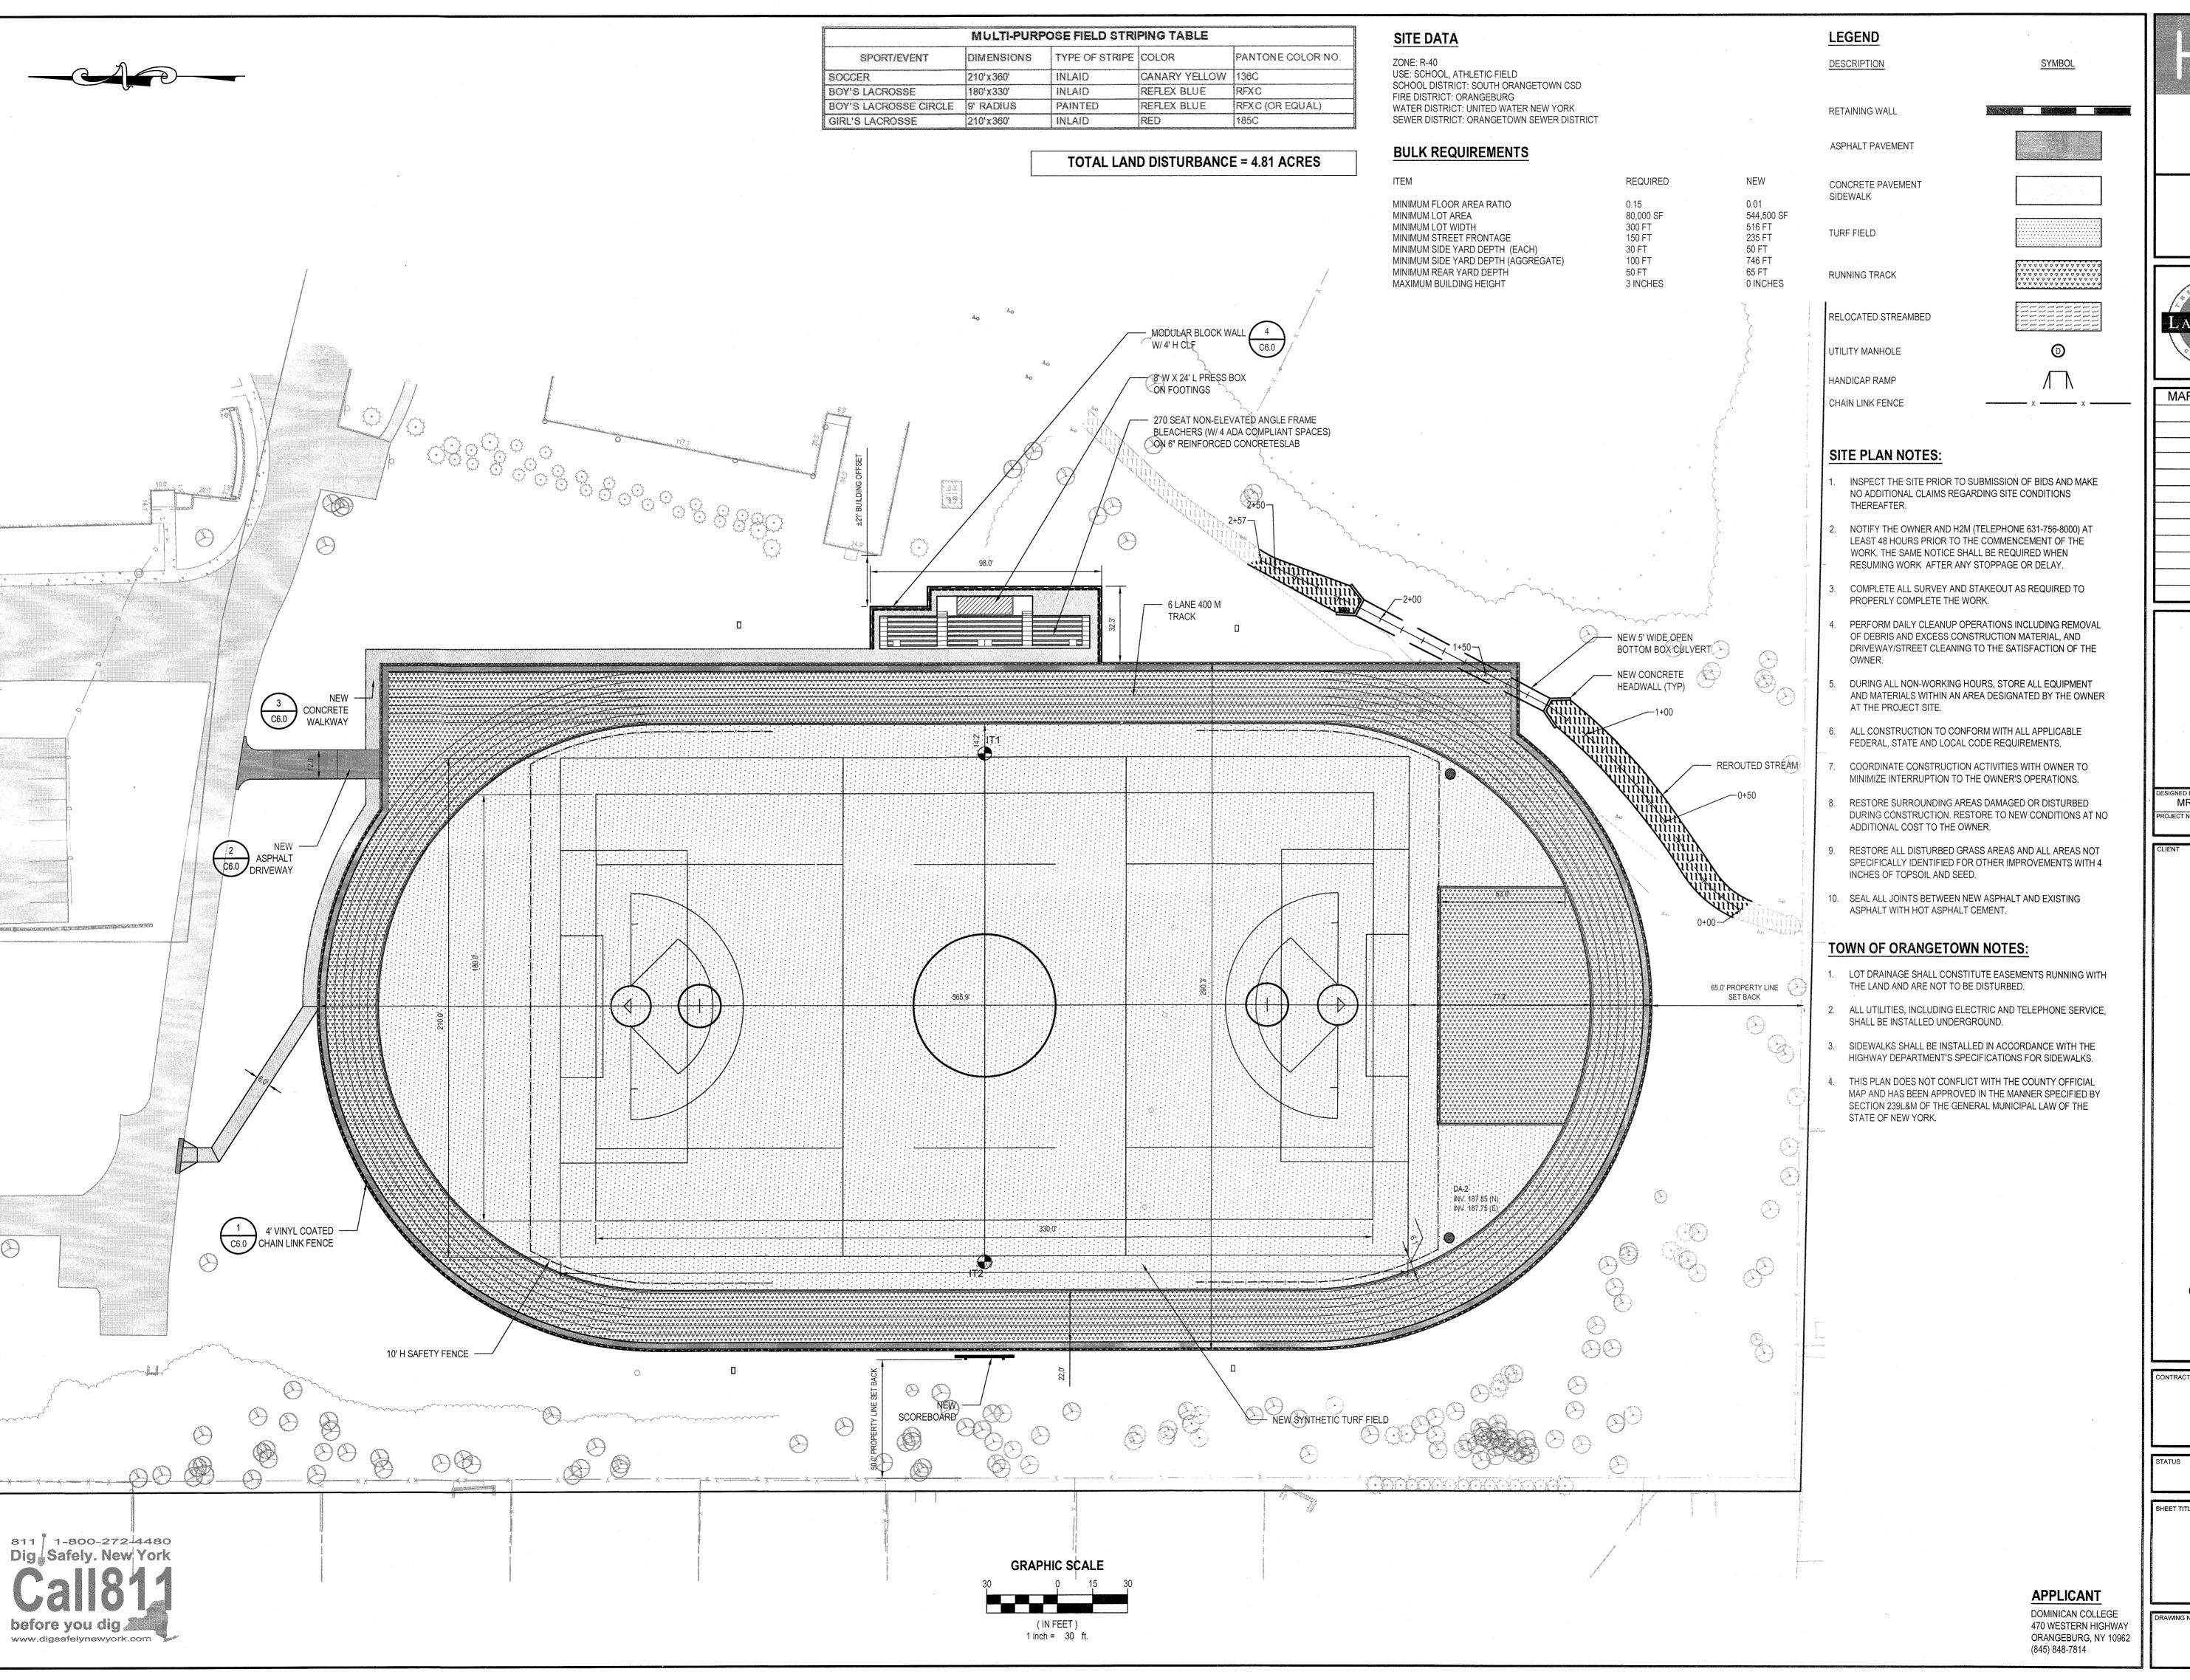

engineers


538 Broad Hollow Road, 4th Floor East Melville, NY 11747 631.756.8000 • www.h2m.com



THE LANDTEK GROUP, INC

235 County Line Rd Amityville, NY 11701 631-691-2381 631-598-8280 www.landtekgroup.com

| MARK | DATE | DESCRIPTION |
|---------------------------------------|------|-------------|
| | | |
| | | |
| · · · · · · · · · · · · · · · · · · · | | |
| | | |

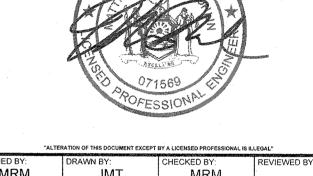

| ALIE | CATION OF I | HIS DOCUMENT EXCEPT | BY A LICENSED PROFES | SIONAL IS IL | LEGAL" |
|--------------------|------------------|---------------------|----------------------|--------------|--------------|
| MRM | DRAWN BY: JMT | | CHECKED BY: MRM | | REVIEWED BY: |
| ECT No.: LGTR 2 | 001 | DATE: AUG. 3 | 0, 2021 | SCALE | AS SHOWN |

DOMINICAN COLLEGE

ATHLETIC COMPLEX SYNTHETIC TURF FIELD




470 WESTERN HIGHWAY ORANGEBURG, NEW YORK 10962


SEC. 74.06, BLOCK 3, P/O LOTS 1.1 & 1.3

ALL CONTRACTS

REGULATORY REVIEW

DIMENSIONAL SITE PLAN

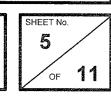

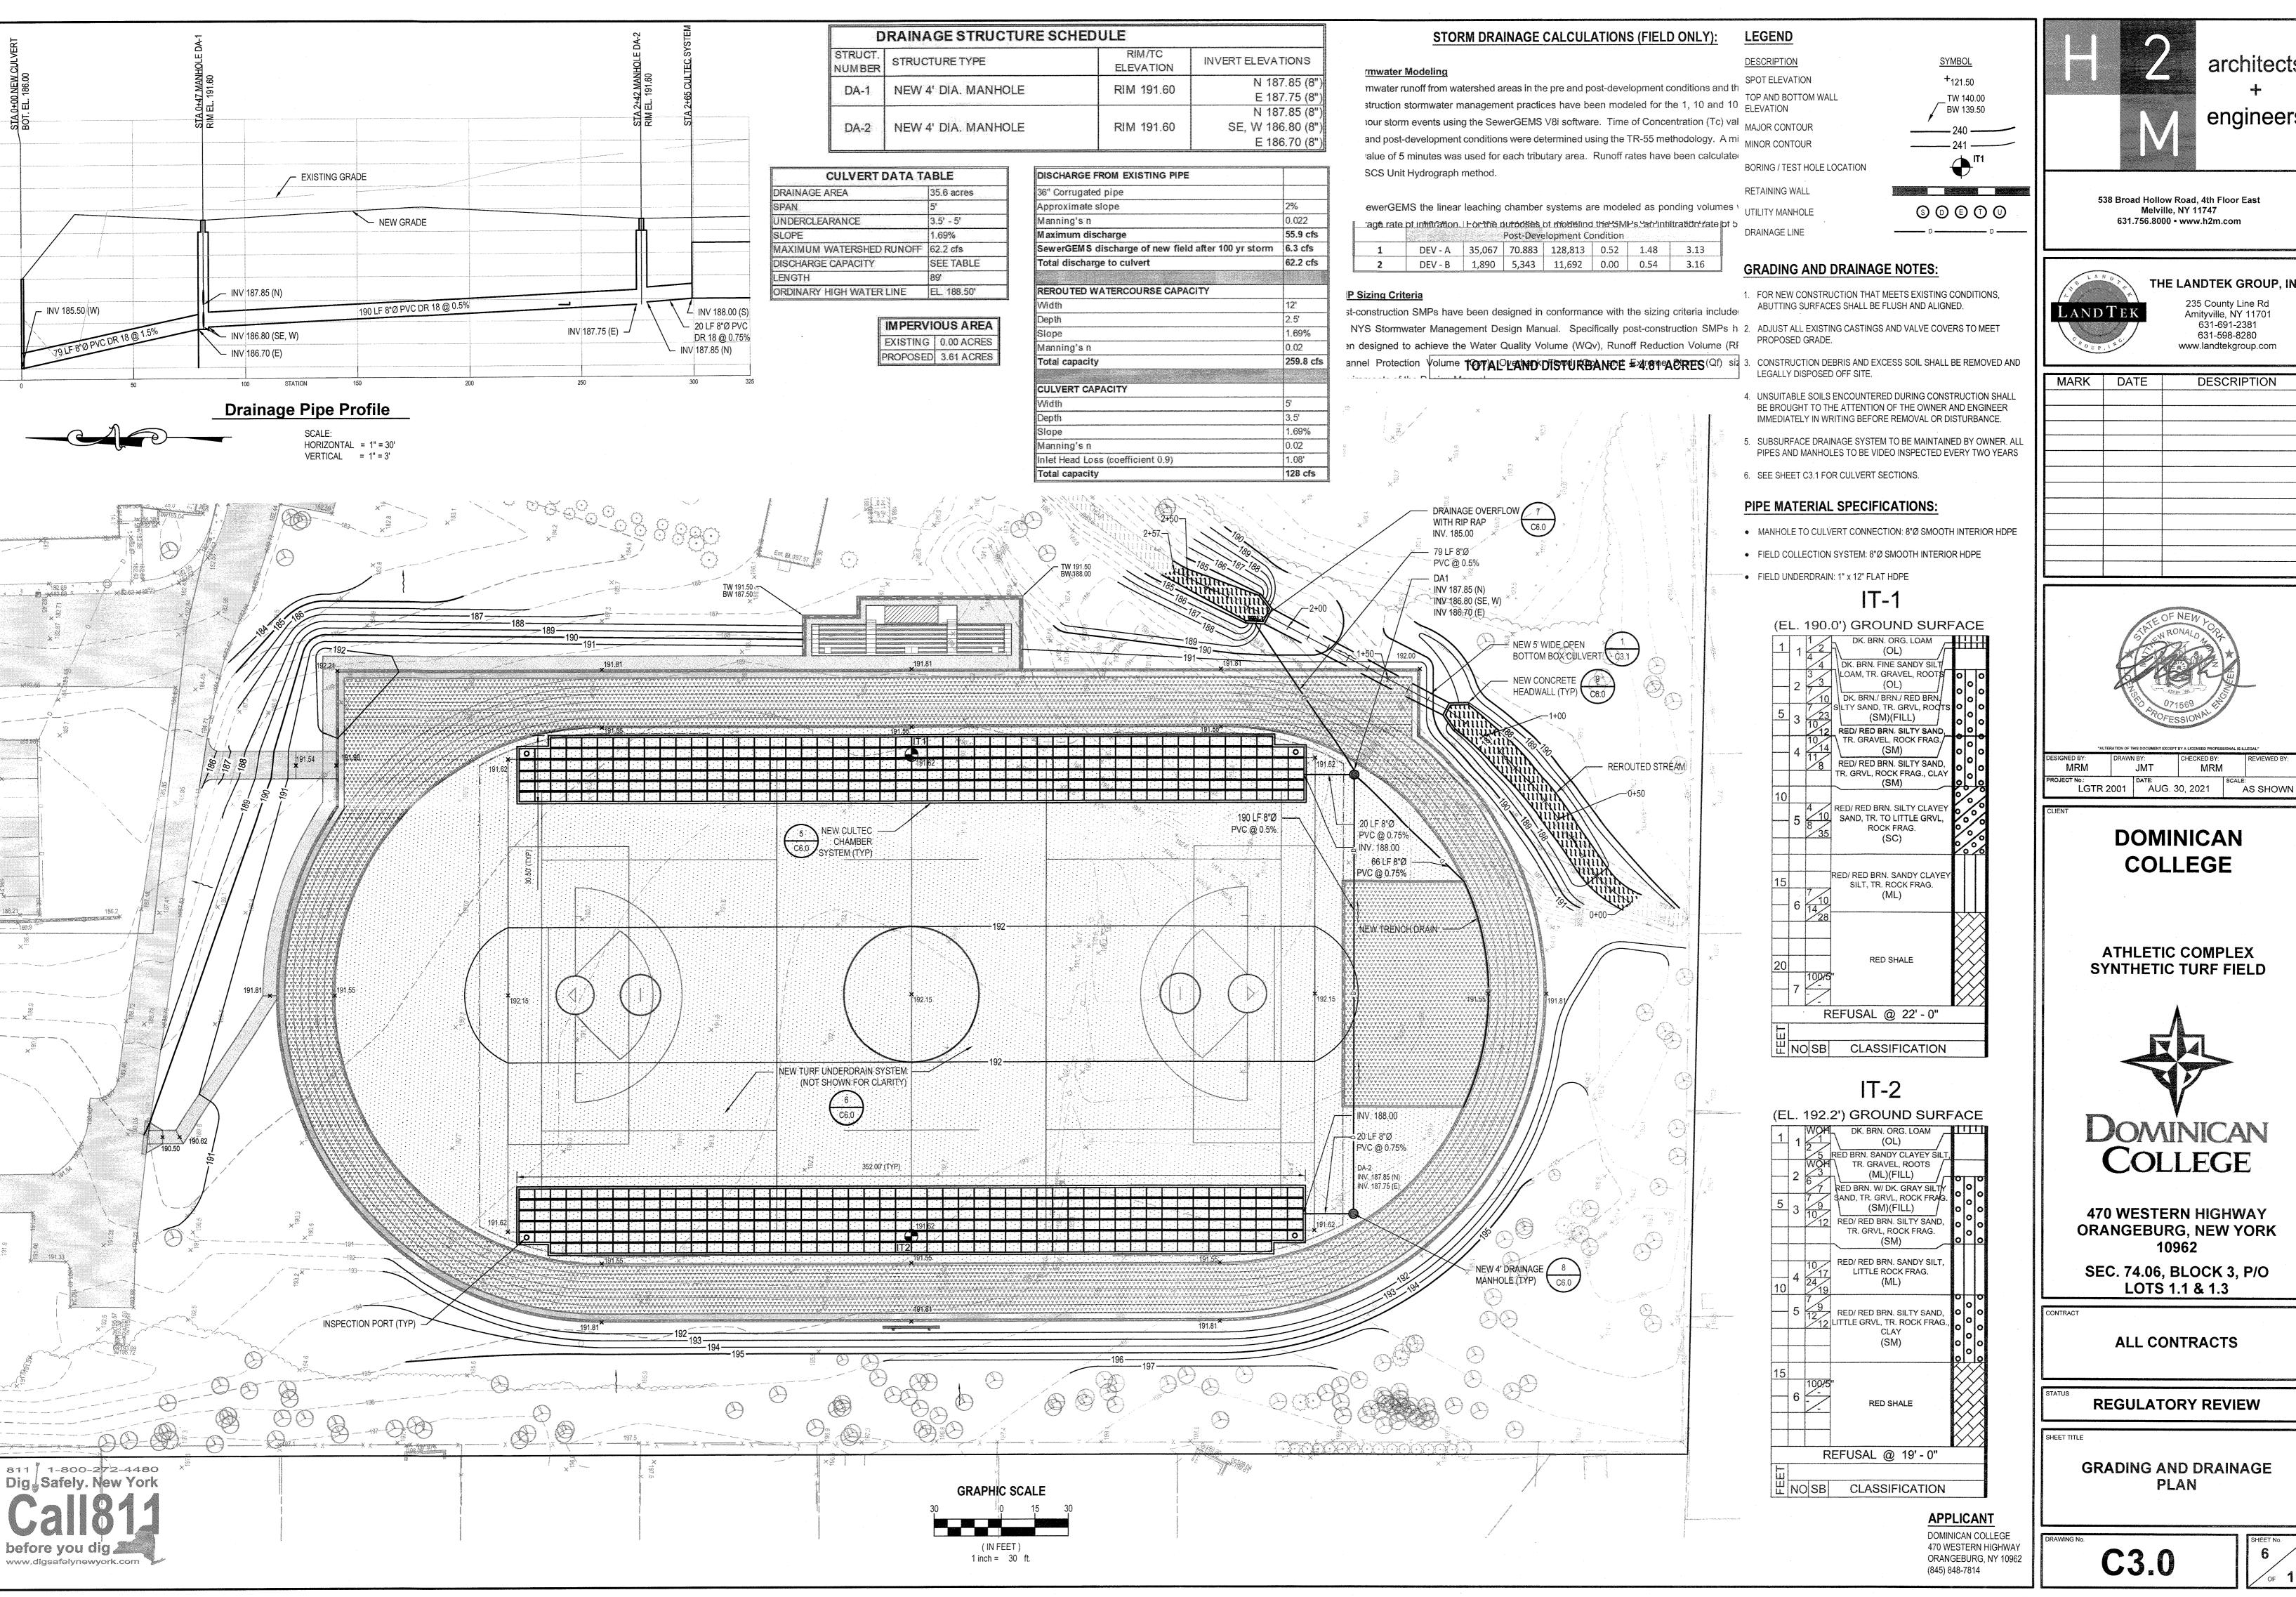

engineers


538 Broad Hollow Road, 4th Floor East Melville, NY 11747 631.756.8000 • www.h2m.com



235 County Line Rd Amityville, NY 11701 631-691-2381 631-598-8280

www.landtekgroup.com

MARK DATE DESCRIPTION

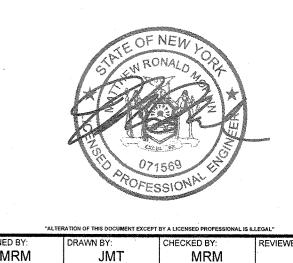

DOMINICAN COLLEGE

ATHLETIC COMPLEX SYNTHETIC TURF FIELD



470 WESTERN HIGHWAY ORANGEBURG, NEW YORK 10962


SEC. 74.06, BLOCK 3, P/O LOTS 1.1 & 1.3


ALL CONTRACTS

REGULATORY REVIEW

GRADING AND DRAINAGE PLAN

C3.0

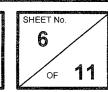

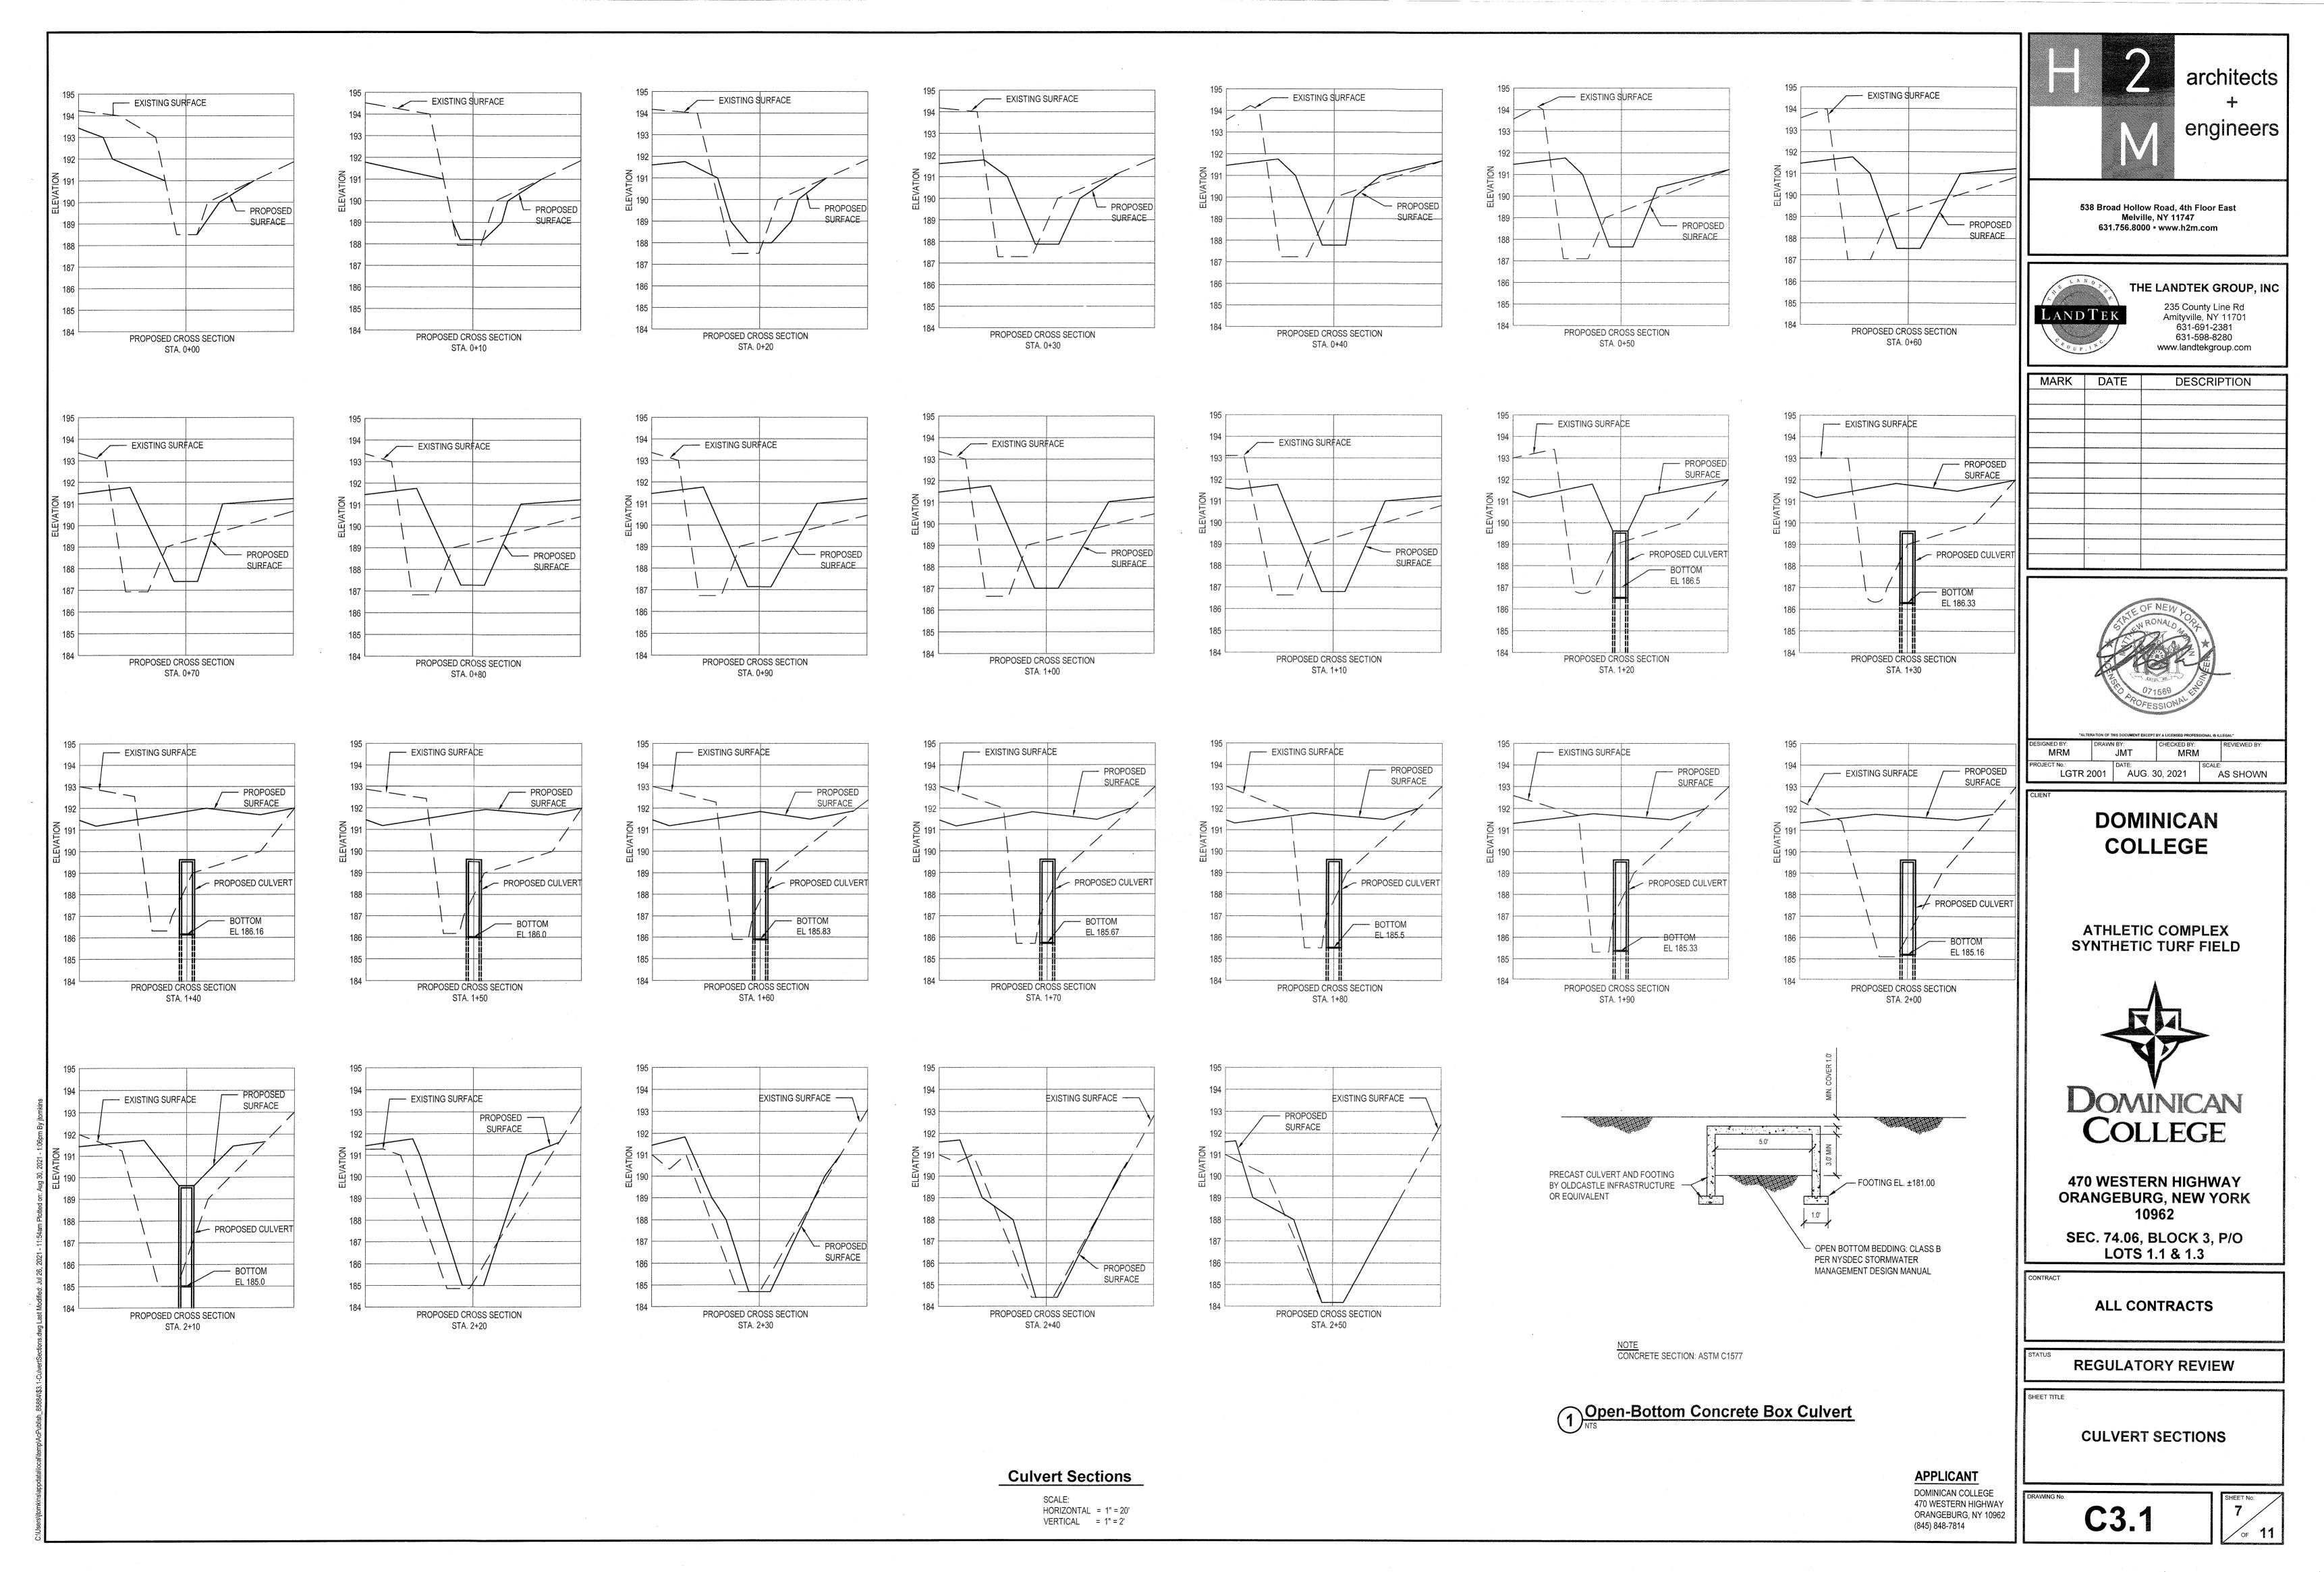

| KEY | BOTANICAL NAME | COMMON NAME | CAL. | MAT. HT. | REMARKS |
|---|-----------------------|---|--------------|------------|--|
| | TREES | | | | |
| | Quercus alba | White Oak | 2" - 3" | 80' - 100' | The second secon |
| N. N. P. W. | Picea ables | Norway Spruce | 2" | 6' - 7' | |
| | SEEDING | | SEI | ED MIX | SEEDING RATE |
| SUN & SHADE | Poa pratensis | Kentucky Bluegrass (Min of 3 cultivars) | *107 *** *** | 15% | Control Desire Annual St. S. Nove A St. S. Nove () |
| MIX | Festuca rubra variety | Creeping Red Fesque | | 15% | |
| | Lolium perenne | Perennial Rygrass | | 15% | Seed at 5 lbs per 1,000 SF |
| | Lolium | Annual Rygrass | | 5% | |

| WETLAND PLANT MATERIAL LIST | | | | | | | | |
|-----------------------------|----------------------------------|---|---------------------------|--------------------------|--|--|--|--|
| KEY | BOTANICAL NAME | COMMON NAME | SPACE | ROOT | REMARKS | | | |
| CEB AWV | Morella pensylvanica | Red-osier Dogwood Common Elderberry Arrowwood Viburnum Northern Bayberry | 6' 6' 6' 6' | B&B B&B B&B B&B | All shrubs to be full and dense with the minimum number of canes for size requested in accordance with the latest edition of the American Standard for Nursery Stock. Spacing of shrubs shall be as shown on the plan or as noted. Plants listed from wet to dry, and should be placed from bottom of slope to top of slope. | | | |
| WETLAND MIX | SEEDING Ernst Conservation Seeds | Riparian Buffer Mix | SEED PROPORTION 100 | BY WEIGHT | SEEDING RATE Seed at 20 lbs per acre | | | |


WETLAND VEGETATION SEE PLANT MATERIAL TABLE)

<u>LEGEND</u>

DESCRIPTION

SYMBOL

WETLAND PLANTINGS

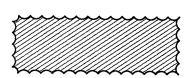


PLANTING NOTES

- 1. ALL SUPPLIED AND INSTALLED PLANT MATERIAL SHALL BE NURSERY GROWN STOCK IN ACCORDANCE WITH THE LATEST EDITION OF THE "AMERICAN STANDARD FOR NURSERY STOCK" (ANSI Z60.1). PLANT MATERIAL SHALL BE OF THE APPROVED SPECIES AND GROWN UNDER THE SAME CLIMATIC CONDITIONS AS THE SUBJECT SITE. THEY SHALL BE OF SYMMETRICAL GROWTH, FREE OF INSECTS, PESTS, AND DISEASE. SUBSTITUTIONS MUST BE APPROVED IN WRITING BY THE LANDSCAPE ARCHITECT.
- 2. CONFIRM THE LOCATION OF EXISTING SUBSURFACE UTILITIES WITH THE RESPECTIVE UTILITY COMPANIES AND COORDINATE WITH THE GRADING AND DRAINAGE PLAN OR UTILITY PLAN FOR THE LOCATION OF PROPOSED SUBSURFACE UTILITY LINES AND STRUCTURES PRIOR TO ANY EXCAVATION. NOTIFY THE LANDSCAPE ARCHITECT IF ANY CONFLICTS EXIST.
- 3. NOTIFY THE LANDSCAPE ARCHITECT IMMEDIATELY AND PRIOR TO THE INSTALLATION OF ANY PLANT MATERIALS IF SUB-GRADE SOIL CONDITIONS ARE DELETERIOUS TO PLANT GROWTH OR WILL INHIBIT DRAINAGE.
- 4. IF ANY DISCREPANCY EXISTS BETWEEN THE PLANT COUNT SHOWN IN THE PLANT MATERIAL LIST AND THE PLANTING PLAN, THE PLAN SHALL TAKE PRECEDENCE.
- 5. UNLESS OTHERWISE APPROVED IN WRITING, INSTALL VEGETATION DURING THE FOLLOWING PERIODS:
- a. DECIDUOUS WOODY PLANTS: SEPTEMBER 15 TO MAY 15
 WHENEVER TEMPERATURE IS ABOVE 40 DEGREES F.
 b. EVERGREENS: AUGUST 15 TO SEPTEMBER 15 OR DURING APRIL
- AND MAY BEFORE THE START OF NEW GROWTH.

 c. SEEDING: APRIL 1 TO MAY 15 AND SEPTEMBER 1 TO OCTOBER 15.
- 6. PLANTS SHALL BEAR THE SAME RELATIONSHIP TO FINISHED GRADE AS THEY BORE TO THE EXISTING GRADE IN THE NURSERY.
- 7. THE TRUNK DIAMETER OF DECIDUOUS TREES SHALL BE MEASURED IN ACCORDANCE WITH THE LATEST EDITION OF THE "AMERICAN STANDARD FOR NURSERY STOCK" (ANSI Z60.1) FOR THE CALIPER SIZE AS SHOWN IN THE PLANT MATERIAL LIST.
- ALL DECIDUOUS TREES SHALL BE BRANCHED NOT LOWER THAN SEVEN (7) FEET WITH AN AVERAGE HEIGHT AND SPREAD FOR THE PARTICULAR SIZE AND SPECIES SPECIFIED, IN ACCORDANCE WITH THE LATEST EDITION OF THE AMERICAN STANDARD FOR NURSERY STOCK.
- 9. INSTALL A 2"-3" LAYER OF SHREDDED BARK MULCH IN ALL TREE PLANTING AREAS AND SHRUB BEDS. DO NOT PLACE MULCH DIRECTLY AGAINST TRUNKS OF TREES. FORM AN EARTH SAUCER AROUND EACH PLANT OR SHRUB BED SO AS TO HOLD WATER AND MULCH. PROVIDE SUFFICIENT IRRIGATION FOR ALL PLANT MATERIALS TO MAINTAIN HEALTHY AND VIGOROUS CONDITION UNTIL THE PROJECT IS ACCEPTED BY THE OWNER.
- 10. ALL PLANT MATERIAL SHALL BE GUARANTEED FOR A PERIOD OF ONE YEAR AFTER PLANTING FOLLOWING ACCEPTANCE BY THE OWNER. UPON COMPLETION OF THE ONE YEAR PLANT GUARANTEE PERIOD, REPLACE ALL PLANT MATERIAL DEEMED DEAD, DYING OR DISEASED AS DETERMINED BY THE LANDSCAPE ARCHITECT. REPLACE PLANT WITH THE SAME SPECIES AND SIZE IMMEDIATELY DURING THE CURRENT GROWING SEASON
- 11. UPON COMPLETION OF PLANTING OPERATION CULTIVATE AND NEATLY RAKE ALL PLANTING AREAS.
- 12. RESTORE ALL DISTURBED GRASS AREAS AND ALL AREAS NOT SPECIFICALLY IDENTIFIED FOR OTHER IMPROVEMENTS WITH 4 INCHES OF TOPSOIL AND SEED. PROVIDE SUFFICIENT MULCH AND IRRIGATION TO ESTABLISH AND MAINTAIN A HEALTHY STAND OF GRASS UNTIL PROJECT IS ACCEPTED BY THE OWNER.

TOTAL LAND DISTURBANCE = 4.81 ACRES

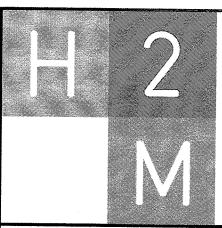

538 Broad Hollow Road, 4th Floor East Melville, NY 11747 631.756.8000 • www.h2m.com




THE LANDTEK GROUP, INC

235 County Line Rd Amityville, NY 11701 631-691-2381 631-598-8280 www.landtekgroup.com

architects

engineers

| WAIN DATE | | DESCRIPTION | | | | |
|-----------|---|-------------|--|--|--|--|
| | | | | | | |
| | | | | | | |
| | | | | | | |
| | | | | | | |
| | | | | | | |
| ····· | | | | | | |
| | | | | | | |
| | | | | | | |
| | T | | | | | |

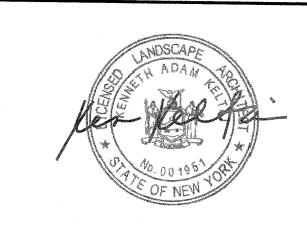

DOMINICAN COLLEGE

ATHLETIC COMPLEX SYNTHETIC TURF FIELD



470 WESTERN HIGHWAY ORANGEBURG, NEW YORK 10962

SEC. 74.06, BLOCK 3, P/O LOTS 1.1 & 1.3

CONTRACT

ALL CONTRACTS

REGULATORY REVIEW

SHEET

LANDSCAPE PLAN

APPLICANT


DOMINICAN COLLEGE
470 WESTERN HIGHWAY
ORANGEBURG, NY 10962


DRAWING No.

(845) 848-7814

O SHE

PARAWING No. C4.0

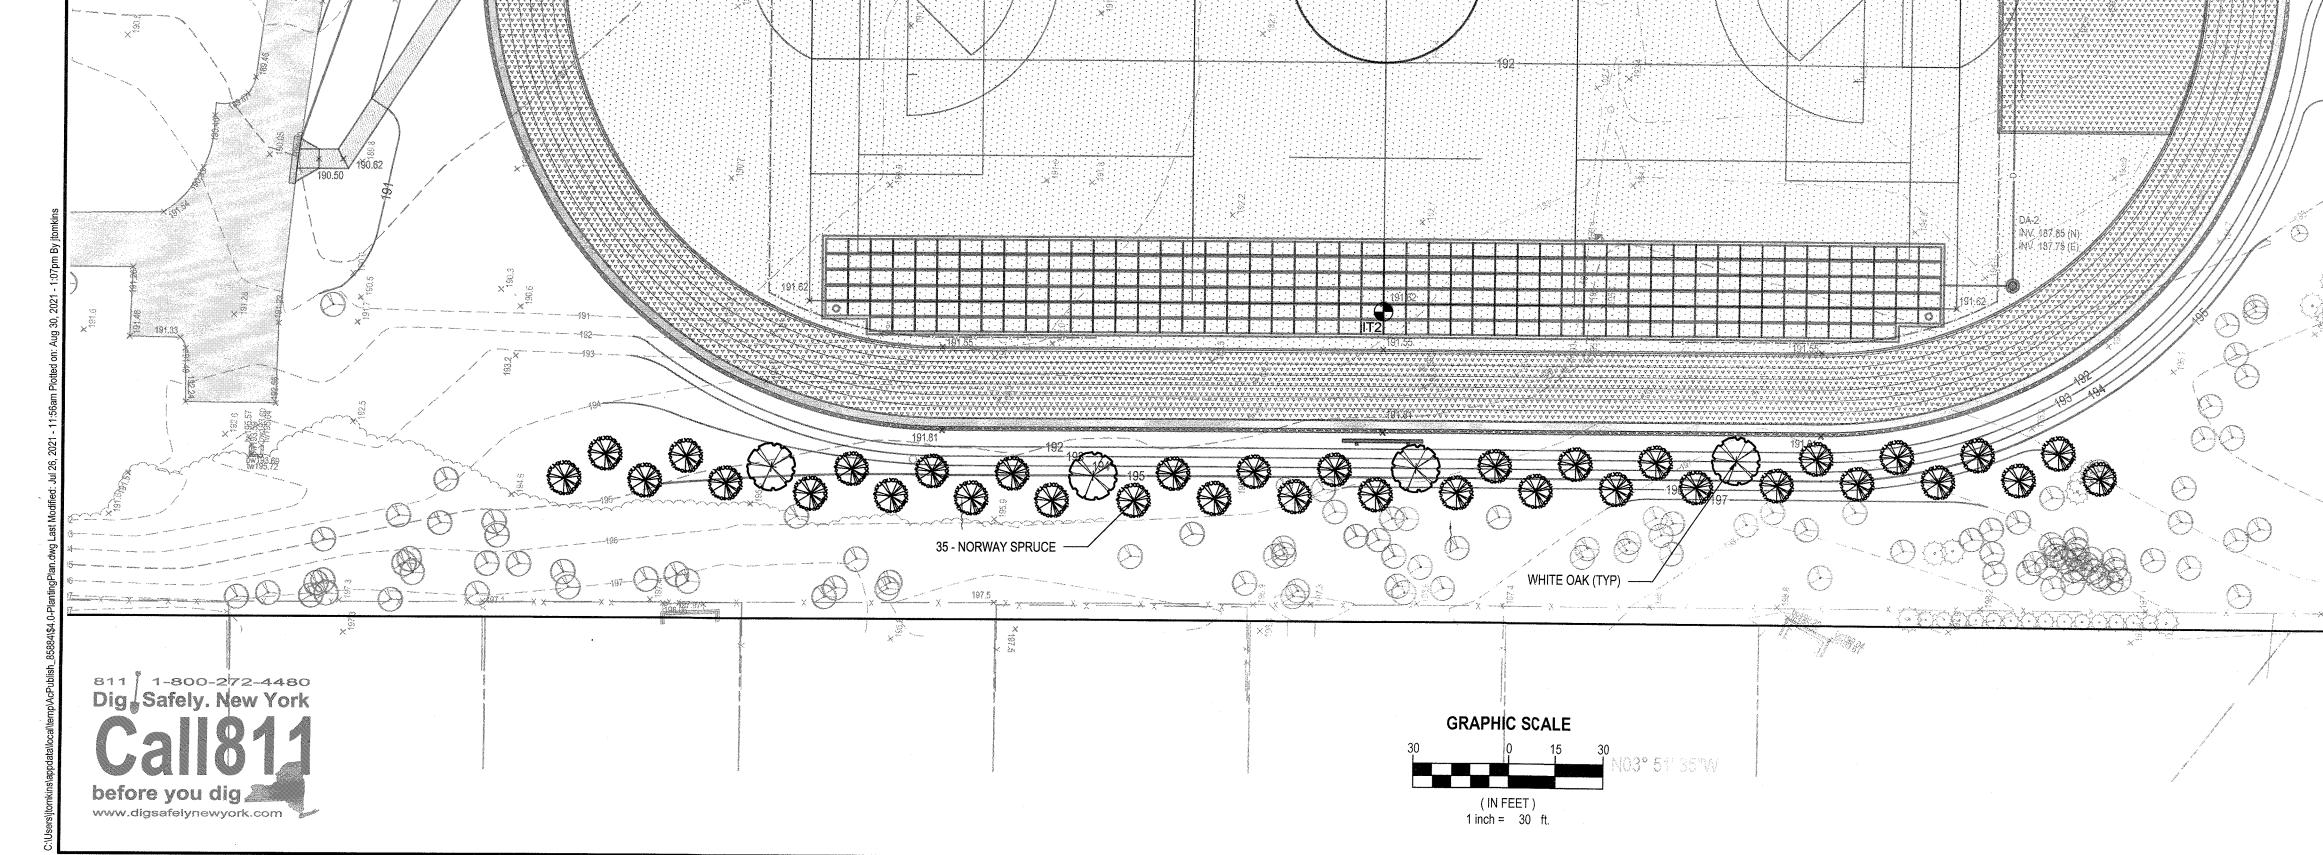

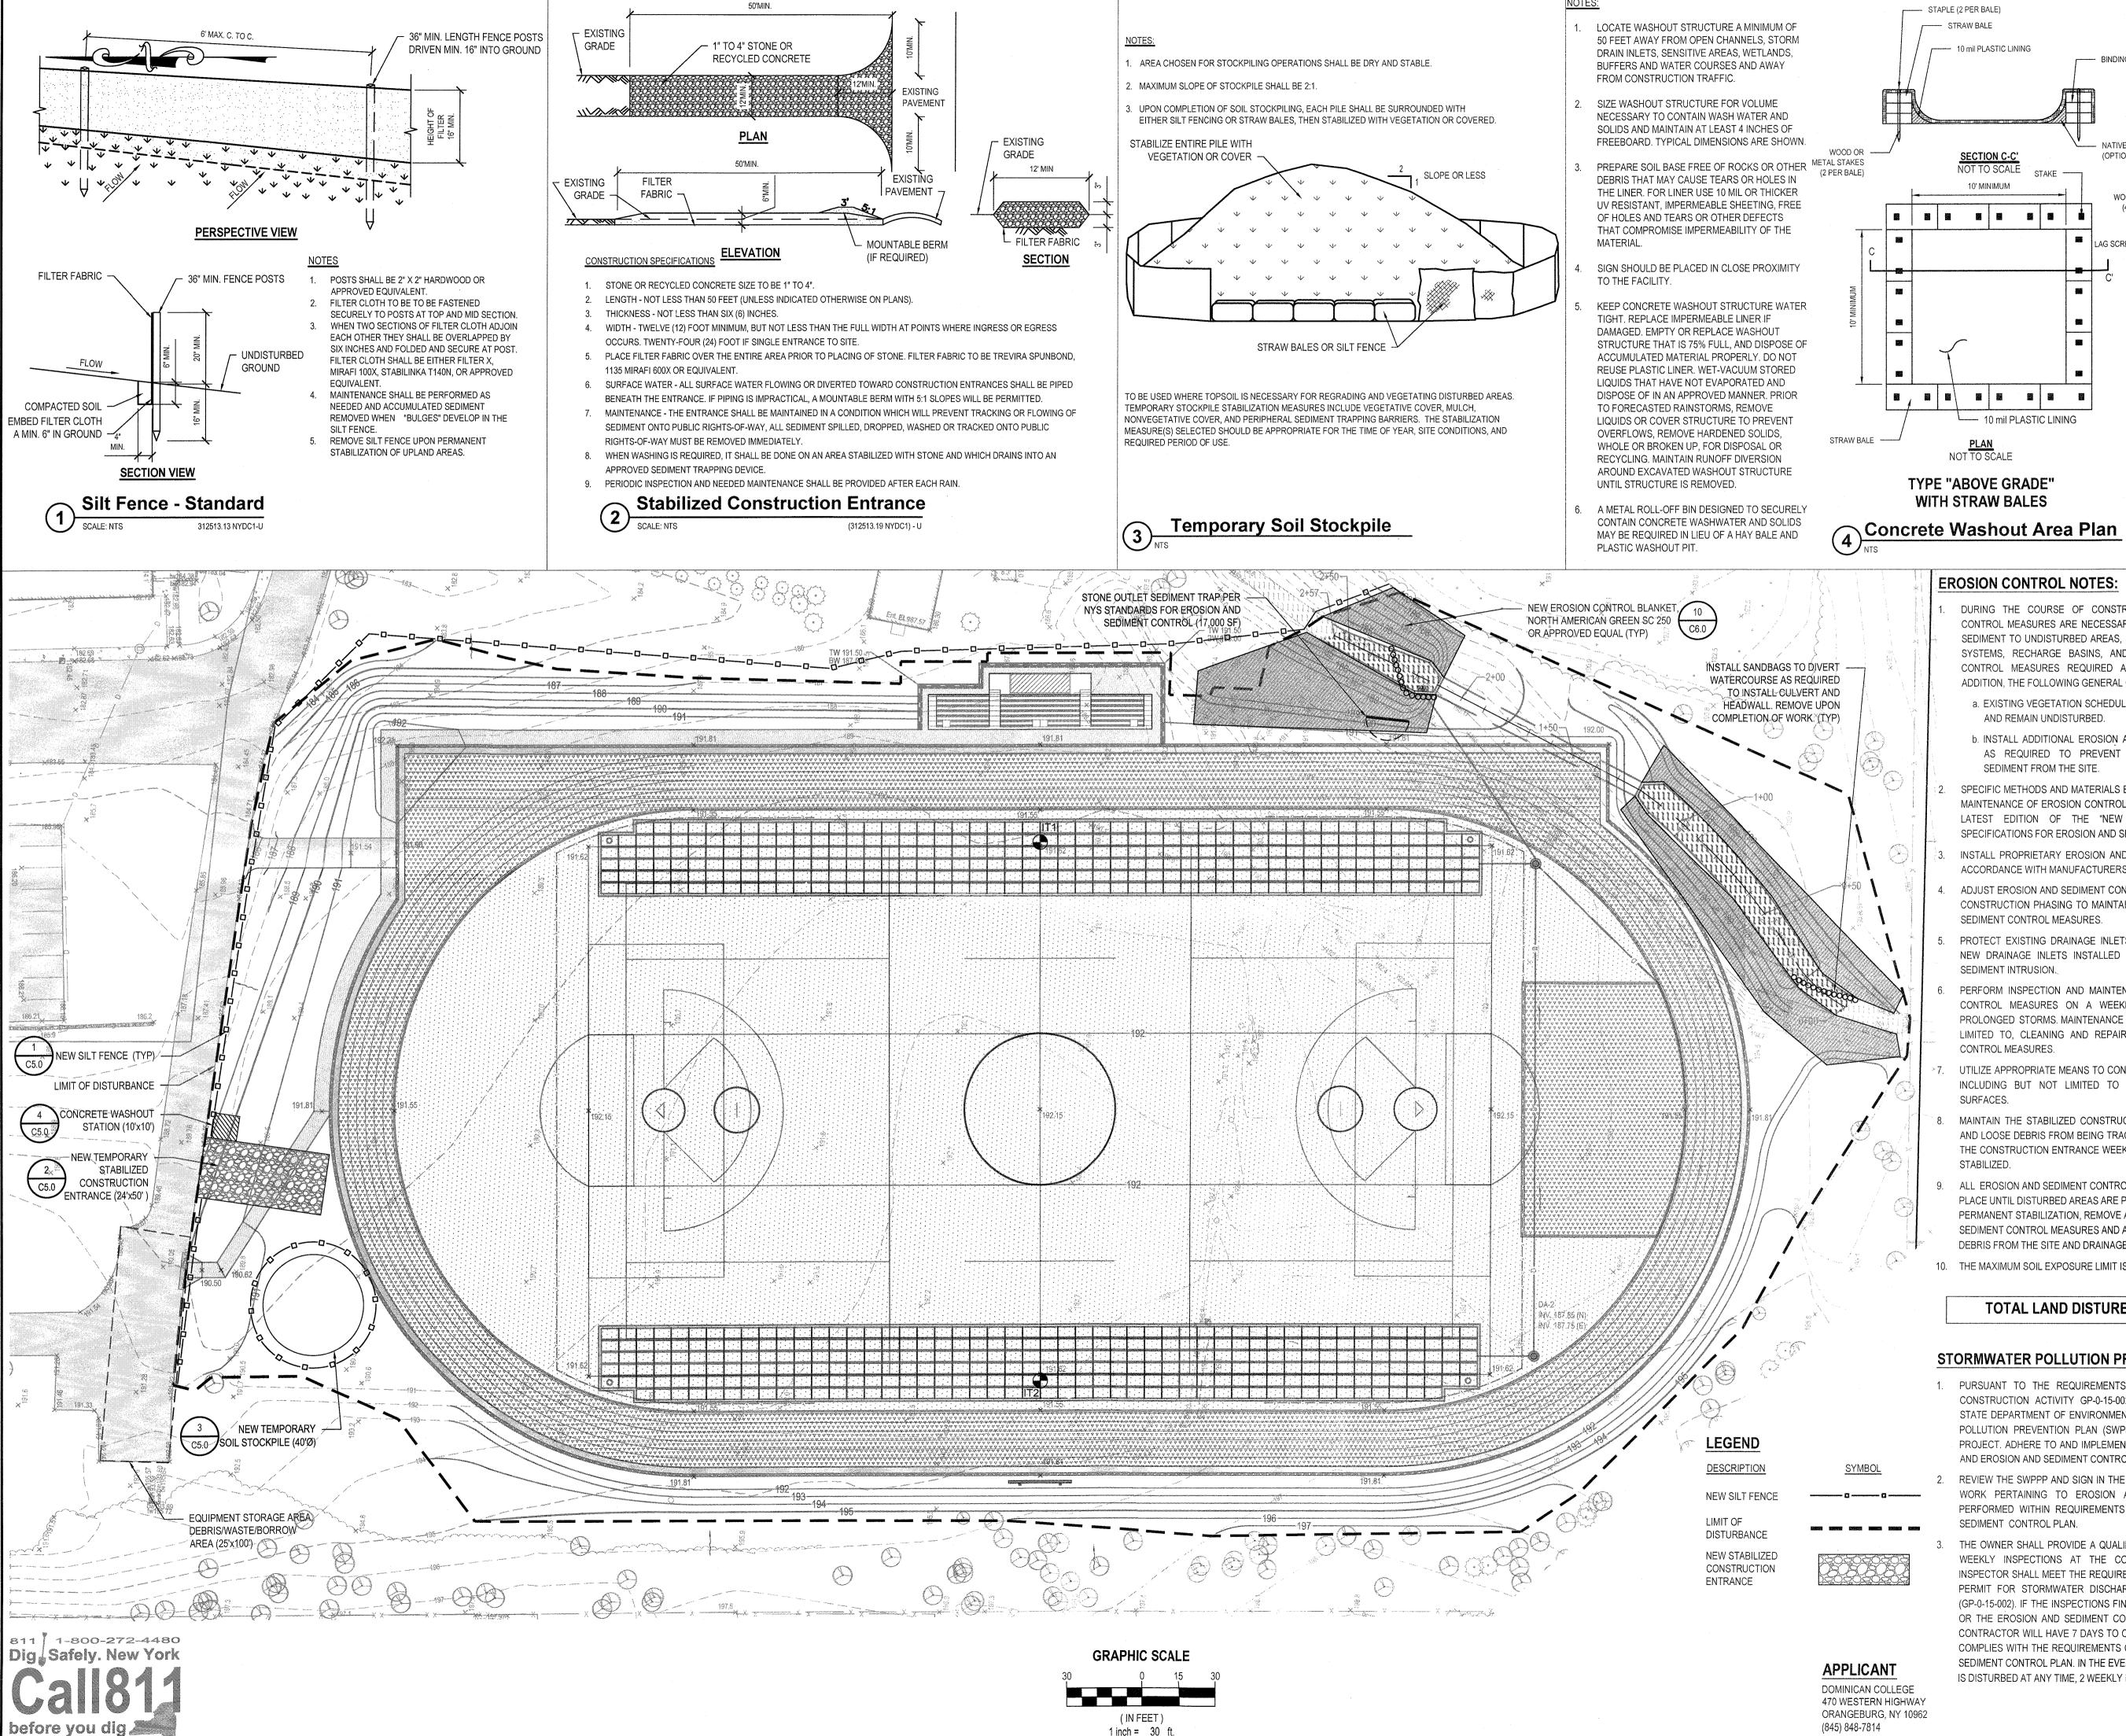

STAPLE (2 PER BALE) BINDING WIRE STAPLE DETAIL NATIVE MATERIAL BLACK LETTERS (OPTIONAL) 6' HEIGHT PLYWOOD 4' x PAINTED WHITE WOOD POST -(4' x 4' x 8') AG SCREWS -CONCRETE WASHOUT **CONCRETE WASHOU**

DURING THE COURSE OF CONSTRUCTION, EROSION AND SEDIMENT CONTROL MEASURES ARE NECESSARY TO PREVENT THE TRANSPORT OF SEDIMENT TO UNDISTURBED AREAS, PONDS, WATER COURSES, DRAINAGE SYSTEMS, RECHARGE BASINS, AND ROADS. THE MINIMUM EROSION CONTROL MEASURES REQUIRED ARE INDICATED ON THIS PLAN. IN ADDITION, THE FOLLOWING GENERAL CONDITIONS SHALL BE OBSERVED:

SIGN DETAIL

- a. EXISTING VEGETATION SCHEDULED TO REMAIN SHALL BE PROTECTED AND REMAIN UNDISTURBED.
- b. INSTALL ADDITIONAL EROSION AND SEDIMENT CONTROL MEASURES AS REQUIRED TO PREVENT THE INCIDENTAL DISCHARGE OF
- SPECIFIC METHODS AND MATERIALS EMPLOYED IN THE INSTALLATION AND MAINTENANCE OF EROSION CONTROL MEASURES MUST CONFORM TO THE LATEST EDITION OF THE "NEW YORK STATE STANDARDS AND SPECIFICATIONS FOR EROSION AND SEDIMENT CONTROL"
- INSTALL PROPRIETARY EROSION AND SEDIMENT CONTROL PRODUCTS IN ACCORDANCE WITH MANUFACTURERS INSTRUCTIONS.
- ADJUST EROSION AND SEDIMENT CONTROL MEASURES TO ACCOMMODATE CONSTRUCTION PHASING TO MAINTAIN EFFECTIVENESS OF EROSION AND
- PROTECT EXISTING DRAINAGE INLETS WITHIN THE PROJECT LIMITS AND NEW DRAINAGE INLETS INSTALLED AS PART OF THIS PROJECT FROM
- PERFORM INSPECTION AND MAINTENANCE OF EROSION AND SEDIMENT CONTROL MEASURES ON A WEEKLY BASIS AND AFTER HEAVY OR PROLONGED STORMS. MAINTENANCE MEASURES INCLUDE, BUT ARE NOT LIMITED TO, CLEANING AND REPAIR OF ALL EROSION AND SEDIMENT
- UTILIZE APPROPRIATE MEANS TO CONTROL DUST DURING CONSTRUCTION, INCLUDING BUT NOT LIMITED TO APPLYING WATER TO BARE SOIL
- MAINTAIN THE STABILIZED CONSTRUCTION ENTRANCE TO PREVENT SOIL AND LOOSE DEBRIS FROM BEING TRACKED ONTO LOCAL ROADS. MAINTAIN THE CONSTRUCTION ENTRANCE WEEKLY UNTIL THE SITE IS PERMANENTLY
- ALL EROSION AND SEDIMENT CONTROL MEASURES SHALL REMAIN IN PLACE UNTIL DISTURBED AREAS ARE PERMANENTLY STABILIZED. AFTER PERMANENT STABILIZATION, REMOVE ALL TEMPORARY EROSION AND SEDIMENT CONTROL MEASURES AND ALL ACCUMULATED SEDIMENT AND DEBRIS FROM THE SITE AND DRAINAGE STRUCTURES.
- 10. THE MAXIMUM SOIL EXPOSURE LIMIT IS 14 DAYS.

TOTAL LAND DISTURBANCE = 4.81 ACRES

STORMWATER POLLUTION PREVENTION PLAN NOTES

- 1. PURSUANT TO THE REQUIREMENTS OF SPDES GENERAL PERMIT FOR CONSTRUCTION ACTIVITY GP-0-15-002 ESTABLISHED BY THE NEW YOR STATE DEPARTMENT OF ENVIRONMENTAL CONSERVATION, A STORMWATER POLLUTION PREVENTION PLAN (SWPPP) HAS BEEN PREPARED FOR THI PROJECT. ADHERE TO AND IMPLEMENT ALL REQUIREMENTS OF THE SWPPP AND EROSION AND SEDIMENT CONTROL PLAN.
- REVIEW THE SWPPP AND SIGN IN THE LOCATION SHOWN STATING THAT ALI WORK PERTAINING TO EROSION AND SEDIMENT CONTROL WILL PERFORMED WITHIN REQUIREMENTS OF THE SWPPP AND EROSION AND
- THE OWNER SHALL PROVIDE A QUALIFIED INSPECTOR WHO WILL PERFORM WEEKLY INSPECTIONS AT THE CONSTRUCTION SITE. THE QUALIFIED INSPECTOR SHALL MEET THE REQUIREMENTS OUTLINED IN SPDES GENERAL PERMIT FOR STORMWATER DISCHARGE FROM CONSTRUCTION ACTIVIT (GP-0-15-002). IF THE INSPECTIONS FIND ANY DEVIATIONS FROM THE SWPPF OR THE EROSION AND SEDIMENT CONTROL PLAN IT WILL BE NOTED. THE CONTRACTOR WILL HAVE 7 DAYS TO CORRECT ANY DEVIATIONS SO THAT IT COMPLIES WITH THE REQUIREMENTS OF THE SWPPP AND OR EROSION AND SEDIMENT CONTROL PLAN. IN THE EVENT THAT MORE THAN 5 ACRES OF SOIL IS DISTURBED AT ANY TIME, 2 WEEKLY INSPECTIONS WILL BE PERFORMED.

architects

538 Broad Hollow Road, 4th Floor East Melville, NY 11747 631.756.8000 • www.h2m.com



THE LANDTEK GROUP, INC 235 County Line Rd

Amityville, NY 11701 631-691-2381 631-598-8280 www.landtekgroup.com

MARK | DATE DESCRIPTION



LGTR 2001 AUG. 30, 2021 AS SHOWN

DOMINICAN COLLEGE

ATHLETIC COMPLEX SYNTHETIC TURF FIELD



470 WESTERN HIGHWAY ORANGEBURG, NEW YORK


SEC. 74.06, BLOCK 3, P/O LOTS 1.1 & 1.3


ALL CONTRACTS


REGULATORY REVIEW


EROSION AND SEDIMENT CONTROL PLAN

C5.0

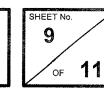

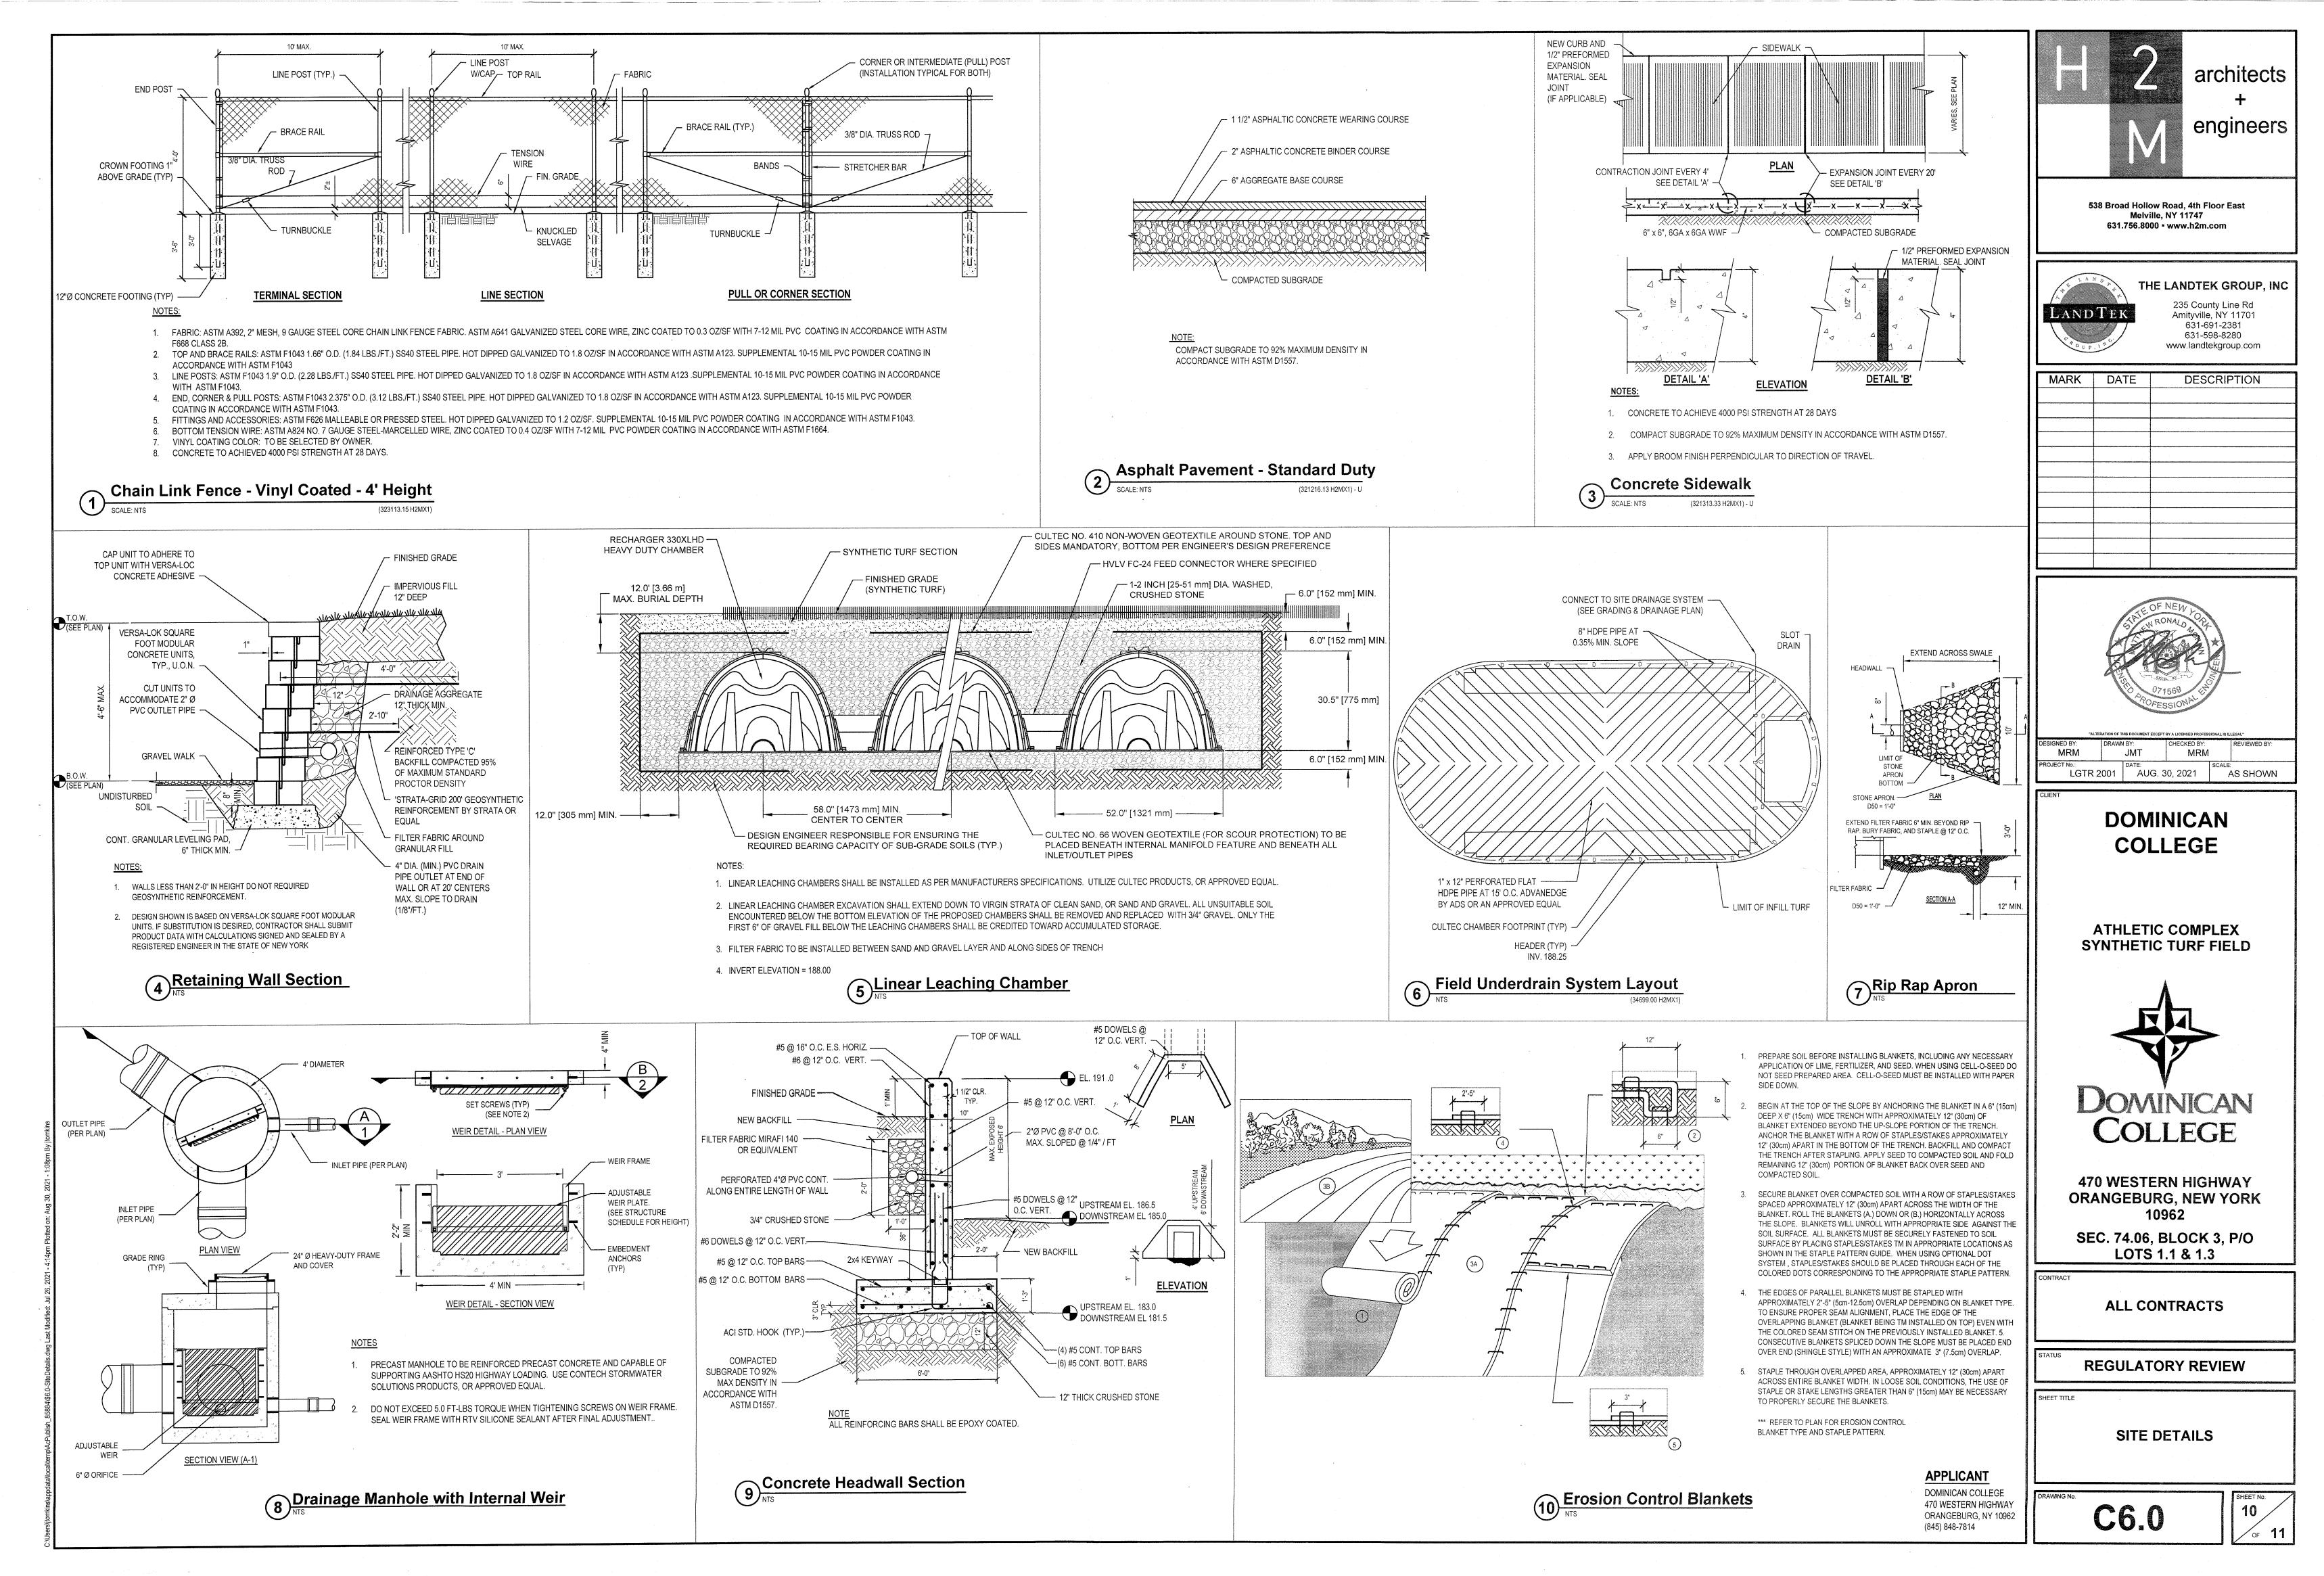

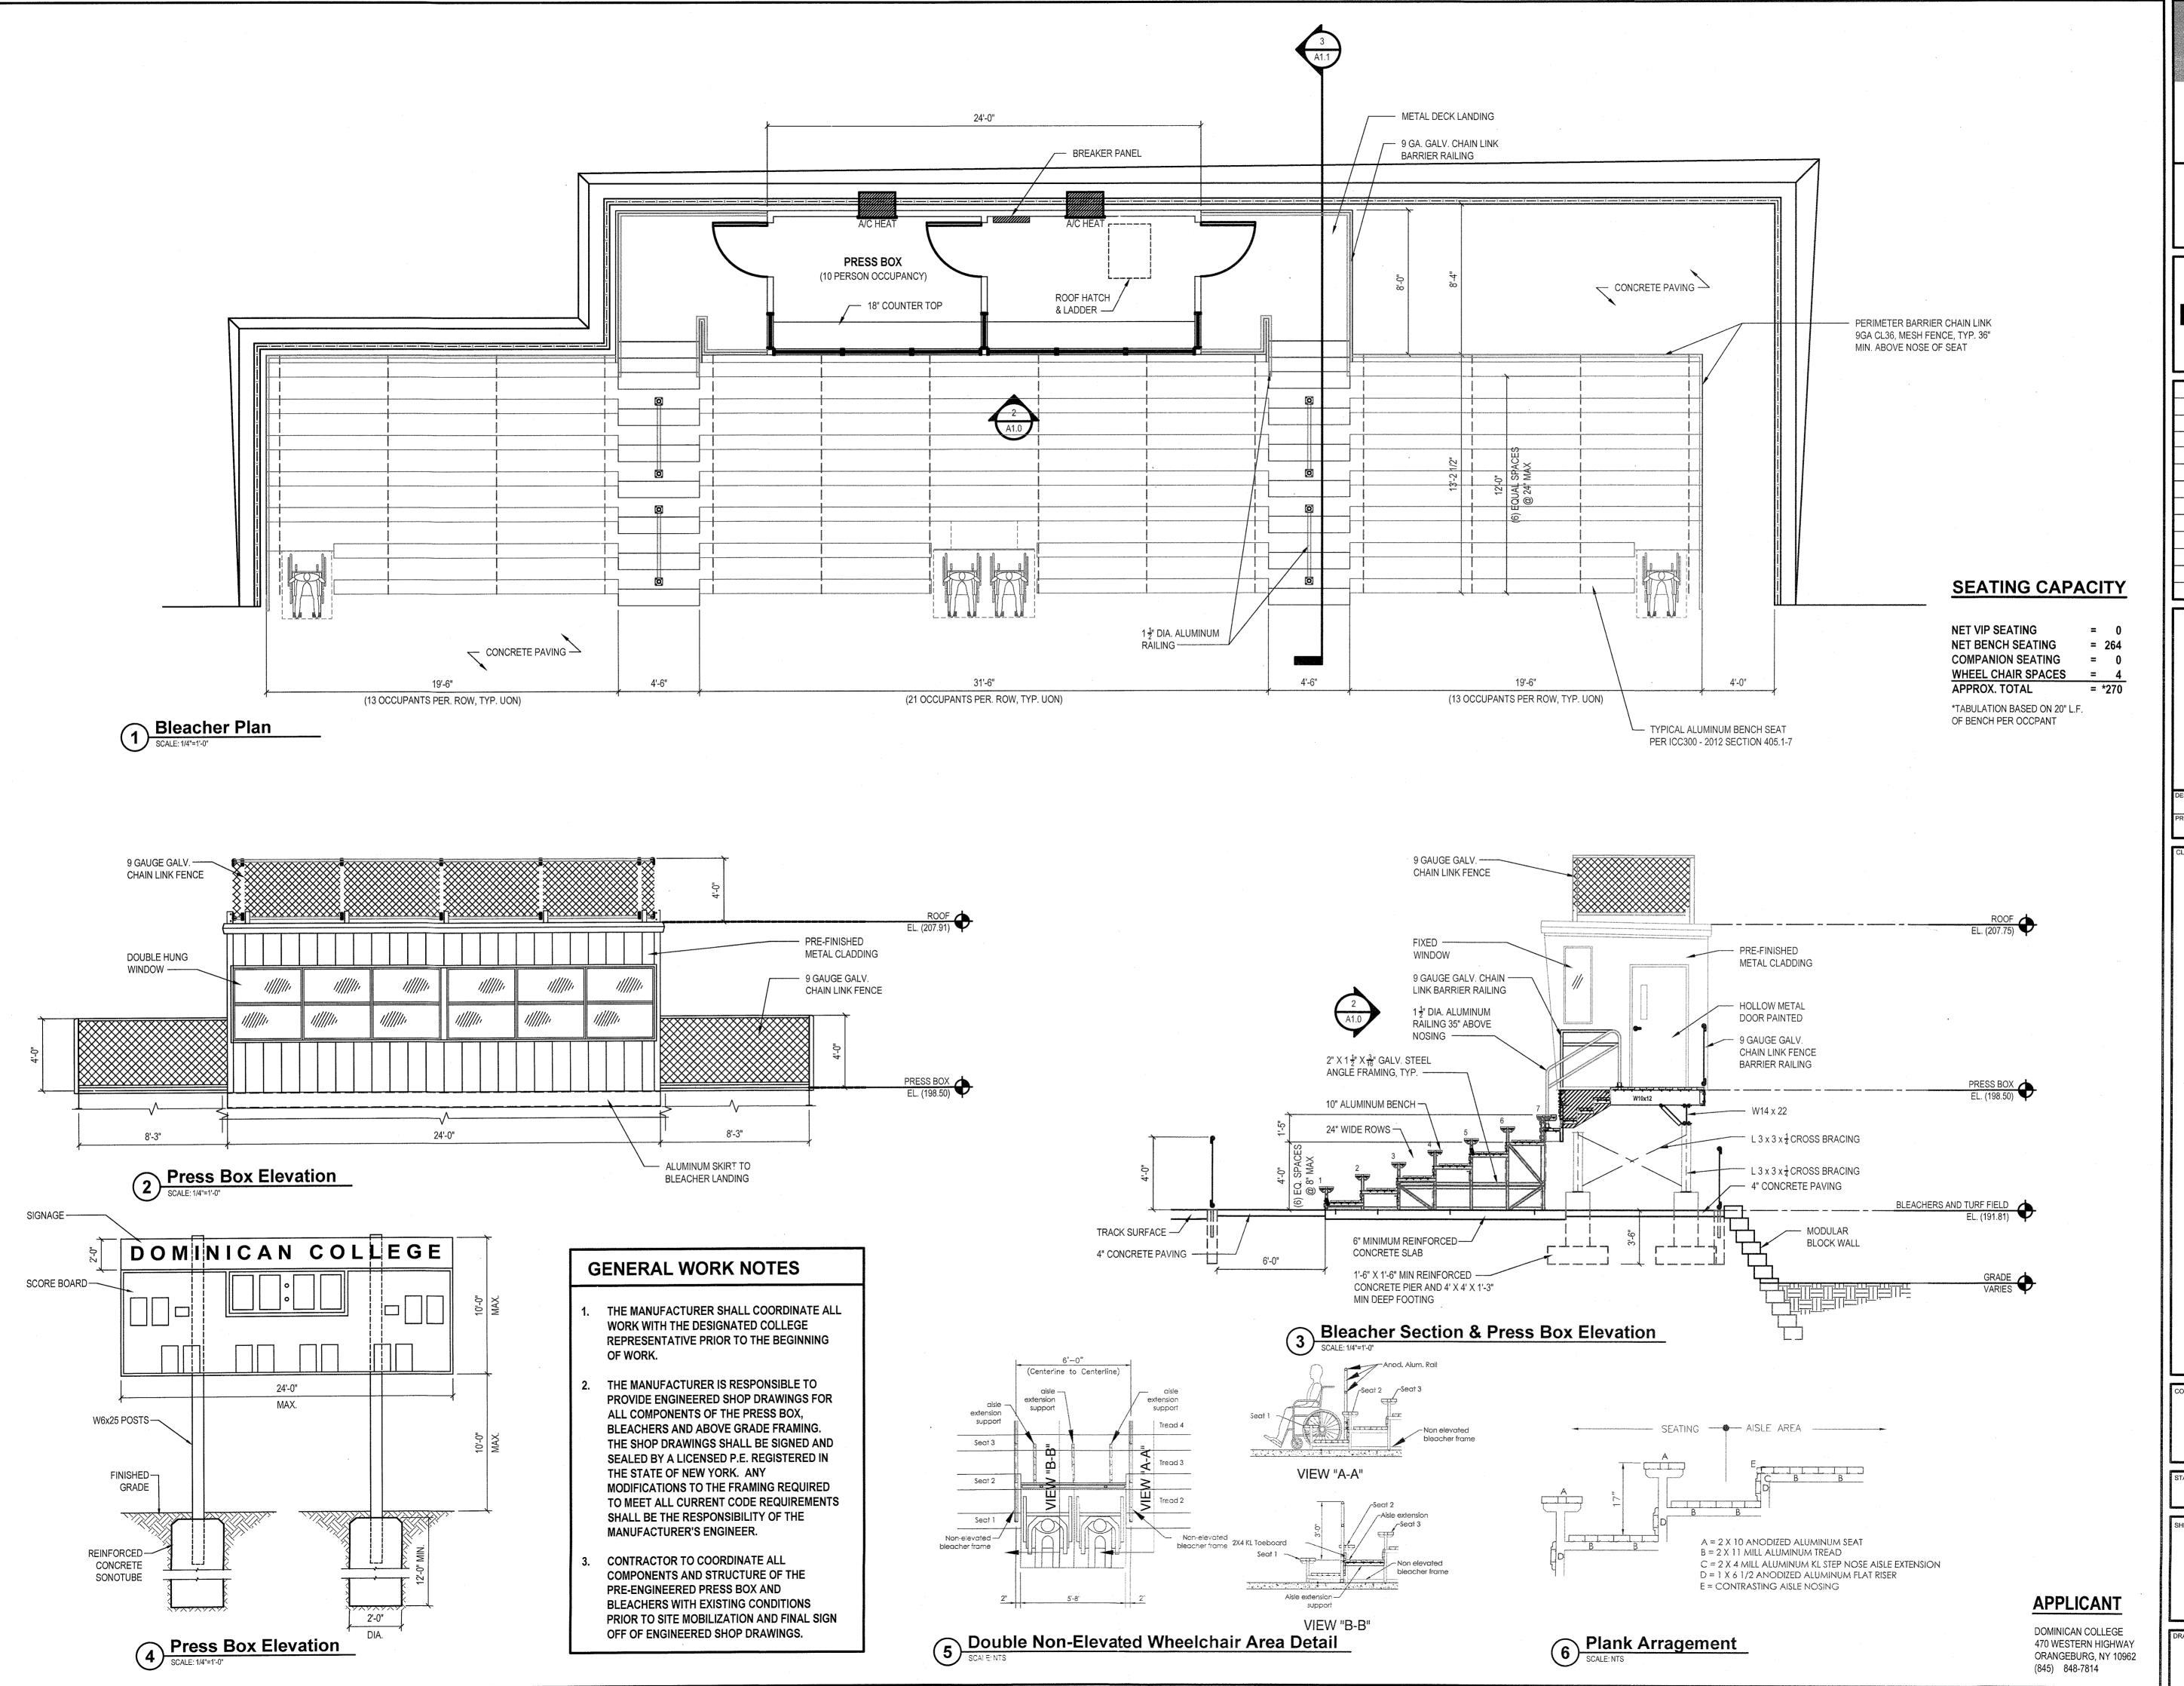

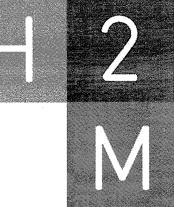

+ engineers


538 Broad Hollow Road, 4th Floor East
Melville, NY 11747
631.756.8000 = www.h2m.com



THE LANDTEK GROUP, INC

235 County Line Rd Amityville, NY 11701 631-691-2381 631-598-8280 www.landtekgroup.com

| l | MARK | DATE | DESCRIPTION |
|-------------------|--|------|-------------|
| I | | | |
| İ | | | |
| ı | ~~~~~~~~~~~~~~~~~~~~~~~~~~~~~~~~~~~~~~ | | |
| ı | | | |
| | | | |
| | | | |
| | | | |
| | | | |
| | | | |
| A county faither. | | | |
| Sept. | | | |

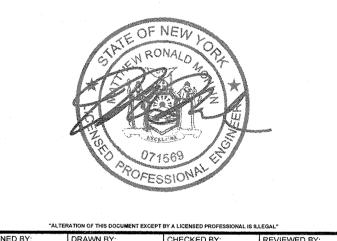

| "ALT | "ALTERATION OF THIS DOCUMENT EXCEPT BY A LICENSED PROFESSIONAL IS ILLEGAL" | | | | | | | | |
|---------------------------|--|---------------|-------------|--------------------|--------------|--|--|--|--|
| DESIGNED BY: MRM | DRAWN | JMT | CHECKED BY: | 1 | REVIEWED BY: | | | | |
| PROJECT No.: LGTR 2001 | | AUG. 30, 2021 | | SCALE: AS SHOWN | | | | | |

DOMINICAN COLLEGE

ATHLETIC COMPLEX SYNTHETIC TURF FIELD



470 WESTERN HIGHWAY ORANGEBURG, NEW YORK 10962

SEC. 74.06, BLOCK 3, P/O LOTS 1.1 & 1.3

CONTRACT

SINGLE CONTRACT

REGULATORY REVIEW

BLEACHER SITE PLAN, SECTION, AND ELEVATIONS

C7.0

SHEET No. 11