Historical Areas Board of Review(HABR)

Town of Orangetown Building Department 20 Greenbush Road, Orangeburg, New York 10962

PROPERTY ADDRESS: 200 KHGS HIGHWAY Section/Block/Lot: 77.07 / 1/35

- 1. Provide a narrative summary explaining the project and including any facts pertaining to this project which applicant feels would be of interest to the Board:
- 2. Architectural Plans:
- 3. It is preferable to the HABR if the Architect would appear at the meeting with the Applicant.

4. Please bring SAMPLES of building materials to the meeting. 5. Materials checklist: (please provide the brand name, type, style, model and color numbers): COLOR MATERIAL MANUFACTURER ASPHALT OYSTEL GIVEY GAF HDZ MCH, SHINGIF METAL Roof: ARTIC WATTE FIBER CEMENT Sidina: JAMES HARDIE ALH **Decorative Siding:** Soffits & Fascia: JAMES HARDE WHITE 11/11/ Gutters & Leaders: FREEDOM GRAV METAL BERGER COMPANY WHITECLAD ANDERSON COMPAN Windows: MLKIN WHITE Trim: METAL BERGER COMPANY Alh Shutters: WALNUT Front Door: ANDERSON WOOD WALNUT Back Door: MODD MOEREALA WHITE Garage Door(s): CLOPAY STEEL WHITE Other Door(s): CLAD VINYL ANDERSON BARN LIGHT METAL Lighting: BLACK ELEGIZIC COMPANY BLACK/RUST ALUMINUM Lighting: TROY LIGHTING (DRIVEWAY) Stone or Rock being GRAY, MEDIUM FIELDSTONE HANRAL used on Structure: Stone or Rock being used on walkway(s): POST SPLIT RAIL NATURAL WOOD FENCE Other:

Name of Municipality: TOWN OF ORANGETOWN

Date Submitted: 095 T 202

2021 LAND USE BOARD APPLICATION

	Please check	all that apply:]
	Commercial Planning Board Zoning Board of Appeals	Residential Historical Board Architectural Board	
	Subdivision Number of Lots Site Plan Conditional Use Special Permit Variance	Consultation Pre-Preliminary/Sketch Preliminary Final Interpretation PERMIT#: 51836	
	Performance Standards Review Use Variance Other (specify):	ASSIGNED INSPECTOR: Y W Referred from Planning Board: YES) NO If yes provide date of Planning Board meeting: TBT	
Project Name:	HAUSER RESIDEN	CE	
Street Address	ZOD KINGS HIGH TAPPAN NY I	WAY 0983	
		Lot(s): 35, Lot(s):	
Directional Lo	cation:		
On the WE 135 Town of Orange	feet NOCH of the interse	ction of OLD MILL LANE,	tely in the
School E Ambulan	of Parcel3.0\ District_60UTH_0RAN(FIDW) Ince District_60A C Strict_60EZ	Zoning District R-15 Postal District TAPPAN Fire District TAPPAN Sewer District ORANCETDI	×/N
RESTORE THE E) BEEN ABAUMON FI	USTING RESIDENTIAL DUE OR THE LAST 2D+ YEARS	. THE BESTORATION WORK WILL	HICH HAVE
	TIDN AND REPLACED WITH agrees to an extension of the statutory to 202 Applicant's Signature:	me limit for scheduling a public hearing.	1

APPLICATION REVIEW FORM

FILL IN WHERE APPLICABLE. (IF THE FOLLOWING DOES NOT APPLY PLEASE MOVE ON TO THE NEXT PAGE)

If subdi	ivis	ion:						
	1)	Is any variance from the subdivision regulations required?						
	2) Is any open space being offered? If so, what amount?							
	3)	Is this a standard or average density subdivision?						
If site p	lan							
	1)	Existing square footage 4345						
		Total square footage 8799						
	3)	Number of dwelling units						
lf speci	al p	ermit, list special permit use and what the property will be used for.						
Emailman								
Enviror	ıme	ntal Constraints:						
and net ar	ea	es greater than 25%? If yes, please indicate the amount and show the gross						
Are there	stre	ams on the site? If yes, please provide the names. SHARKIU CREEK						
Are there	wetl	ands on the site? If yes, please provide the names and type:						
Project	His	storv:						
-		et ever been reviewed before?NO						
		narrative, including the list case number, name, date, and the board(s) you appeared						
		e status of any previous approvals.						
List tax ma	ap se	ection, block & lot numbers for all other abutting properties in the same ownership as						
this projec		/ 4						
		N/A						



OFFICE OF BUILDING, ZONING, PLANNING, ADMINISTRATION AND ENFORCEMENT TOWN OF ORANGETOWN

20 Greenbush Road Orangeburg, N.Y. 10962

Jane Slavin, R.A. Director

(845)359-8410

Fax: (845) 359-8526

		Referra	ıl to the P	lanning Bo	ard					
	Date: August 20, 2021	Section:_	77.07	Block: 1		Lot:	35	_		
	Applicant: Joseph Haus	er								
	Address: 200 Kings H	ighway, T	appan, NY							
	RE: Application Made at:	same								
residence sit within the Cr graded, filled Planning Boc contours; lot the lot clearin development any other rec Planning Boc involved in the lot of the lo	land in the Town of Orangetow uated on a lot no greater than the itical Environmental Area, in act, excavated, stripped of topsoil and renders its final decision of clearing and grading limit lines in acct of the property; and such othe quirements, the Planning Board and may request the advice and the parcel of land by reason of the parcel. Addition to existing	wice the mining cordance with, land cover or approval. The the location of ordance with a mill require column assistance of the proposed of	num lot area per the provisions or otherwise disturbance plan shall show of all existing may \$ 21-25 of this cas may be necessary and the fall other depart learing operation	rmitted in the zoni of the Zoning Cod urbed from its natur v the area propose ajor trees and prop shapter; the locatic ssary for the Boar all the provisions of tments and agence	ng district in wi e[2] of the Tow real state until ad to be disturb bosed trees in t on of all stream d to properly co of Section 4.32 ies of Town go	hich it is lown of Oranga plan is sured, with each of the development on sider the (C) of the lown of	pecated and getown shoubmitted to existing and epment are ercourses e applicate Zoning Co	d not located hall be cleared o and the d proposed fin ea as shown b s; proposed fin ion. In addition ode. The	al y al i to	
	Joe Hauser :								,	
Please to the bottom	be advised that the Buildin Orangetown Planning Board the reason for referral. The ation necessary to appear be persmith@orangetown.com	d. I have end e Clerk to the	closed a Xero: e Planning Bo	x copy of your a ard, Cheryl Cod	pplication, wo persmith, wi	here you Il assist y	ı will fin you in th	d at the		2
	Sincerely,			. •				SEP TOWN OF LAND	9 2021 ORANGETON JSE BOARDS	WN S
		1/				/	/			

Signature of Director

NOTE: PLEASE KEEP FOR YOUR RECORDS 8-12-20-CCC

CC:

Liz Decort

Cheryl Coopersmith

HAUSER RESIDENCE 200 KINGS HIGHWAY TAPPAN, NEW YORK, 10983



CONSULTATION APPEARANCE, OCTOBER 4, 2021

BRIEF PROJECT DESCRIPTION:

Restore the existing residential dwellings (original dwelling circa 1780, addition 1927) which have been abandon for the last 20+years. The restoration work will include selective interior and exterior demolition. The demolished areas will be replaced with new work including the kitchen, garage, pool, driveway and landscaping. A new in-law addition is also planned. All the existing utility services need to be replaced from the street to the house too, i.e., water, sewer, gas, electric and cable.

PLANNED ADDITIONAL RESTORATION DETAIL AND INFORMATION:

The exterior color palates are white and gray with a complimenting natural field stone wainscot.

The horizontal and vertical exterior siding is a fiber cement product manufactured by the James Hardie Company. The finish is Cedarmill and the color is Artic White. The thickness is 0.312" and the exposure is 7".

The windows and doors are manufactured by the Anderson Windows & Doors Company. Their product 400 series number are white vinyl clad with '4 over 4' grilles.

The skylights are manufactured by the Velux Company, white clad vinyl exterior.

The roof asphalt shingles are manufactured by the GAF company, their HDZ architectural series in the Oyster Gray color.

The raised seem metal roof is manufactured by the Drexel Metals Company, product number 100NS and the color is Zinc.

The gutters and downspouts are manufactured by the Berger Company. The gutter is a $\frac{1}{2}$ round style and 5" in size. The downspouts are round and sized to fit the gutter. The color for both the gutters and downspouts is Freedom Gray. The downspouts terminate as shown on the Plot Plan and are located accordingly.

The exterior mechanical equipment is a Daikin High Efficiency Heat Pump, model number RXTQ60TAVJUA and tentatively located by the Bilco door on the Left Side (South Façade).

TAX MAP REFERENCE: SECT. 77.07, BLK. I, LOT 35

REFERENCES:

A MAP ENTITLED "OLD MILL PARK" PREPARED BY WILLIAM A. YUDA, P.C. AND FILED IN THE ROCKLAND COUNTY CLERK'S

OFFICE ON JUNE 7, 1955 AS MAP NUMBER 2354.

L. 468, P. 353 (PIQ)

INST. #2007-18071 (PIQ)

L. 588, P. 198

L. 863, P. 83

L. 256, P. 1994 L. 428, P. 33

L. 105, P. 730

L. 1014, P. 296 INST. #2001-42017

INST. #2006-12748 INST. #2009-20744

NO. TI T2 T3 T4 T5 T6 T7 T8 T9 T10 T11 T12 T13	DIAMETER 12" 56" 24" 28" 16" TWIN 56" 30" 22" 46"	SPECIES YEW CHESTNUT MULBERRY MAPLE MAPLE CHERRY WALNUT	NO. T74 T75 T76 T77 T78	24" 40" 24" 8"	SPECIES ELM WALN WALN
TI T2 T3 T4 T5 T6 T7 T8 T9 T10 T11 T12 T13	12"	YEW CHESTNUT MULBERRY MAPLE MAPLE CHERRY WALNUT	T74 T75 T76 T77 T78	24" 40" 24"	ELM WALN
T2 T3 T4 T5 T6 T7 T8 T9 T10 T10 T11 T12	24" 28" 16" TWIN 36" 30" 22" 46"	MULBERRY MAPLE MAPLE CHERRY WALNUT	T76 T77 T78	24"	WALN
T3 T4 T5 T6 T7 T8 T9 T10 T11 T12 T13	24" 28" 16" TWIN 36" 30" 22" 46"	MULBERRY MAPLE MAPLE CHERRY WALNUT	T76 T77 T78	24"	
T4 T5 T6 T7 T8 T9 T10 T11 T12 T13	28" 16" TWIN 36" 30" 22" 46"	MAPLE MAPLE CLIERRY WALNUT	T77		
T5 T6 T7 T8 T9 T10 T11 T12 T13	16" TWIN 36" 30" 22" 46"	MAPLE CHERRY WALNUT	T78		OAK
T6 T7 T8 T9 T10 T11 T12 T13	36" 30" 22" 46"	CHERRY WALNUT	1	40"	WALN
T7 T8 T9 T10 T11 T12 T13	30" 22" 46"	WALNUT			
T8 T9 T10 T11 T12 T13	22" 46"		T79	20"	OAK
T9 TI0 TII TI2 TI3	46"		T80	14"	MAPL
TIO TII TI2 TI3		TULIP	T8I	10"	ELM
TII TI2 TI3		TULIP	T82	30"	OAK
TI2 TI3	8"	MAPLE	T83	12"	MAPL
TI3	20"	BIRCH	T84	8"	MAPL
	24"	MAPLE	T85	24"	BEEC
· 1	14"	MAPLE	T86	18"	BEEC
TI4	28"	A5H	T87	48"	BEEC
TI5	16"	ĒLM	T88	12"	BEEC
TI6	26"	ASH	T89	30"	TULI
TI7	24"	LOCUST	T90	24"	BIRCL
TI8	16"	MAPLE	T91	50"	BEECI
TI9	12"	OAK	T92	36"	BIRCL
T20	40"	LOCUST	T93	30"	BIRCL
TZI	28"	MAPLE	T94	10"	BEEC
T22	36"	MAPLE	T95	10"	BEEC
T23	50"	BASSWOOD	T96	36"	ASH
T24	12"	MAPLE	T97	18" TWIN	OAK
T25	18"	MAPLE	T98	36"	BEEC
T26	26"	MAPLE	T99	60"	OAK
				36"	
T27	40"	OAK	TIO	24"	OAK OAK
T28	22"	MAPLE	TIOI		OAK2
T29	60"	TULIP	TIO2	24"	OAK
T30	28"	MAPLE	T103	18"	MAPL
T3I	10"	MAPLE	TIO4	10"	MAPL
T32	20"	MAPLE	TI05	14"	MAPL
T33	40"	TULIP	T106	14"	MAPL
T34	26"	MAPLE	T107	16"	ELM
T35	18"	MAPLE	TI08	28"	BEEC
T36	26"	MAPLE	T109	40"	MAPL
T37	24"	MAPLE	TIIO	18"	MAPL
T38	10"	MAPLE	TIII	12"	OAK
T39	46"	TULIP	TII2	10"	BIRCL
T40	20"	MAPLE	TII3	36"	OAK
T41	50"	TULIP	TII4	12"	MAPL
T42	40"	CHERRY	TII5	44"	OAK
T43	8"	OAK	TII6	40"	OAK
T44	36"	MAPLE	TII7	16°	MAPL
T45	50"	TULIP	TII8	26"	OAK
T46	20"	WALNUT	TII9	20"	OAK
T47	22"	MAPLE	TI20	30"	WALN
T48	12"	£LM	TI2I	24"	MAPL
T49	12"	MAPLE	TIZZ	30"	PINE
T50	26"	MAPLE	TI23	22"	BEEC
T51	8"	OAK	TI24	10"	BEEC
T52	12"	£LM	TI25	24"	OAK
T53	6"	MAPLE	TI26	16"	BIRCL
T54	28"	WALNUT	TI27	24"	MAPL
T55	16"	CHERRY	TI28	IO"	BEECI
T56	30"	MAPLE	T129	24"	OAK
T57	14"	MAPLE	T130	60"	OAK
T58	28"	MULBERRY	T131	40"	MAPL
T59	12"	MAPLE	T132	10"	ELM
T60	10"	MAPLE	T133	40"	CLIERF
	16"	MAPLE	TI34	48"	OAK
T61			1		
T62	40"	WALNUT	TI35	40"	OAK
T63	14"	MAPLE	T136	14"	OAK
T64	18"	LOCUST	TI37	20"	CHERR
T65	16"	LOCUST	TI38	10"	TULI
T66	36"	LOCUST	TI39	36"	BIRCL
T67	30"	LOCUST	TI40	24"	BIRCL
T68	12"	MAPLE	TI4I	30"	BIRCL
T69	12"	MAPLE	T142	30"	BIRCL
T70	22"	TULIP	T143	24"	MAPL
T7I	28"	TULIP	TI44	20"	BIRCL
T72	24"	CEDAR	T145	20"	BIRCL

LEGEND						
EXISTING	PROPOSED	ITEM5				
	(** **********************************	PROPERTY LINE				
		BUILDING SETBACK LINE				
5		SANITARY SEWER				
S		SAN. SEWER MANHOLE				
H5		SEWER SERVICE				
Oco	Oco	CLEAN-OUT				
——им——		WATER MAIN				
W5		WATER SERVICE				
wv ×	×X	WATER VALVE				
45	45	GAS SERVICE				
GV X	ev ⊠	GAS VALVE				
		DRAIN PIPE				
		CATCH BASIN				
	RL	ROOF LEADER				
þ		UTILITY POLÉ				
	—-Tt.c—	UNDERGROUND ELECTRIC, TELE: CABLE				
OHE		OVERHEAD ELECTRIC				
<u>—500</u>	80	10' CONTOUR INTERVAL				
<u>502</u>	74	2' CONTOUR INTERVAL				
+ 501.3	+74.5	SPOT GRADE				

ALL UTILITIES ARE SHOWN IN AN APPROXIMATE WAY FROM AVAILABLE INFORMATION. THE CONTRACTOR SHALL CALL THE LOCAL UNDERGROUND FACILITIES PROTECTIVE ORGANIZATION TO HAVE ALL UNDERGROUND UTILITIES MARKED IN THE FIELD PRIOR TO ANY CLEARING OR ANY CONSTRUCTION. THE CONTRACTOR SHALL ALSO VERIFY THE LOCATION, SIZE AND INVERT OF ALL UTILITIES PRIOR TO ANY CONSTRUCTION. ANY UTILITY FOR WHICH NO EVIDENCE CAN BE SEEN ON THE SURFACE OF THE LANDS MAY NOT BE SHOWN ON THIS DRAWING.

16 NYCRR PART 753
REQUIRES 2 WORKING DAYS NOTICE PRIOR
TO START OF ANY UNIDERGROUND WORK DIG SAFELY NEW YORK 1-800-962-7962

BULK TABLE

ZONE: R-15 GROUP: M	MINIMUM LOT AREA	LOT WIDTH (FEET)	FRONT YARD (FEET)	SIDE YARD (FEET)	TOTAL SIDE YARD (FEET)	REAR YARD (FEET)	STR LL T FRONTAGE (FLET)	FLOOR AREA RATIO (FAR)	MAXIMUM BUILDING HEIGHT
REQUIRED	15,000	100	30	20	50	35	75	0.20	30
EXISTING	120,504	155.9	295	50	158	279	155.57	0.04	<30
PROPOSED	120,504	155.9	288	50	102	245	155.57	0.08	<30
/ARIANC E									

NET LOT AREA CALCULATION: 50% DEDUCTION FOR 100 YEAR FLOOD PLAIN 15,164 S.F. / 50% = 7,582 S.F.

50% DEDUCTION FOR FOR SLOPE AREAS OVER 25% 9,502 S.F. / 50% = 4,751 S.F. GR055 LOT AREA - TOTAL DEDUCTION = NET LOT AREA 132,837 S.F. - 12,333 S.F. = 120,504 S.F.

FLOOR AREA RATIO CALCULATIONS:

GROSS FLOOR AREA / LOT AREA = FAR.

EXISTING: 4,345 S.f. / 120,504 S.f. = 0.0361 (0.04) 8,799 S.f. / 120,504 S.f. = 0.0730 (0.08) IMPERVIOUS SURFACE EXISTING 9,126 S.F. PROPOSED 16,078 S.F. INCREASE 6,952 S.F.

AREA OF DISTURBANCE 43,084 S.F.

PLOT PLAN (SHEET I)

200 KINGS HIGHWAY LOCATED IN TOWN OF ORANGETOWN DECEIVED ROCKLAND COUNTY, NEW YORKECEIVED

SEP 9 2021 TOWN OF ORANGETOWN

SPARACO & YOUNGBLOOD, PLLC & YB-6621 CIVIL ENGINEERING * LAND SURVEYING
SITE PLANNING

STEVEN M. SPARACO, PE 18 NORTH MAIN STREET


HARRIMAN, NEW YORK 10926 (845) 782-8543


IB NORTH MAIN STREET
P.O. BOX 818
HARRIMAN, N.Y. 10926
TEL: (845) 782-8543
FAX: (845) 782-5901
SPARACO.STEVE@SELSNY.COM WDYLS1@GMAIL.COM


AUG. 5, 2021


YB-6621

90	77.07-1-36 N/F STOUCHTON	
546°20'00 E LONG NAIL SET LOT AREA A=132,837 S.F.	#1 IO' DRYWELL IO' DEEP WITH CURB INLET RIM 74.9 TOP CONC. 74.1 INV 6" RL 71.6 INV 12" 9 CONN 65.5 BOTTOM 64.3 REQUIRED SETBACK 09 T89 T13 T13 T13 T13 T13 T13 T13 T1	#2 IO'S DRYWELL IO' DEEP WITH OVERFLOW CRATE RIM 74.8 TOP CONC. 74.1 INV 12"S CONN 65.5 BOTTOM 64.5 T26 ST2 23 20 5 723 T26 ST2 23 20 5 723 T26 ST2 23 20 5 723
= 3.0495 ACRES	T86 BULLNOSE @ HNLET PROTECTION T2.9, L=10' RIM 75.0 PROPOSED PROPOSED PROPOSED PROPOSED A' HILLED PROTECTION T2.0, L=10 INV 72.0 RIM 75.0 RI	T28 T28 T25 T28 T49 T49 T47 T49 T47 T49 T47 T49 T47 T49 T49
TION TION TO THE		72.8 CA ABAN GS WATLABAND 73.0 SAN HC 154 T54 T54 T54 T54 T54 T54 T54 T54 T54 T
PARCEL 2 SHOWN AS TAX 107 77.07-II-35.2 ON TAMAP OR THEN OR THEN	RL CO RIM 74.52 RIL CO RIM 75.53 RIL CO RIM 74.52 RIL CO	TREE TO BE PROTECTED TO ST NOT-1-34 NOT- CALOMINO (LOT I, FM 2354) TO ST RECAN (LOT 2, FM 2354)
N45°01'50'W T7.07-1-29 N/F BRAUNFELD (LOT 6, FM 2354)	77.07-1-31 N/F MURTHA (LOT 4, FM 2354)	SAN MH RIM 72.II
	N/f- yA55KY (LOT 5, fM 2354)	OLD MILL (50' R.O.W.)

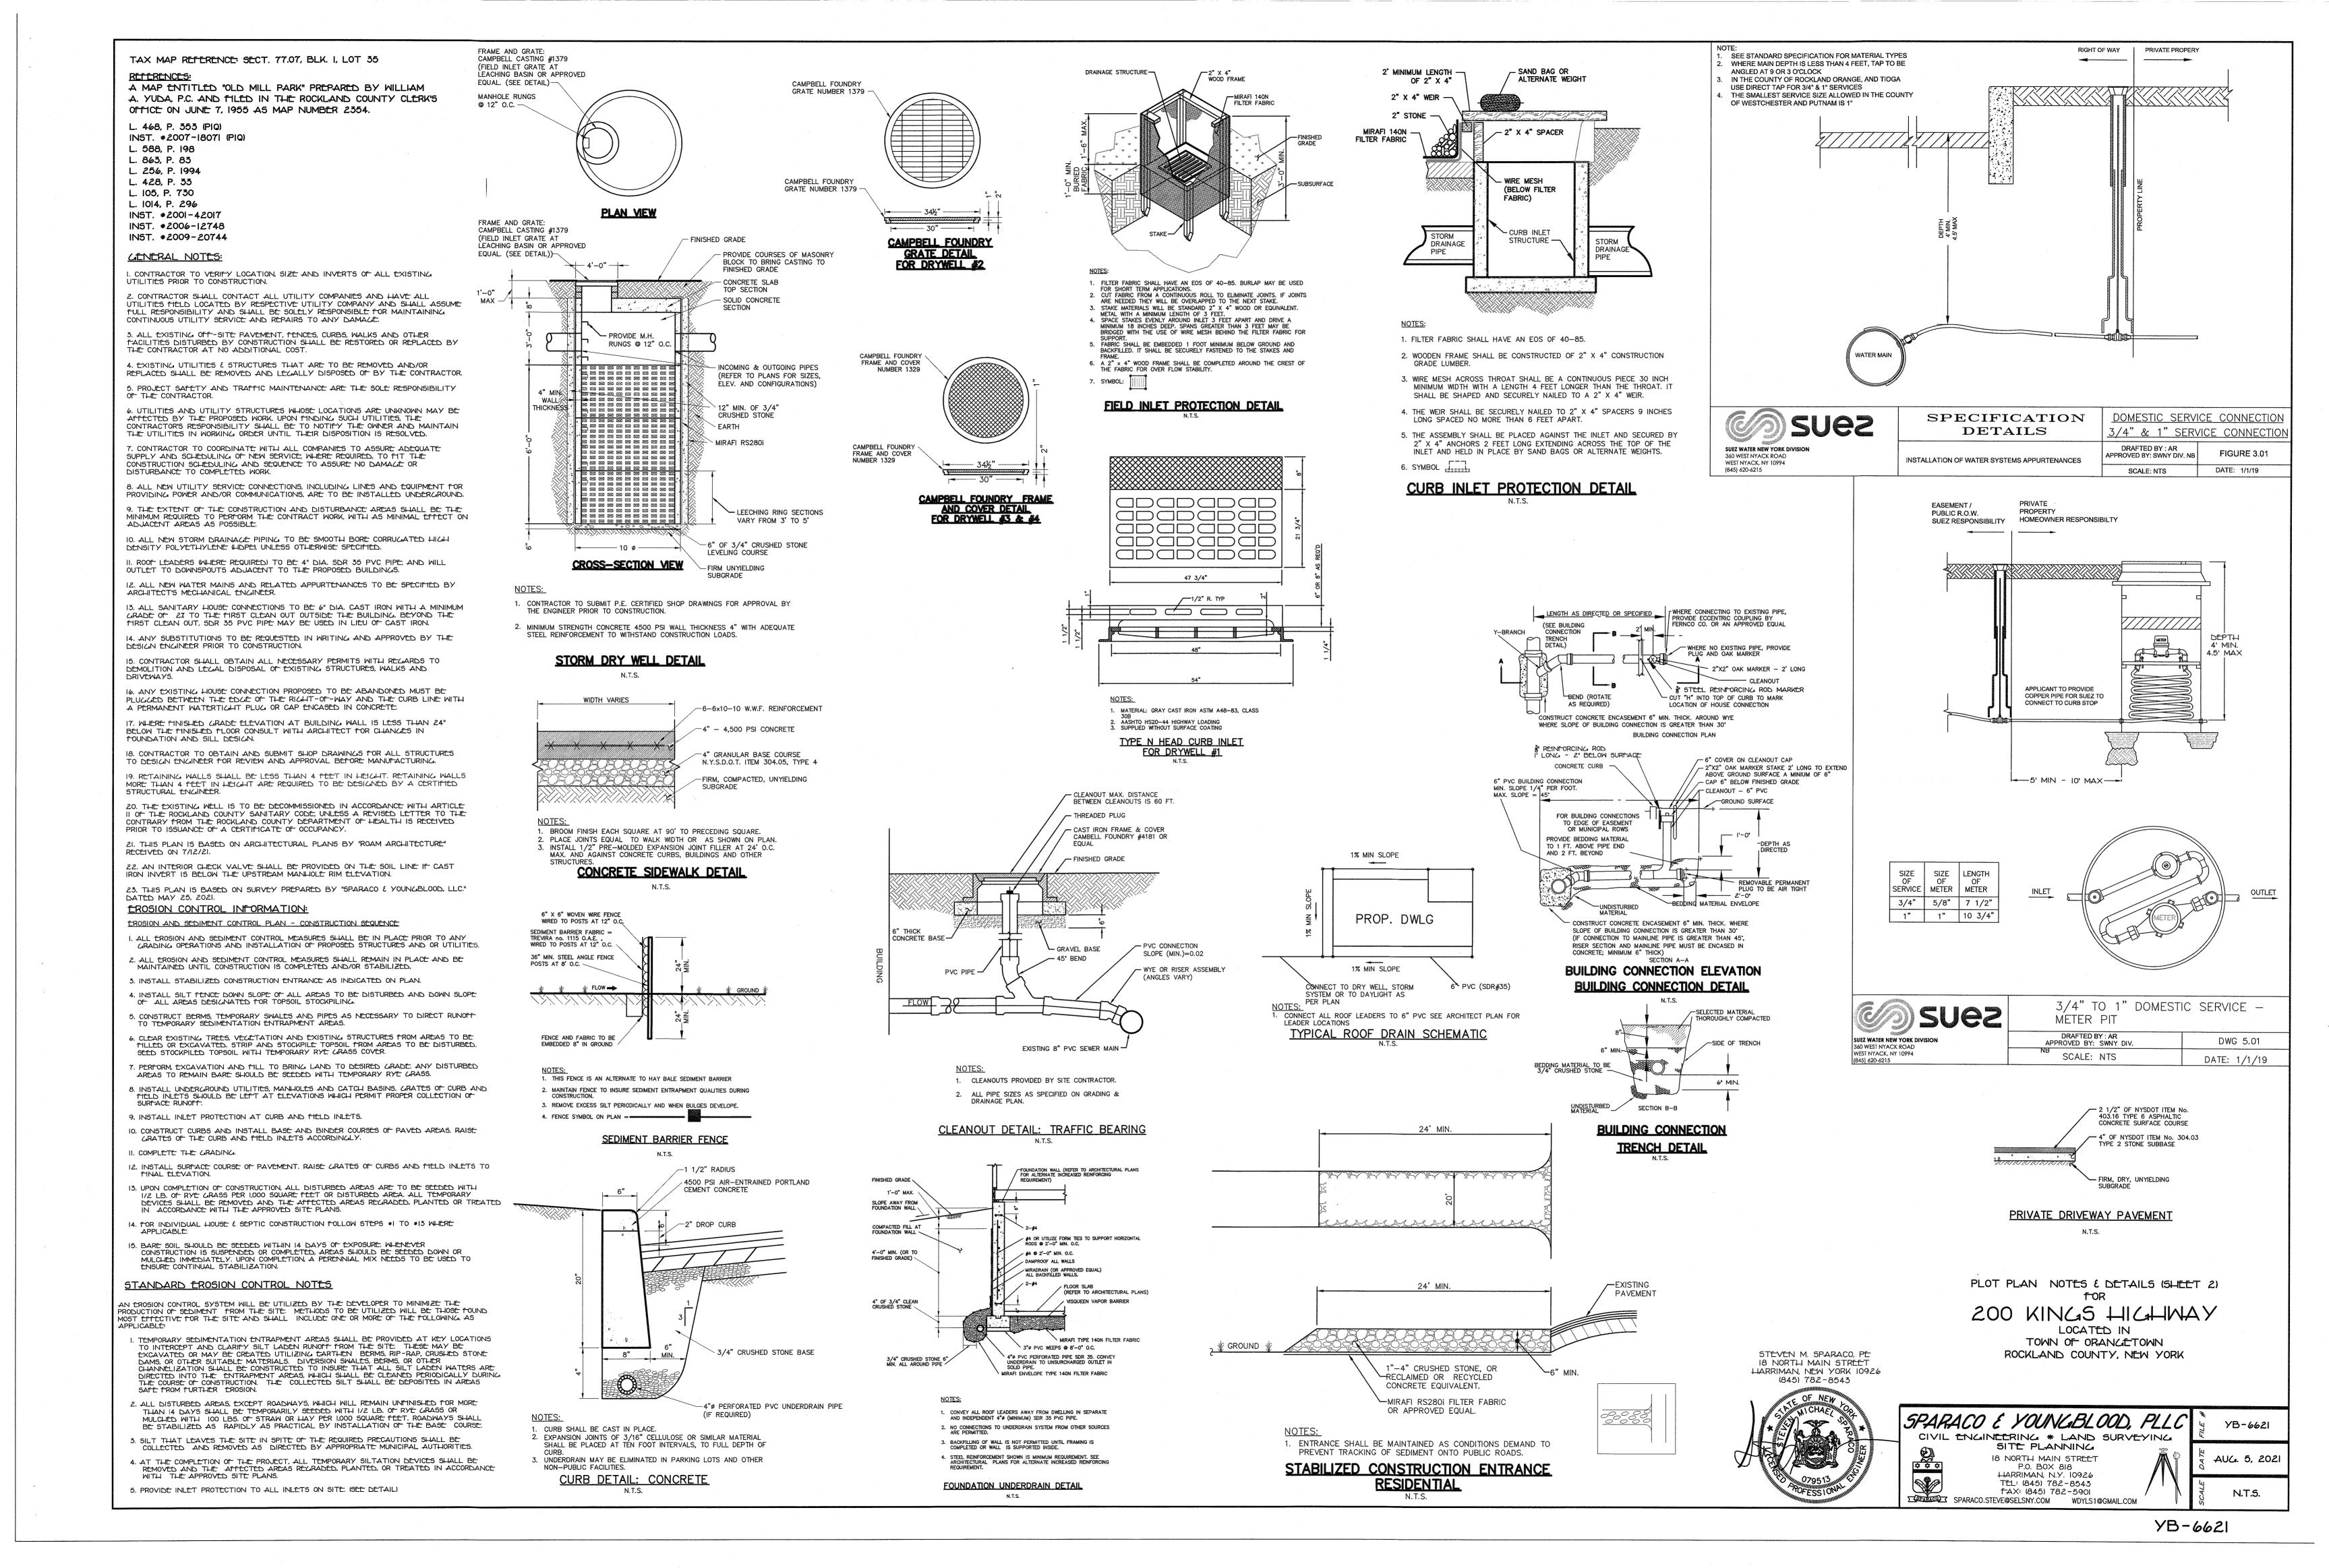


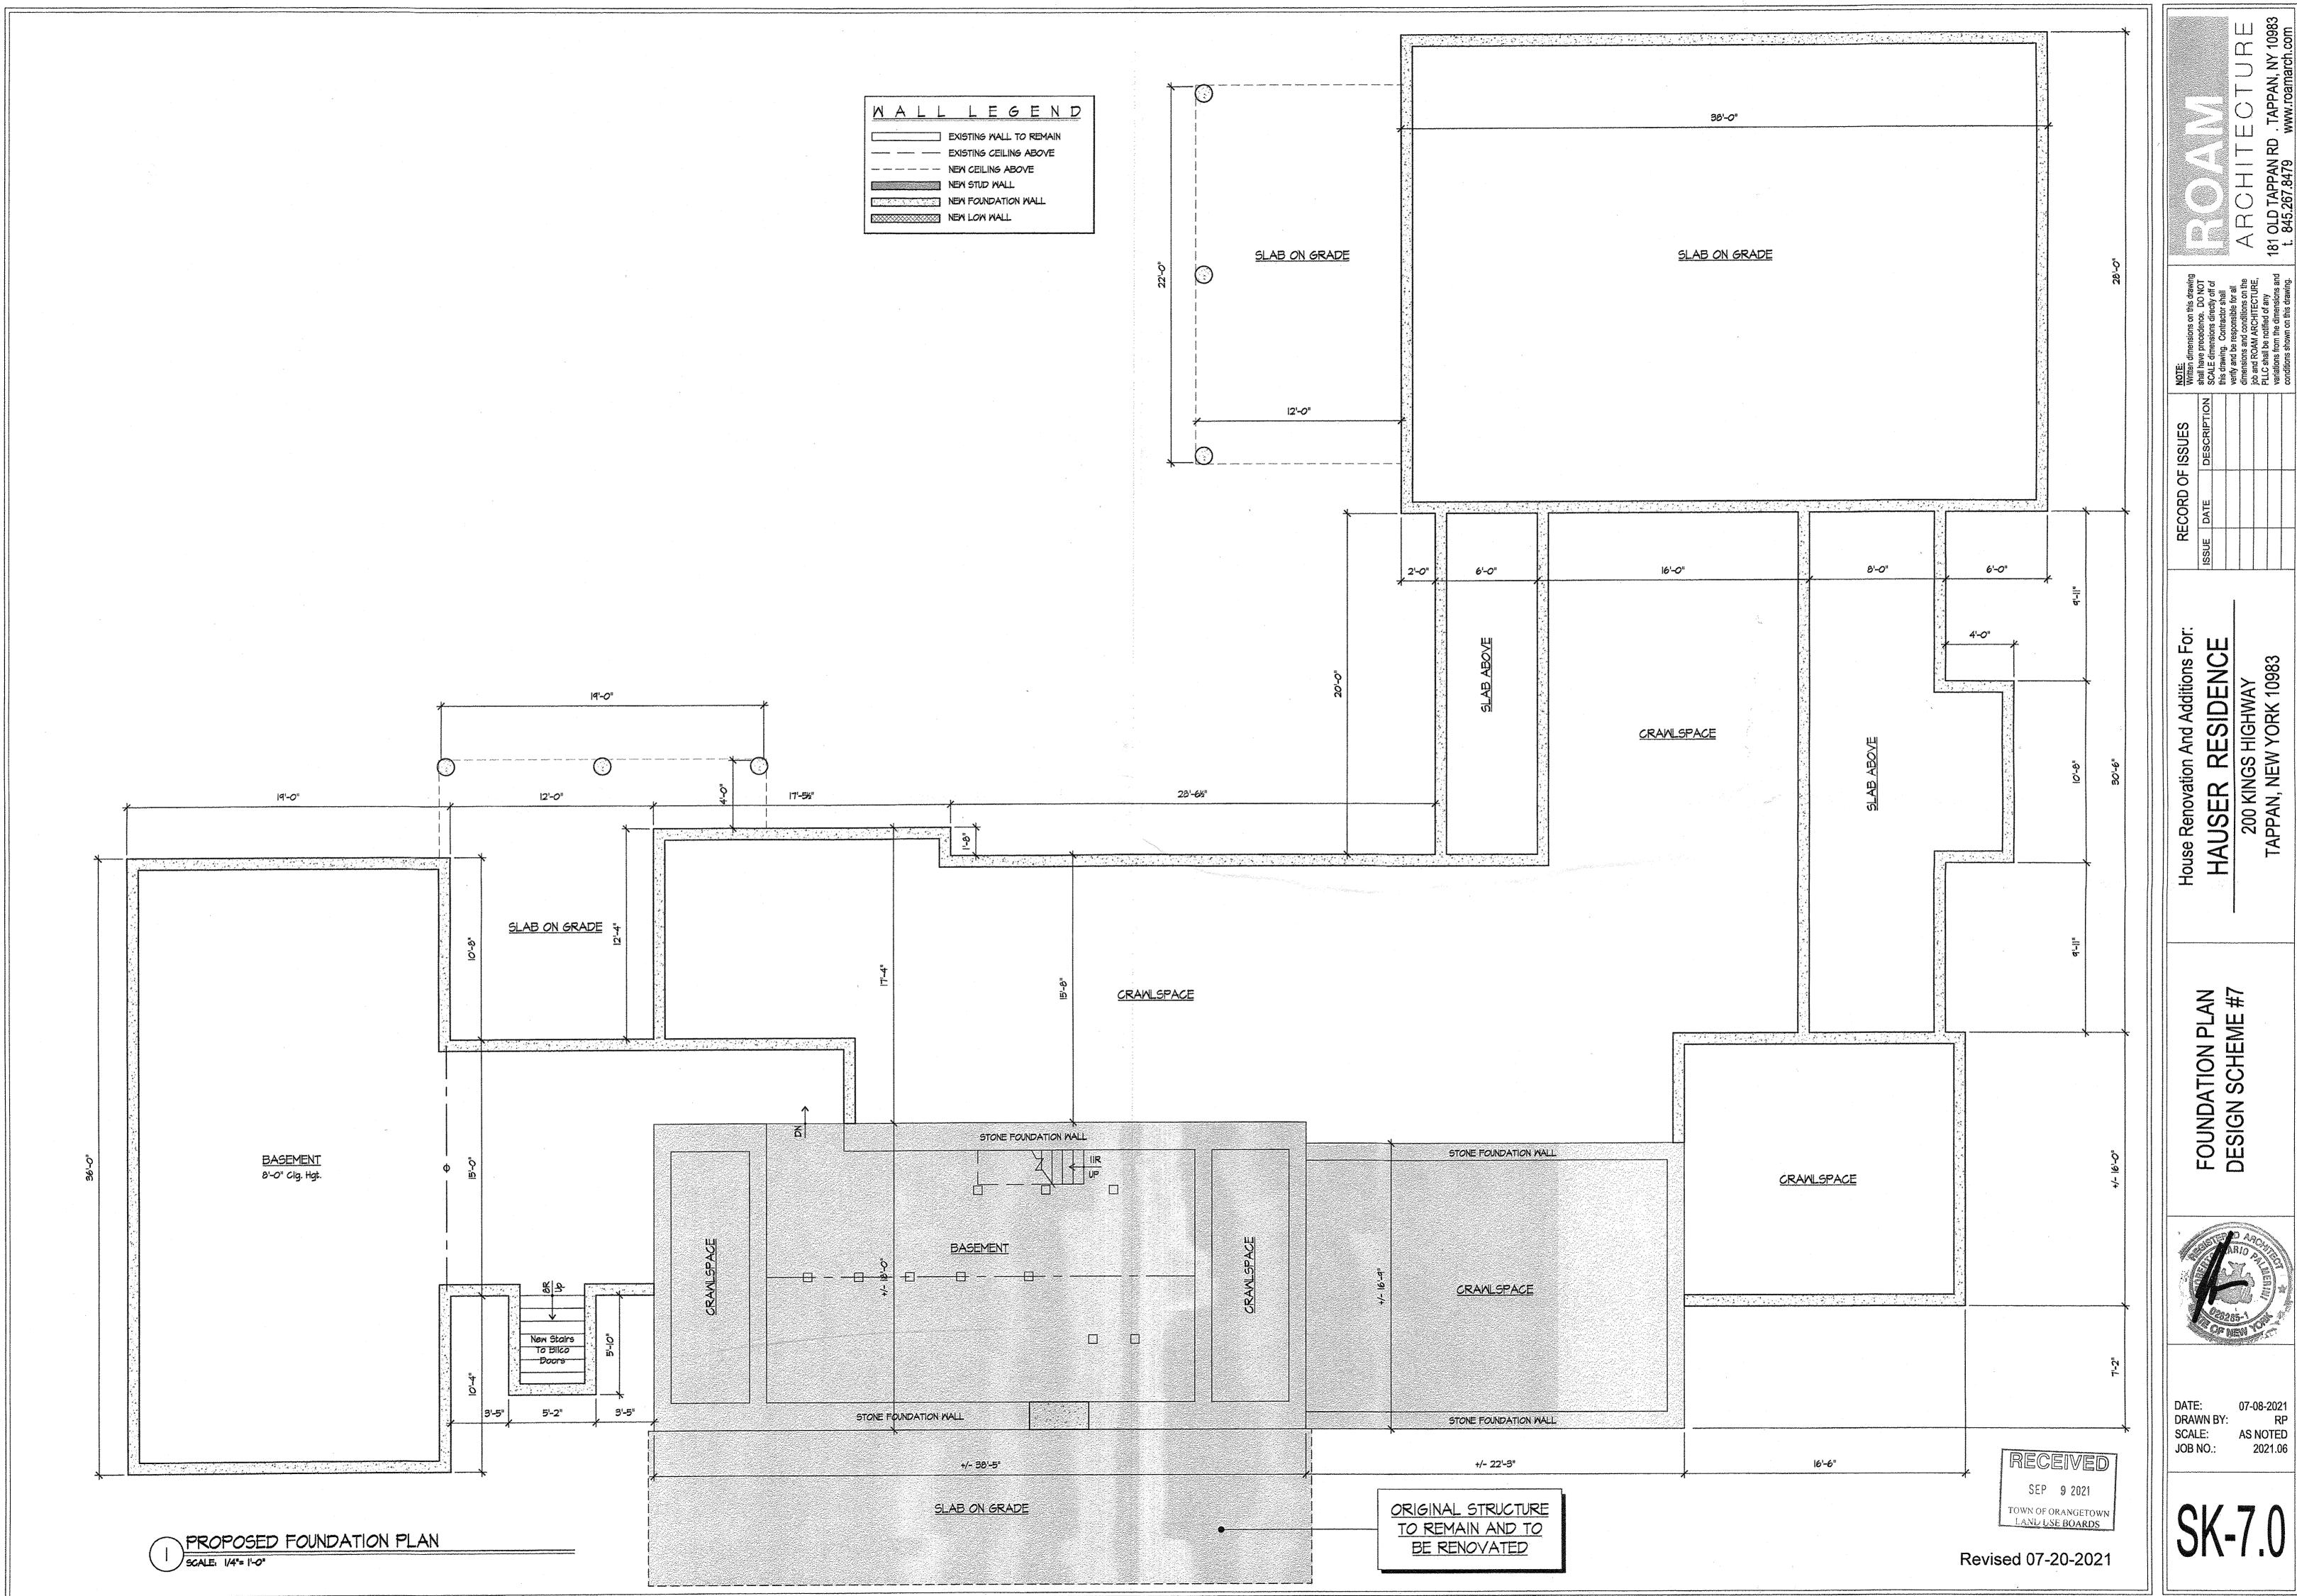

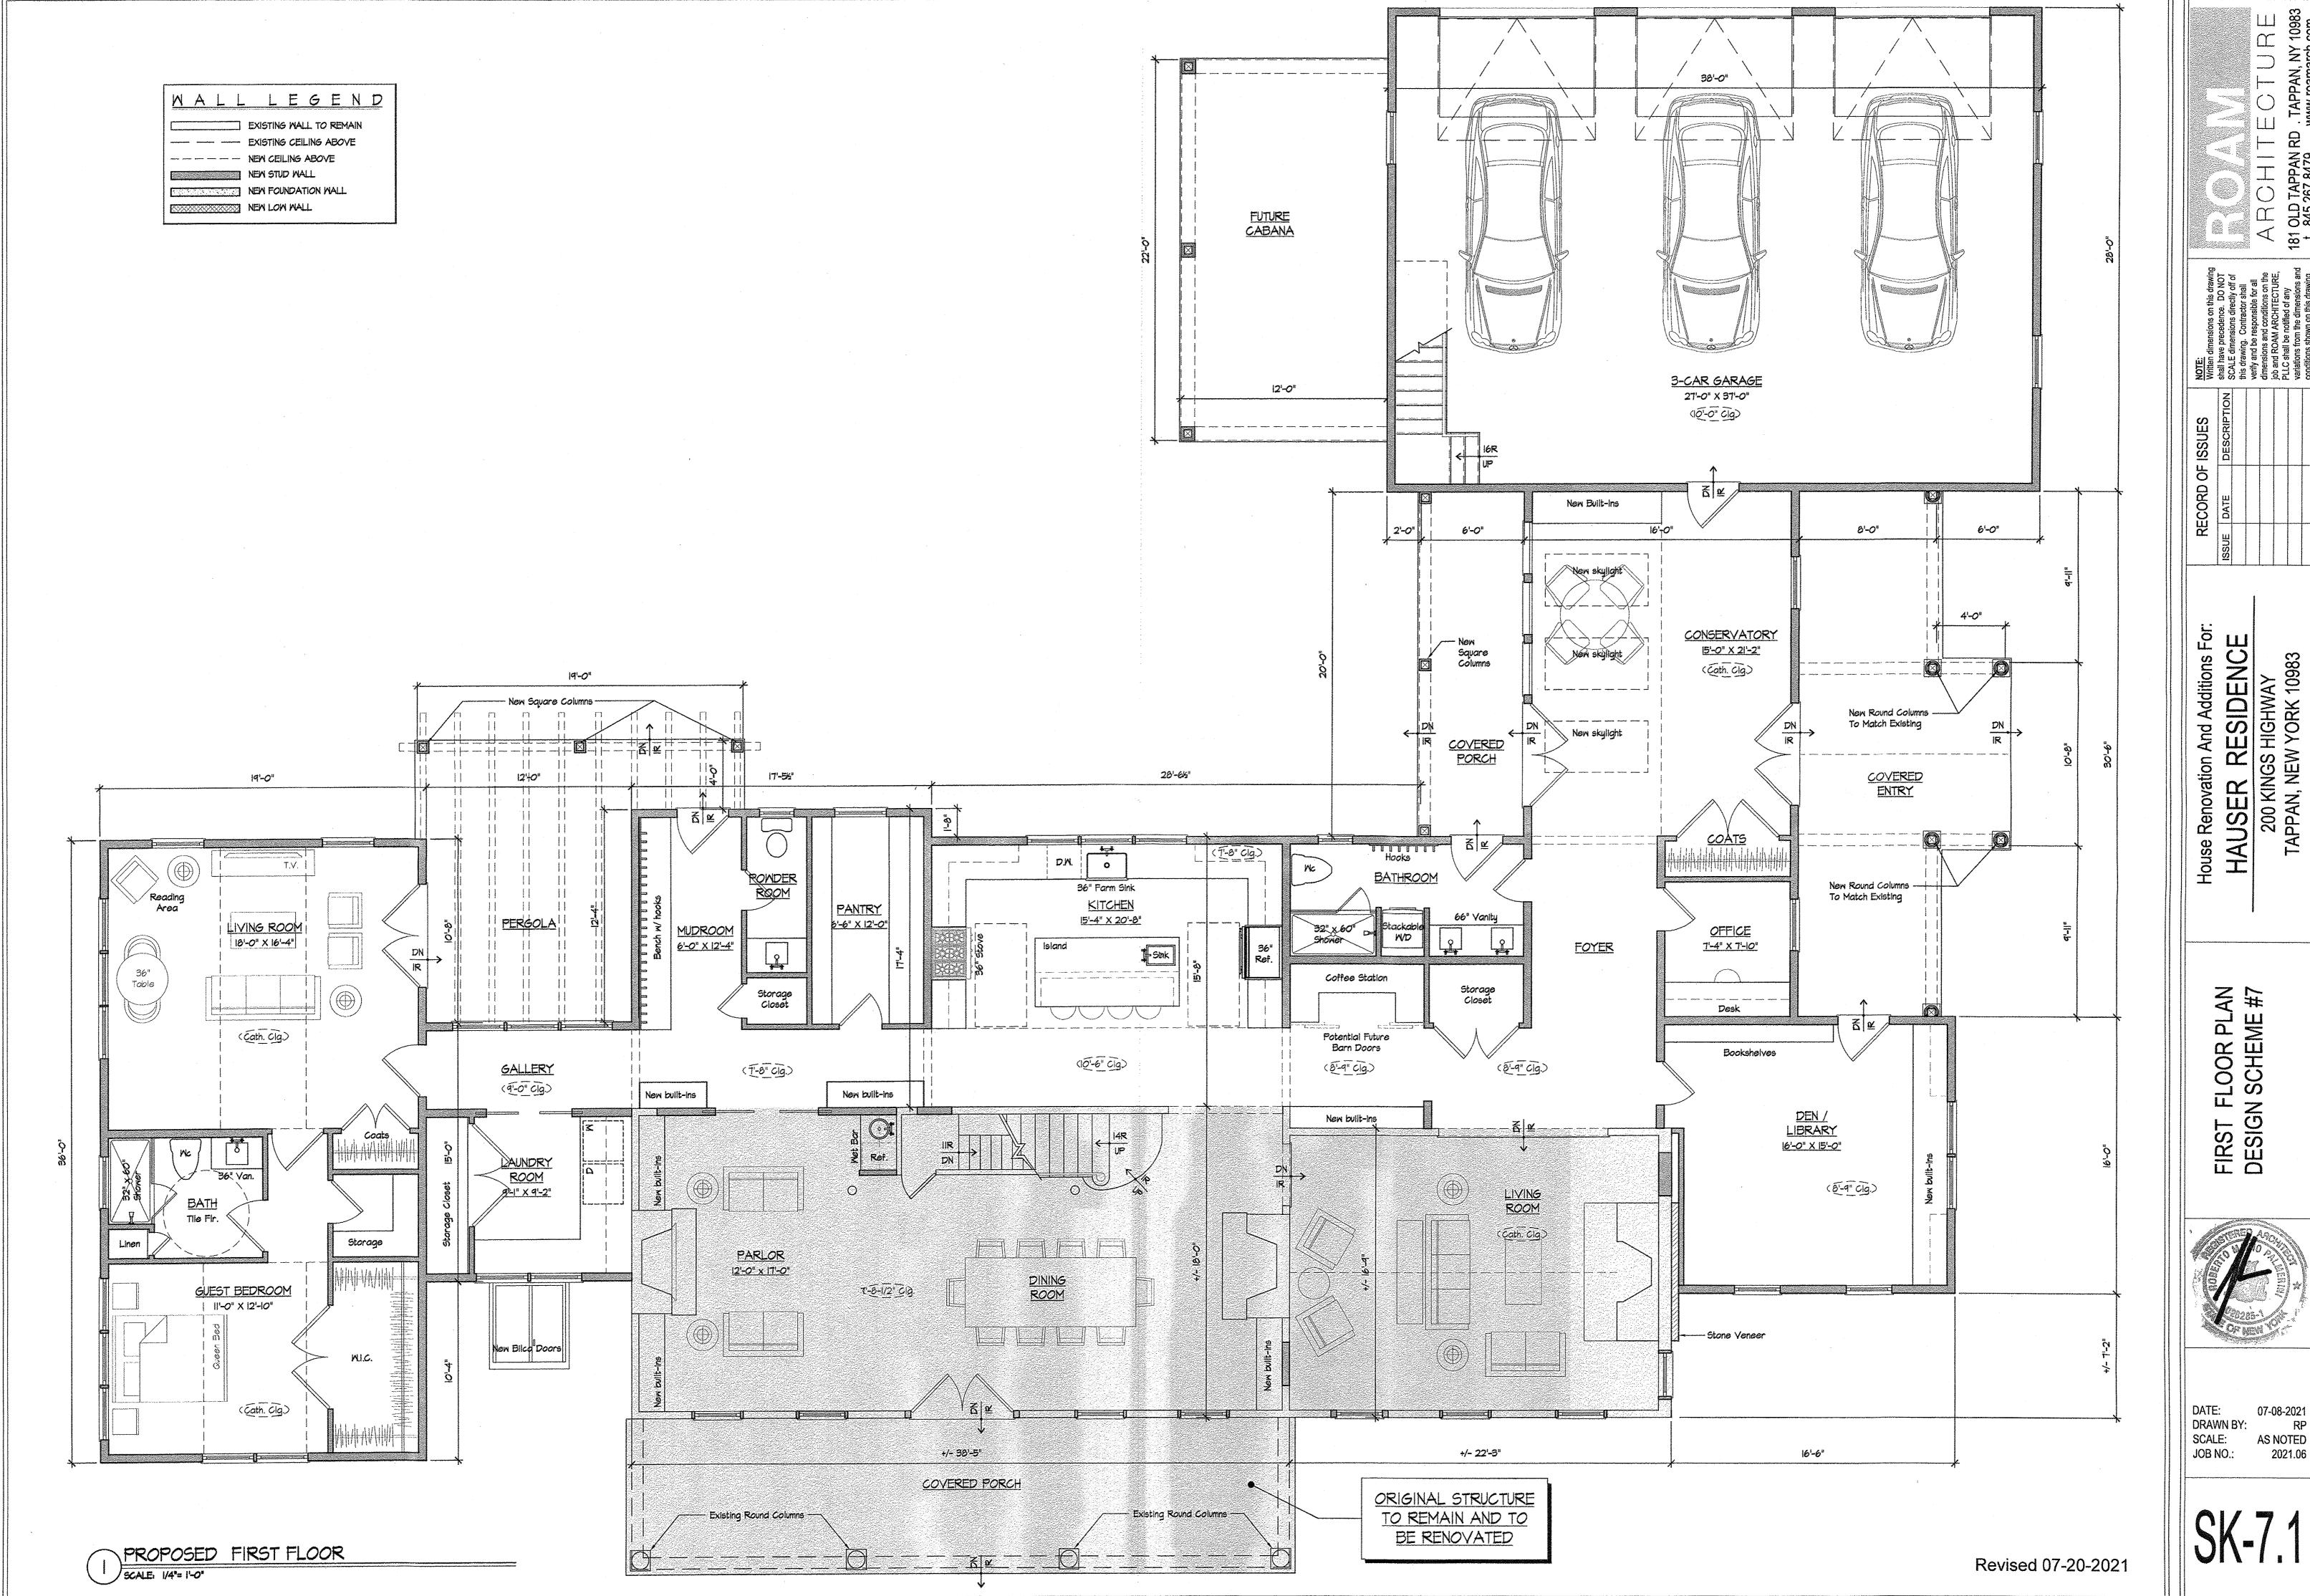

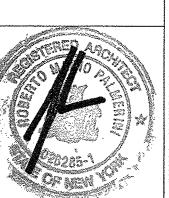

07-08-2021 RP AS NOTED 2021.06

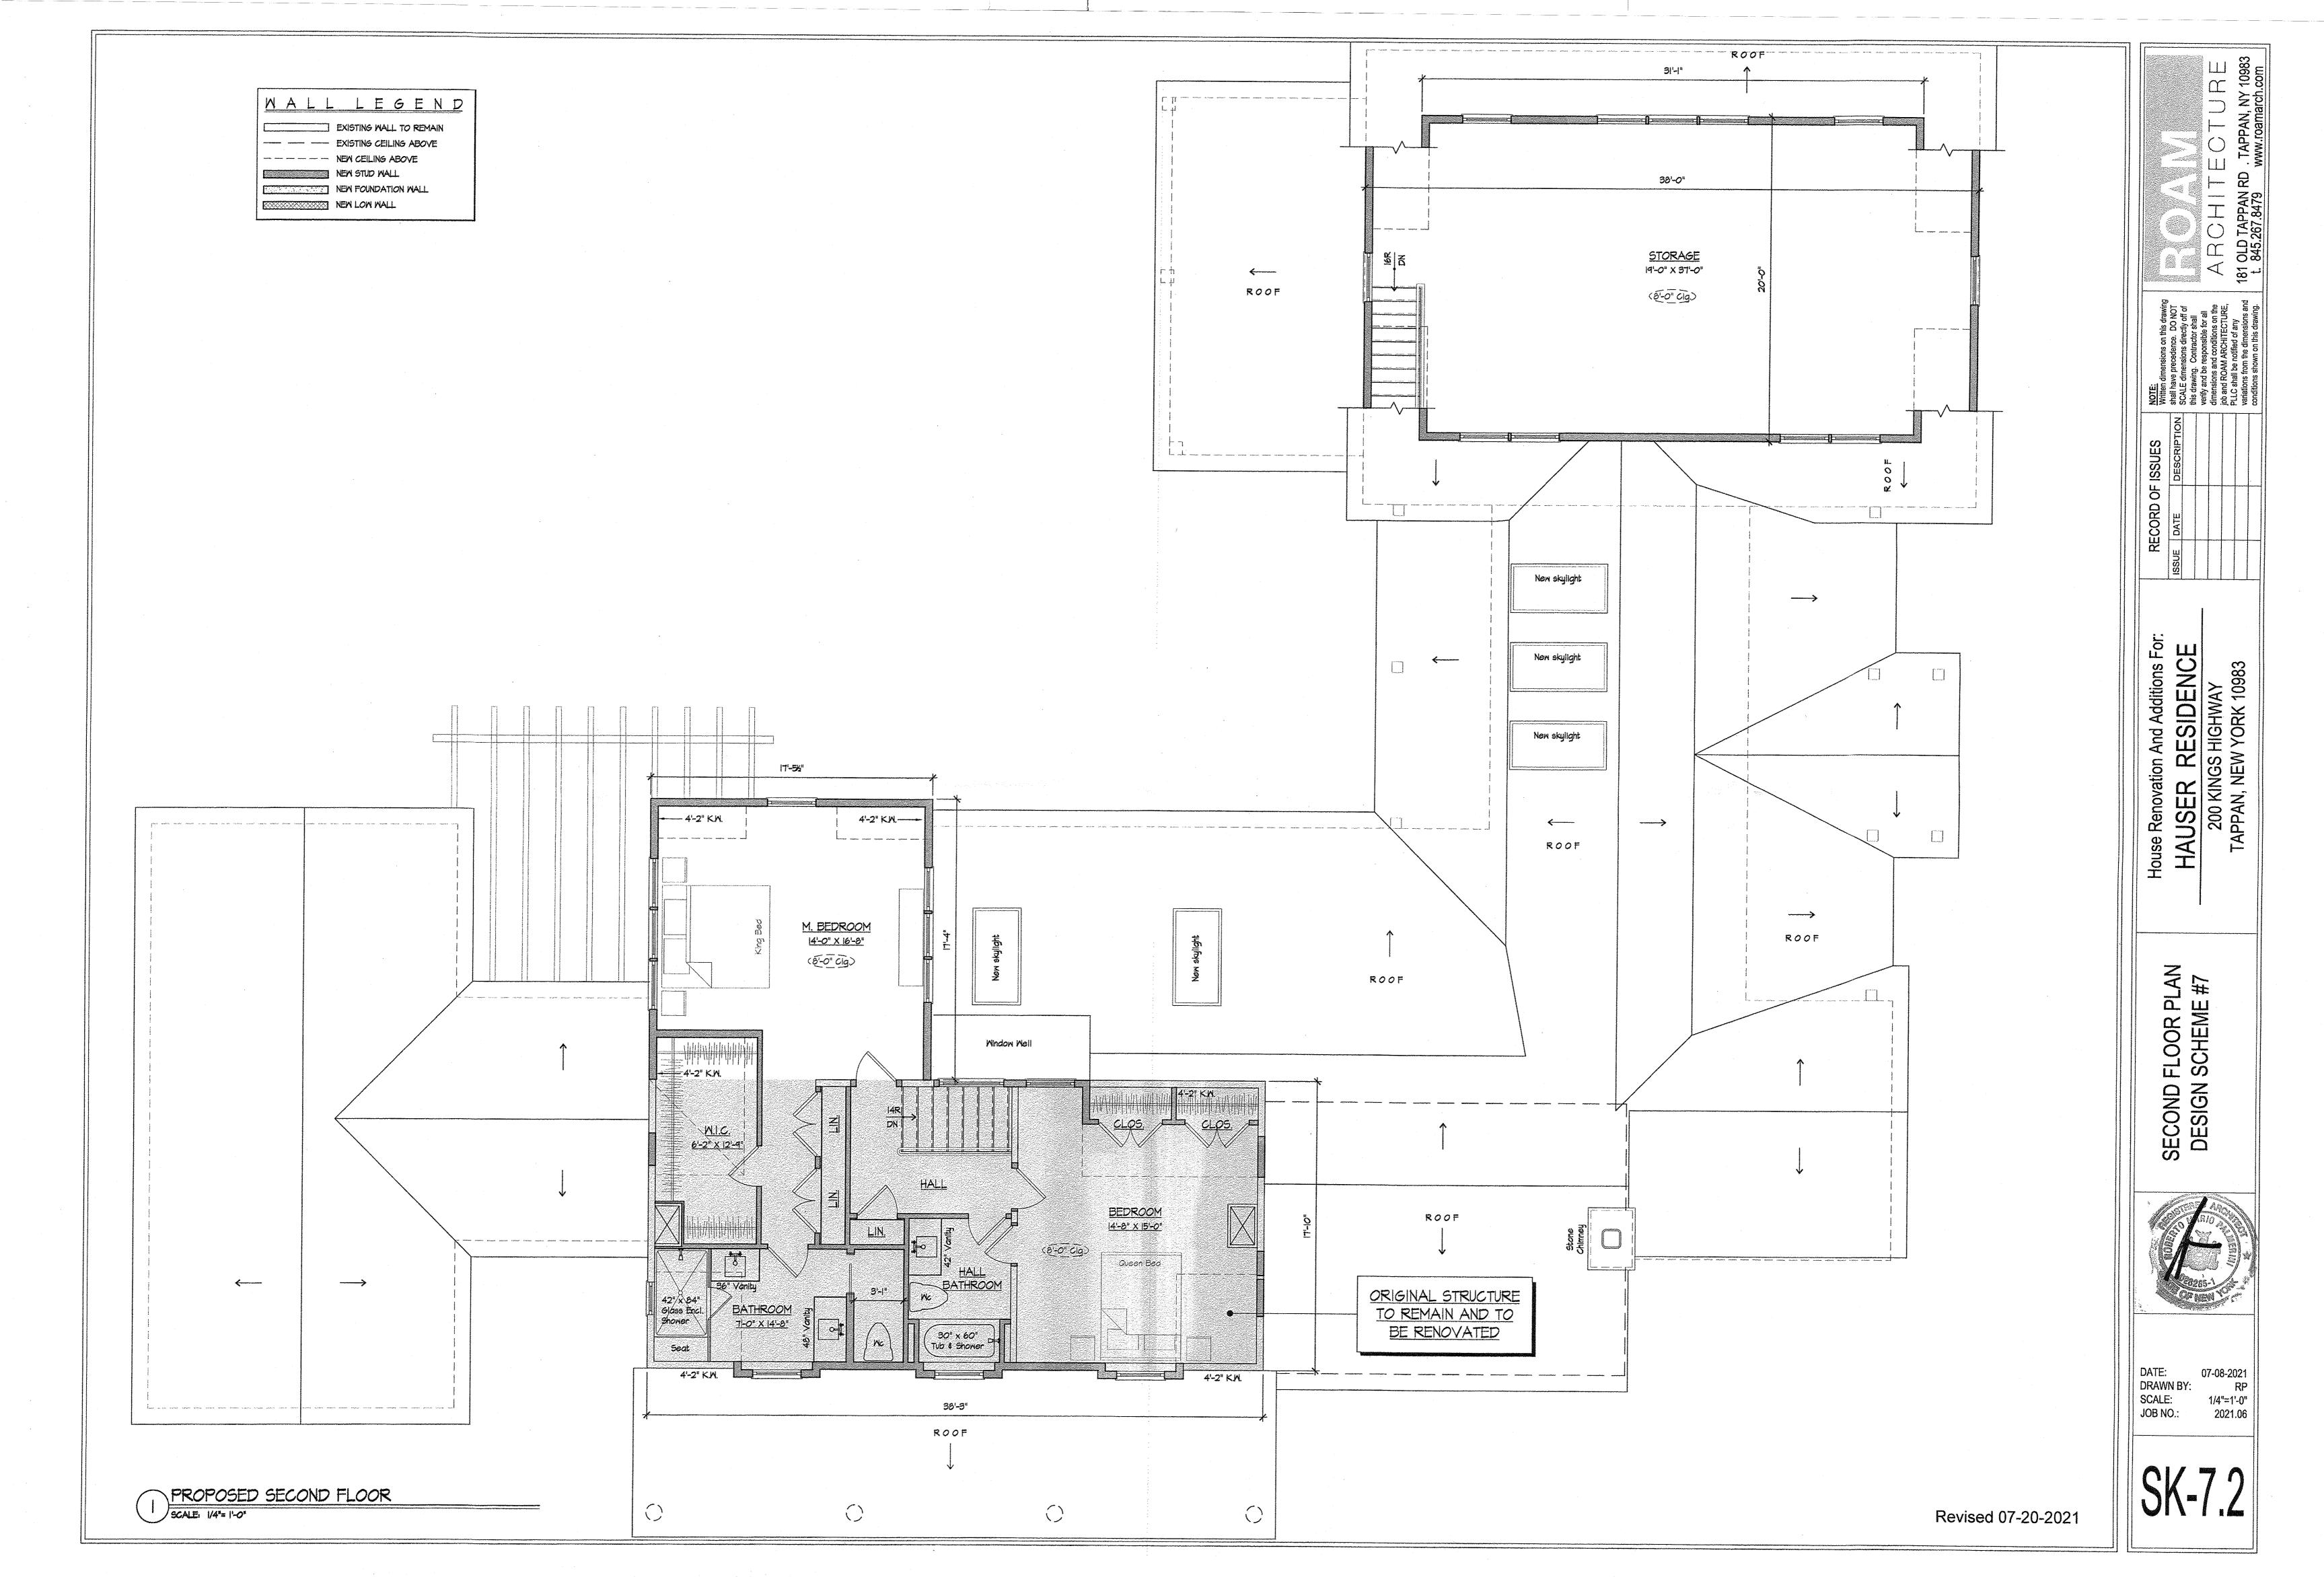



Existing Round Columns —

New Beveled Siding (7" Exposure)

New Beveled Siding

(1" Exposure)

New Blico Door

EXTERIOR ELEVATION - LEFT SIDE

SOUTH FACADE

ist Floor


20285-1 AS

DATE: 07-08-2021 DRAWN BY: RP SCALE: 1/4"=1'-0" JOB NO.: 2021.06

SK-7.3

New Stone Veneer With Drip Cap

— New Round Columns
To Match Existing

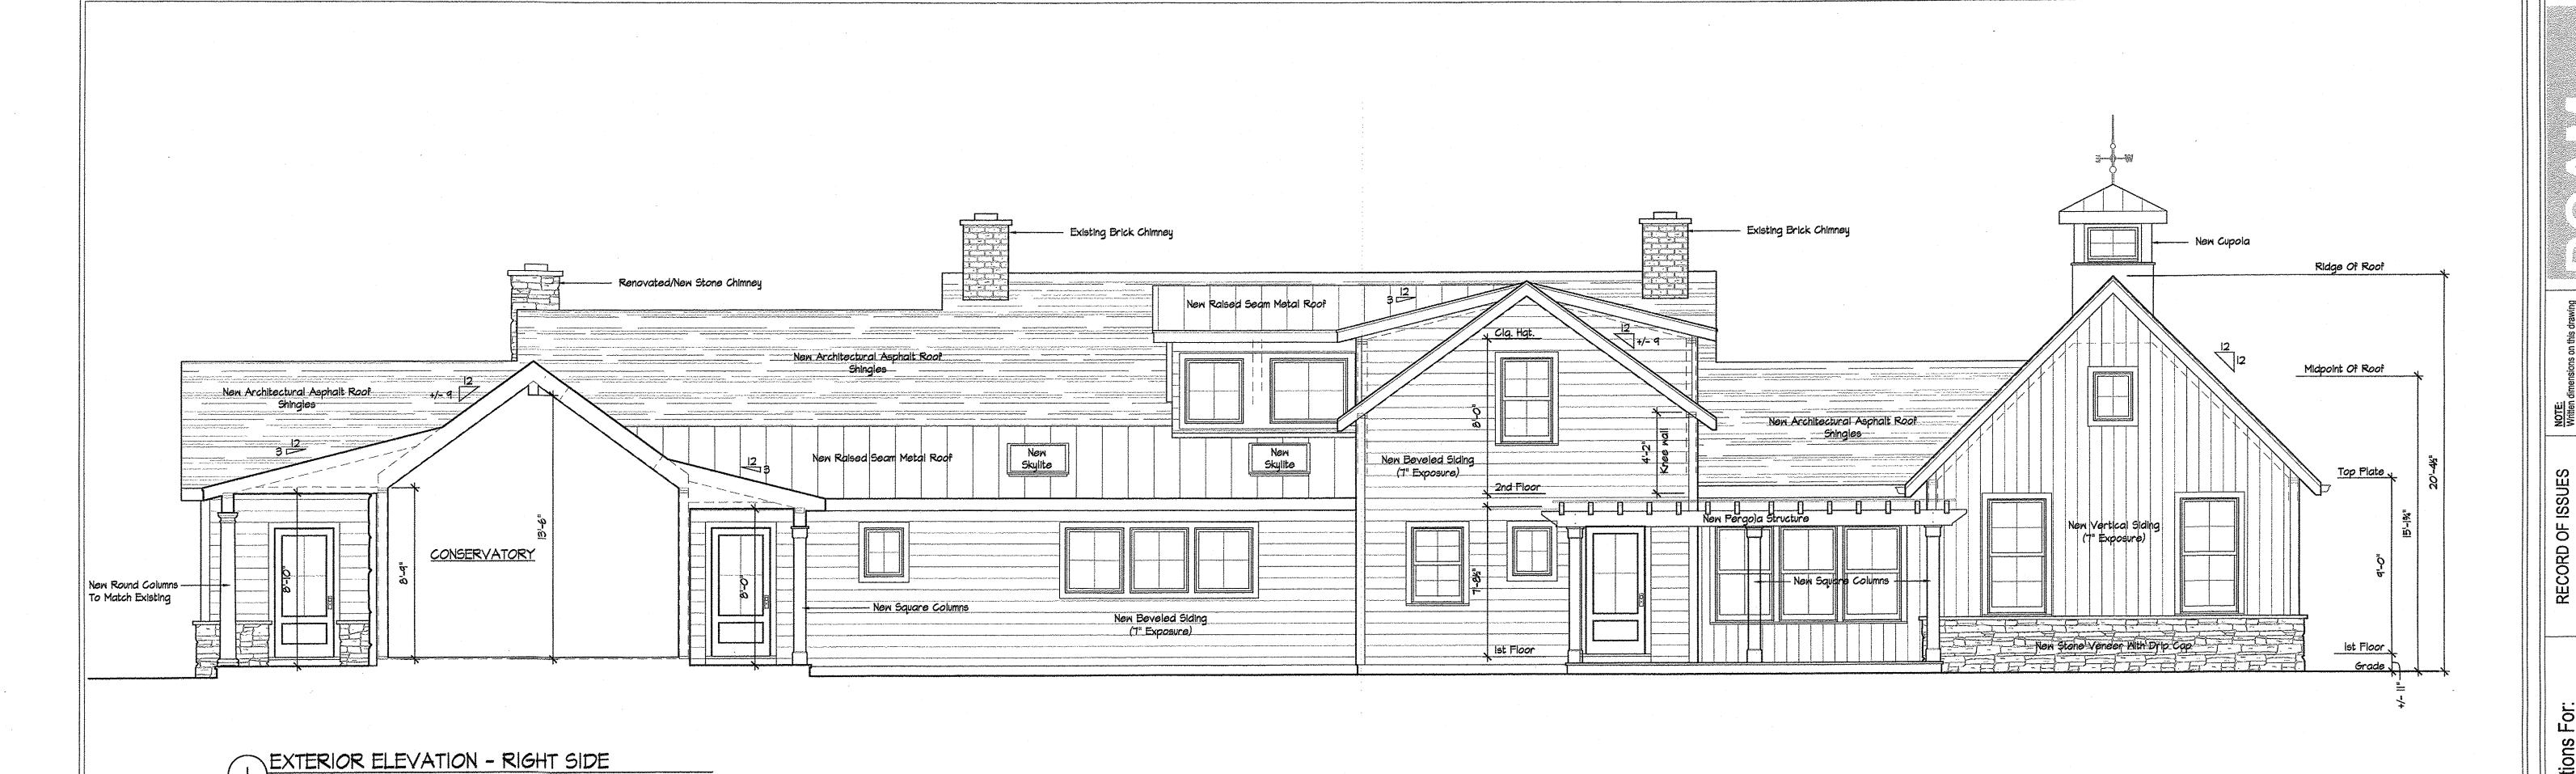

New Cupola Ridge Of Roof New Cupola -3 12 Top Plate/Clg. Hgt. Midpoint Of Roof New Architectural Asphalt Roof Shingles New Architectural Asphalt Roof New Raised Seam Metal Roof Top Plate - Existing Round Columns New Vertical Siding (7" Exposure)

> 2 EXTERIOR ELEVATION - REAR SCALE: 1/4"= 1'-0" WEST FACADE

NORTH FACADE

SCALE: 1/4"= 1'-0"


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ISSUES RECORD (

tion And Additions For:
RESIDENCE

House Renovation And Additions For HAUSER RESIDENCE 200 KINGS HIGHWAY TAPPAN, NEW YORK 10983

EXTERIOR ELEVATIONS DESIGN SCHEME #7

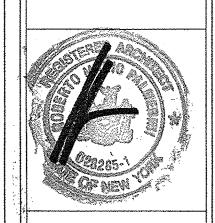


07-08-2021 RP DRAWN BY: SCALE: 1/4"=1'-0" JOB NO.: 2021.06



enovation And Additions For: SER RESIDENCE SER House R HAU

EXTERIOR ELEVATIONS DESIGN SCHEME #7

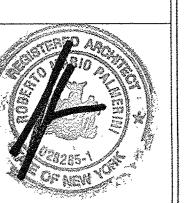

07-08-2021 DRAWN BY: 1/4"=1'-0" 2021.06